STRATFORD WATERFRONT GATHERING & EVENT SPACE

TOWN OF STRATFORD, PEI

DRAWING LIST:

<u>CIVIL</u>

CO - LOCATION PLAN

C1 - SITE PLAN & PROFILE #1 (STATIONS 0+000 TO 0+160)

C2 - SITE PLAN & PROFILE #2 (STATIONS 0+160 TO 0+320)

C3 - SITE PLAN & PROFILE #3 (STATIONS 0+320 TO 0+420)

C4 - PROFILE #4 (STATIONS 0+000 TO 0+060)

C5 - BOARDWALK SECTIONS & DETAILS

C6 - LOOKOUT SECTIONS & DETAILS

C7 - STATUE PLATFORM PLAN & DETAILS

C8 - TYPICAL SECTIONS, DETAILS, & NOTES

C9 - EROSION CONTROL PLAN

ELECTRICAL

E1 — ELECTRICAL SPECIFICATIONS, LEGEND & DETAILS

E2 — ELECTRICAL SITE PLAN, TRENCHES & DETAILS

E3 - STATUE & LOOKOUT DECK PLANS & DETAILS

E4 - SERVICE ENTRANCE DETAIL, SCHEMATICS & SCHEDULES





Town of Stratford

Project Title
Stratford Waterfront
Gathering & Event Space

Sheet Title

Location Plan

No. Description

Date

Date: 2023-07-25


Drn By: MK, EIT/ SPB


Chk By: NL, P.Eng

Project Number:

221122


Drawing Number:

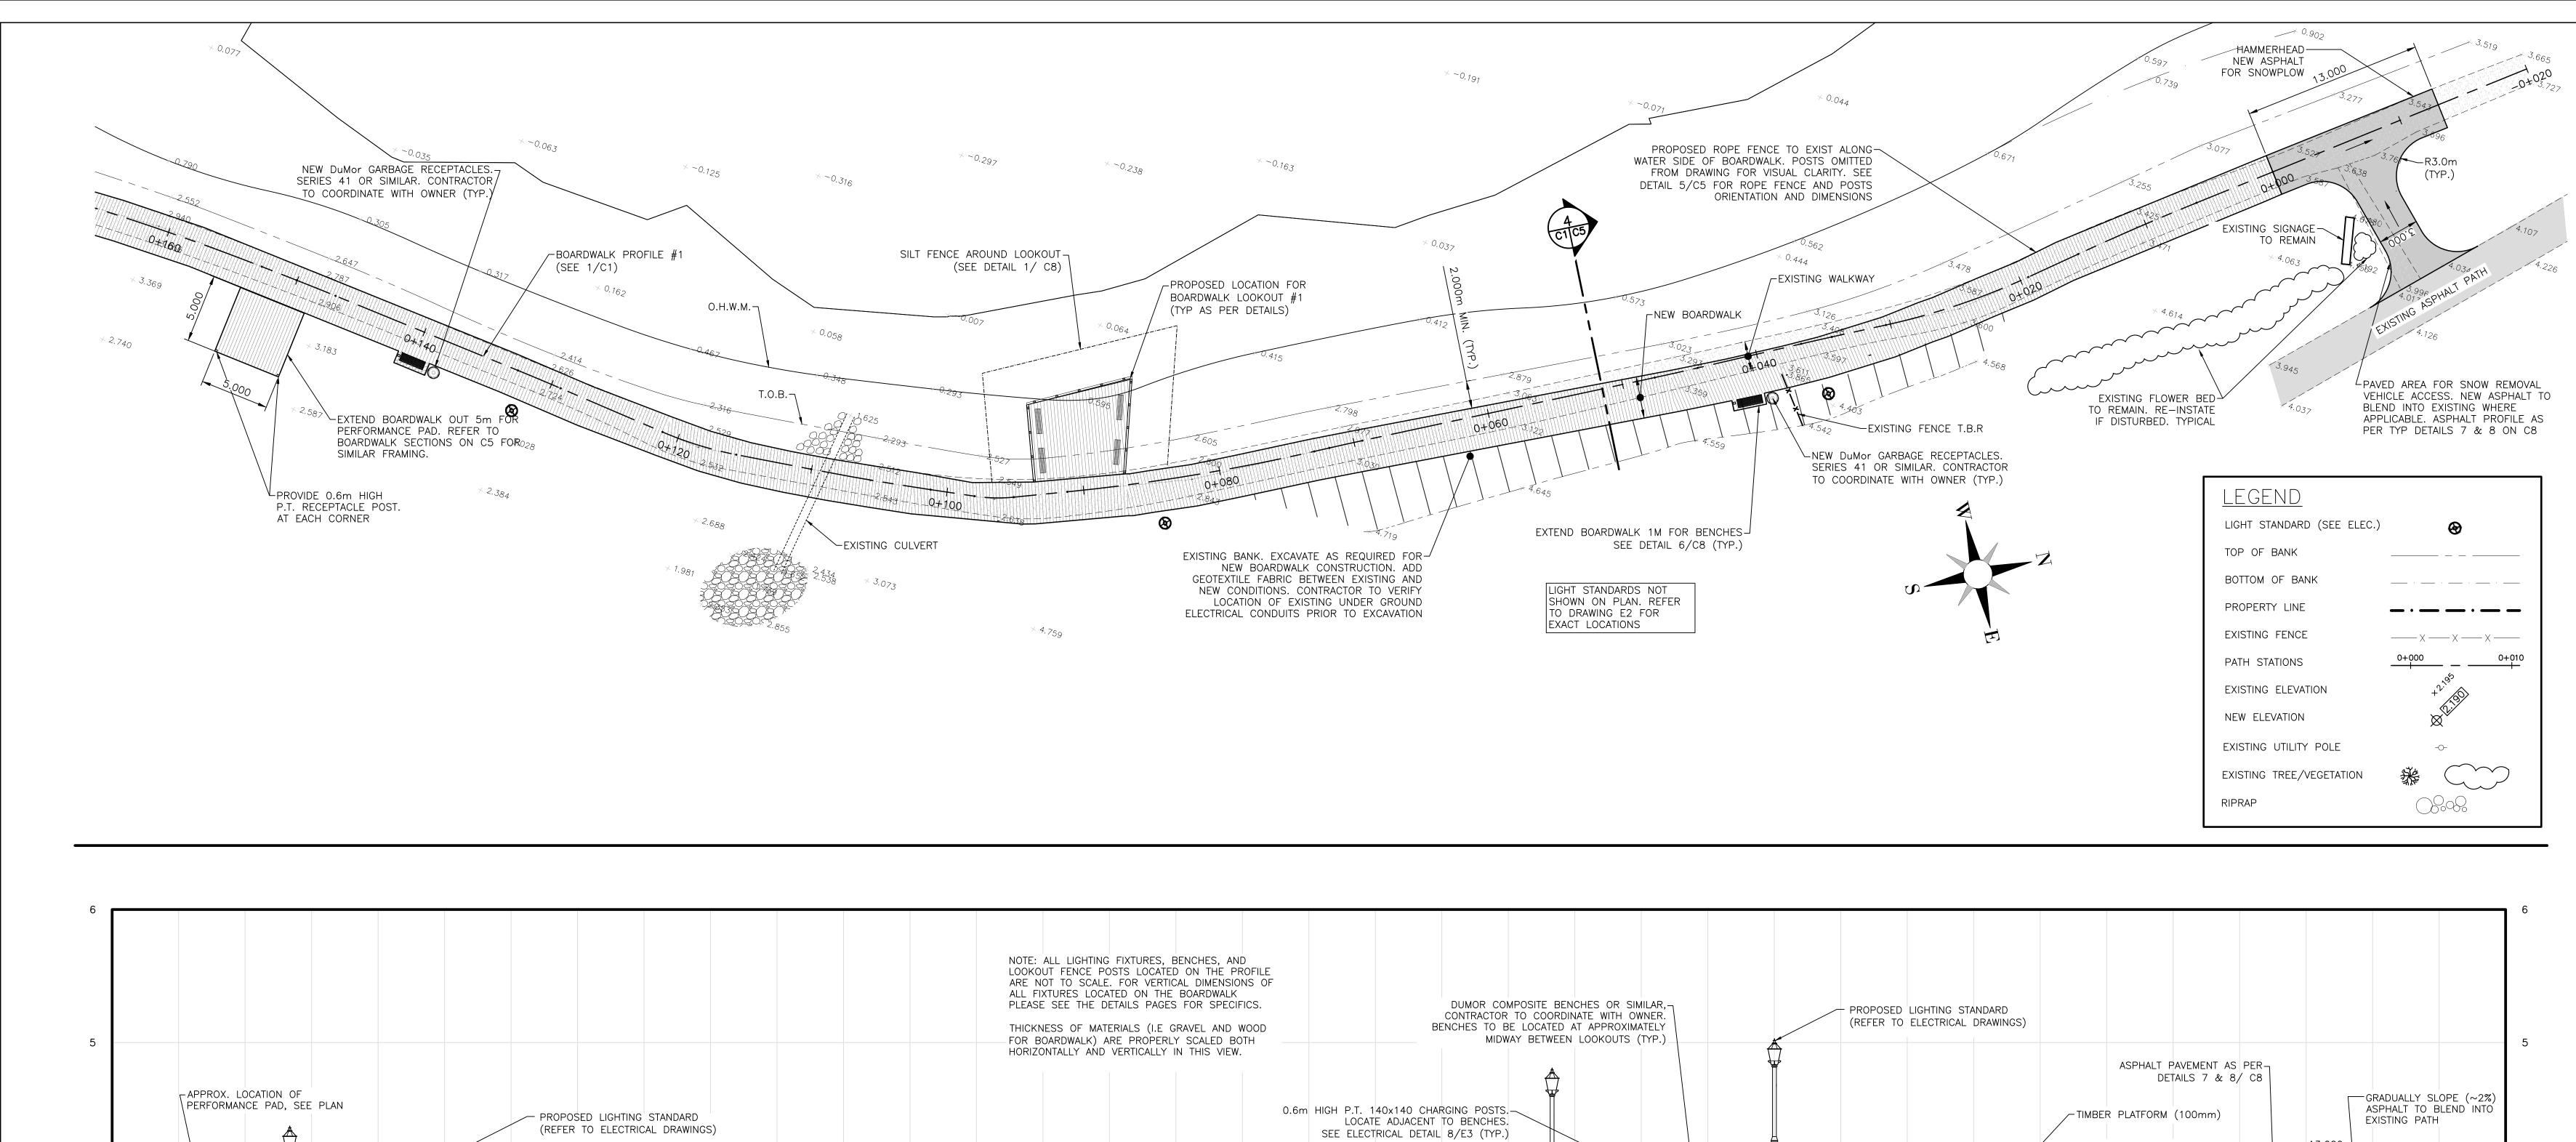

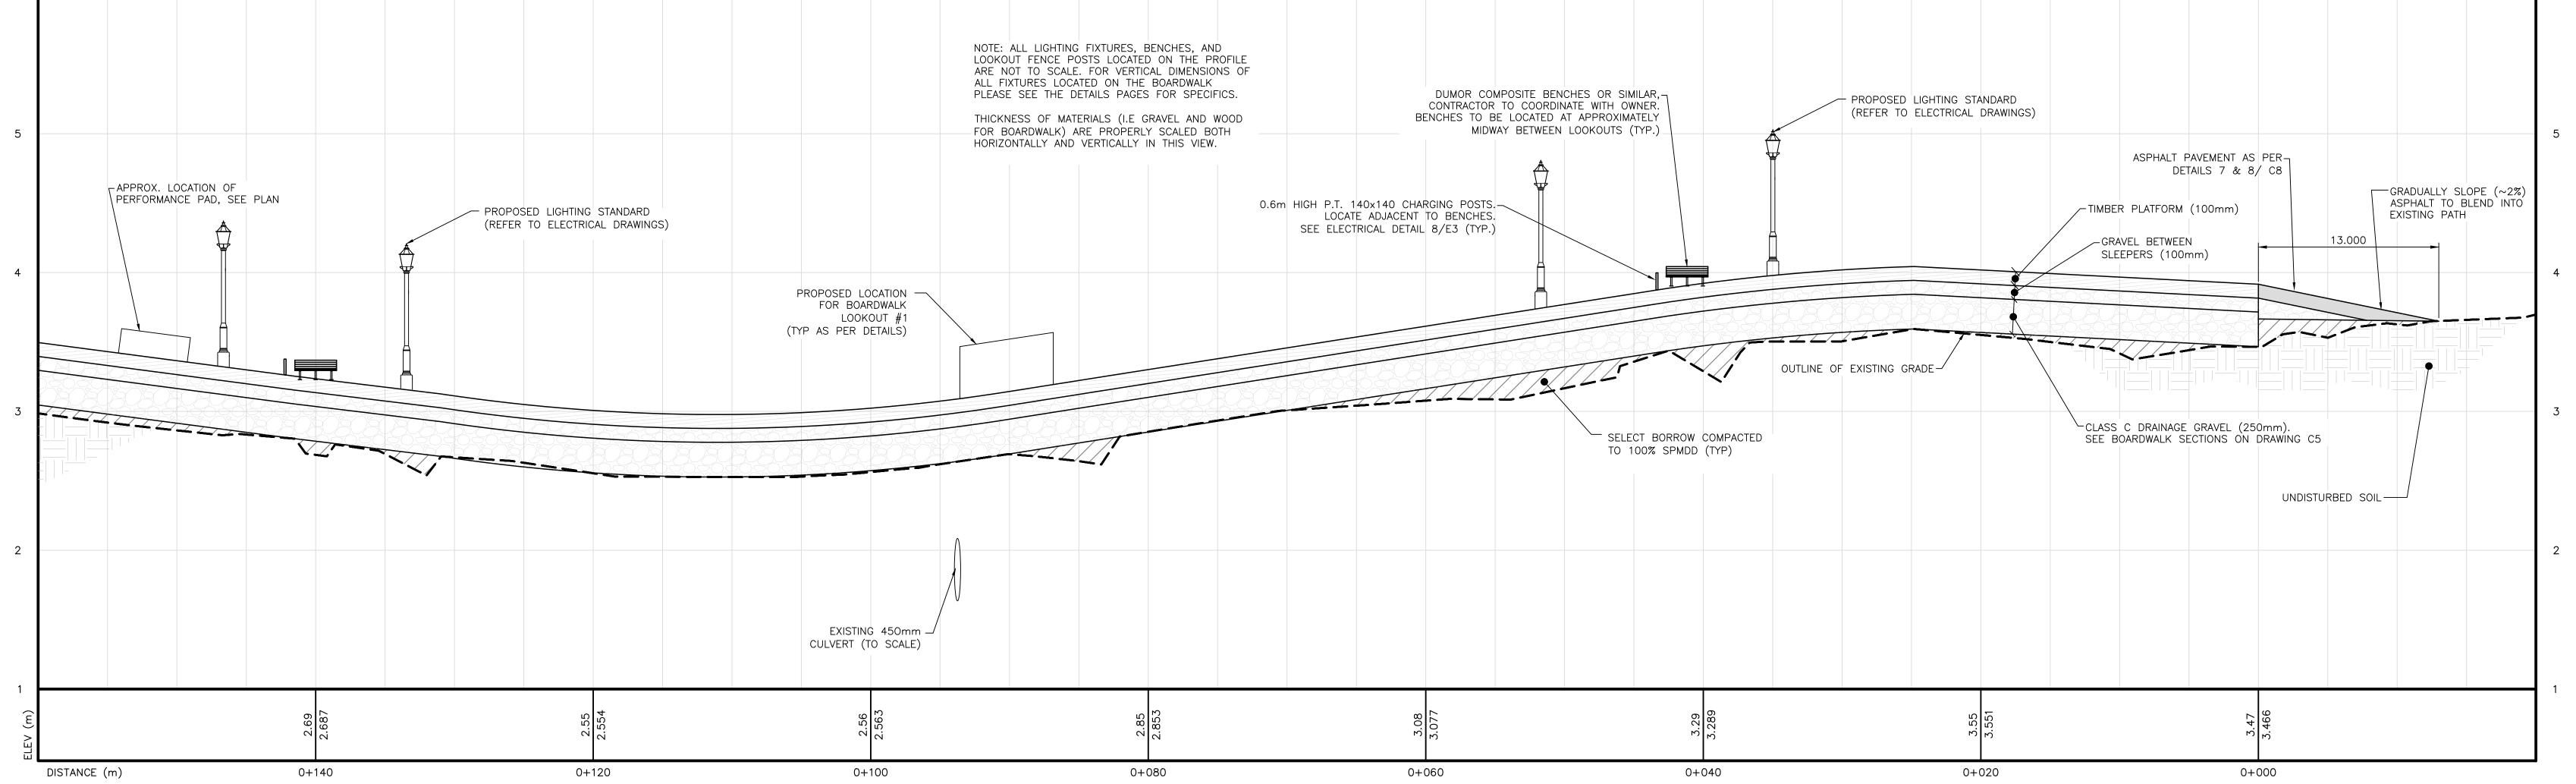

PROFILE: BOARDWALK ALIGNMENT #1

Suite 201, 85 Fitzroy Street
Charlottetown, PEI, Canada, C1A 1R6
Phone (902) 368-2300
www.colesassociates.com

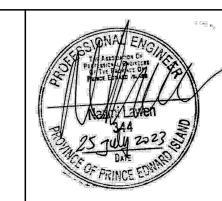

Town of Stratford

Stratford Waterfront
Gathering & Event Space

Site Plan & Profile Station 0+000 to 0+160

Sheet Title

No. Description

Date

Date: 2023-07-25

Drn By: MK, EIT/ SPB


Chk By: NL, P.Eng


Project Number:

221122

Drawing Number:

C.1

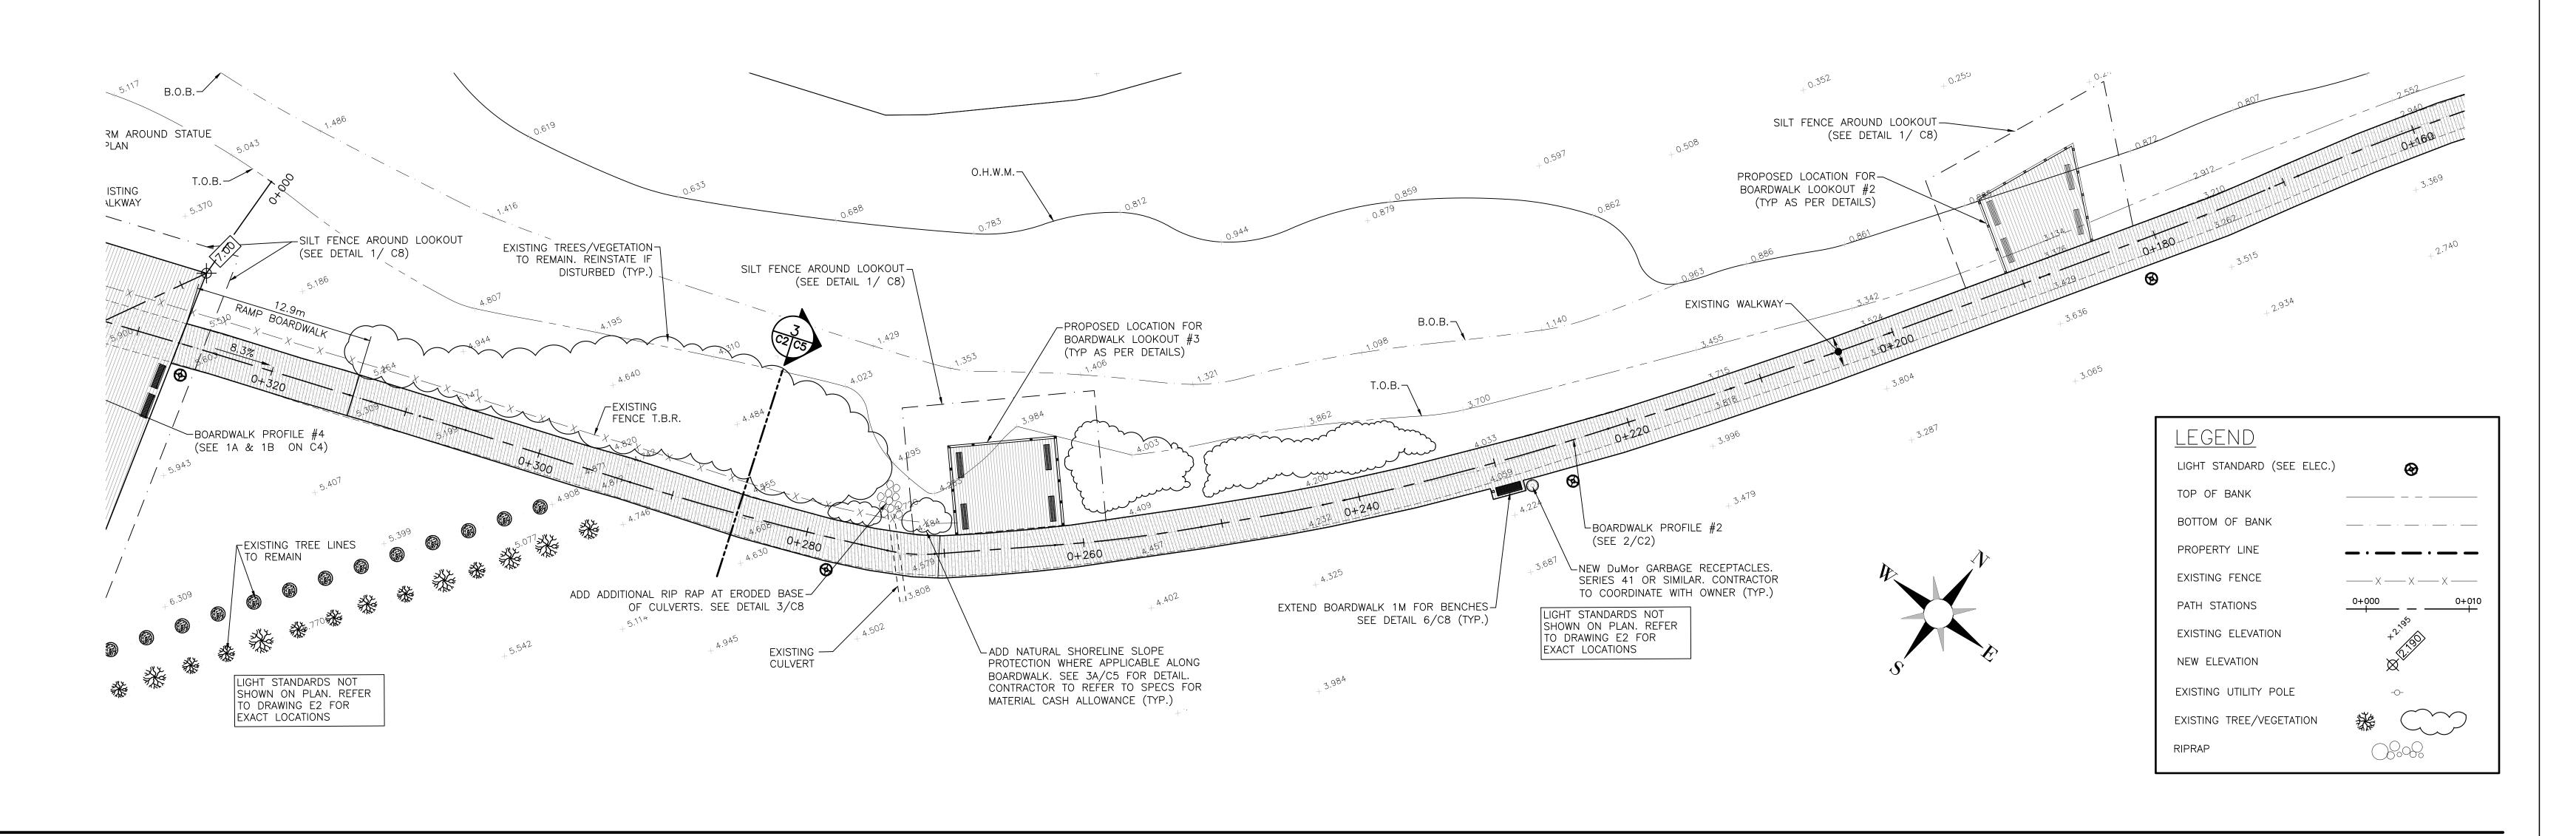


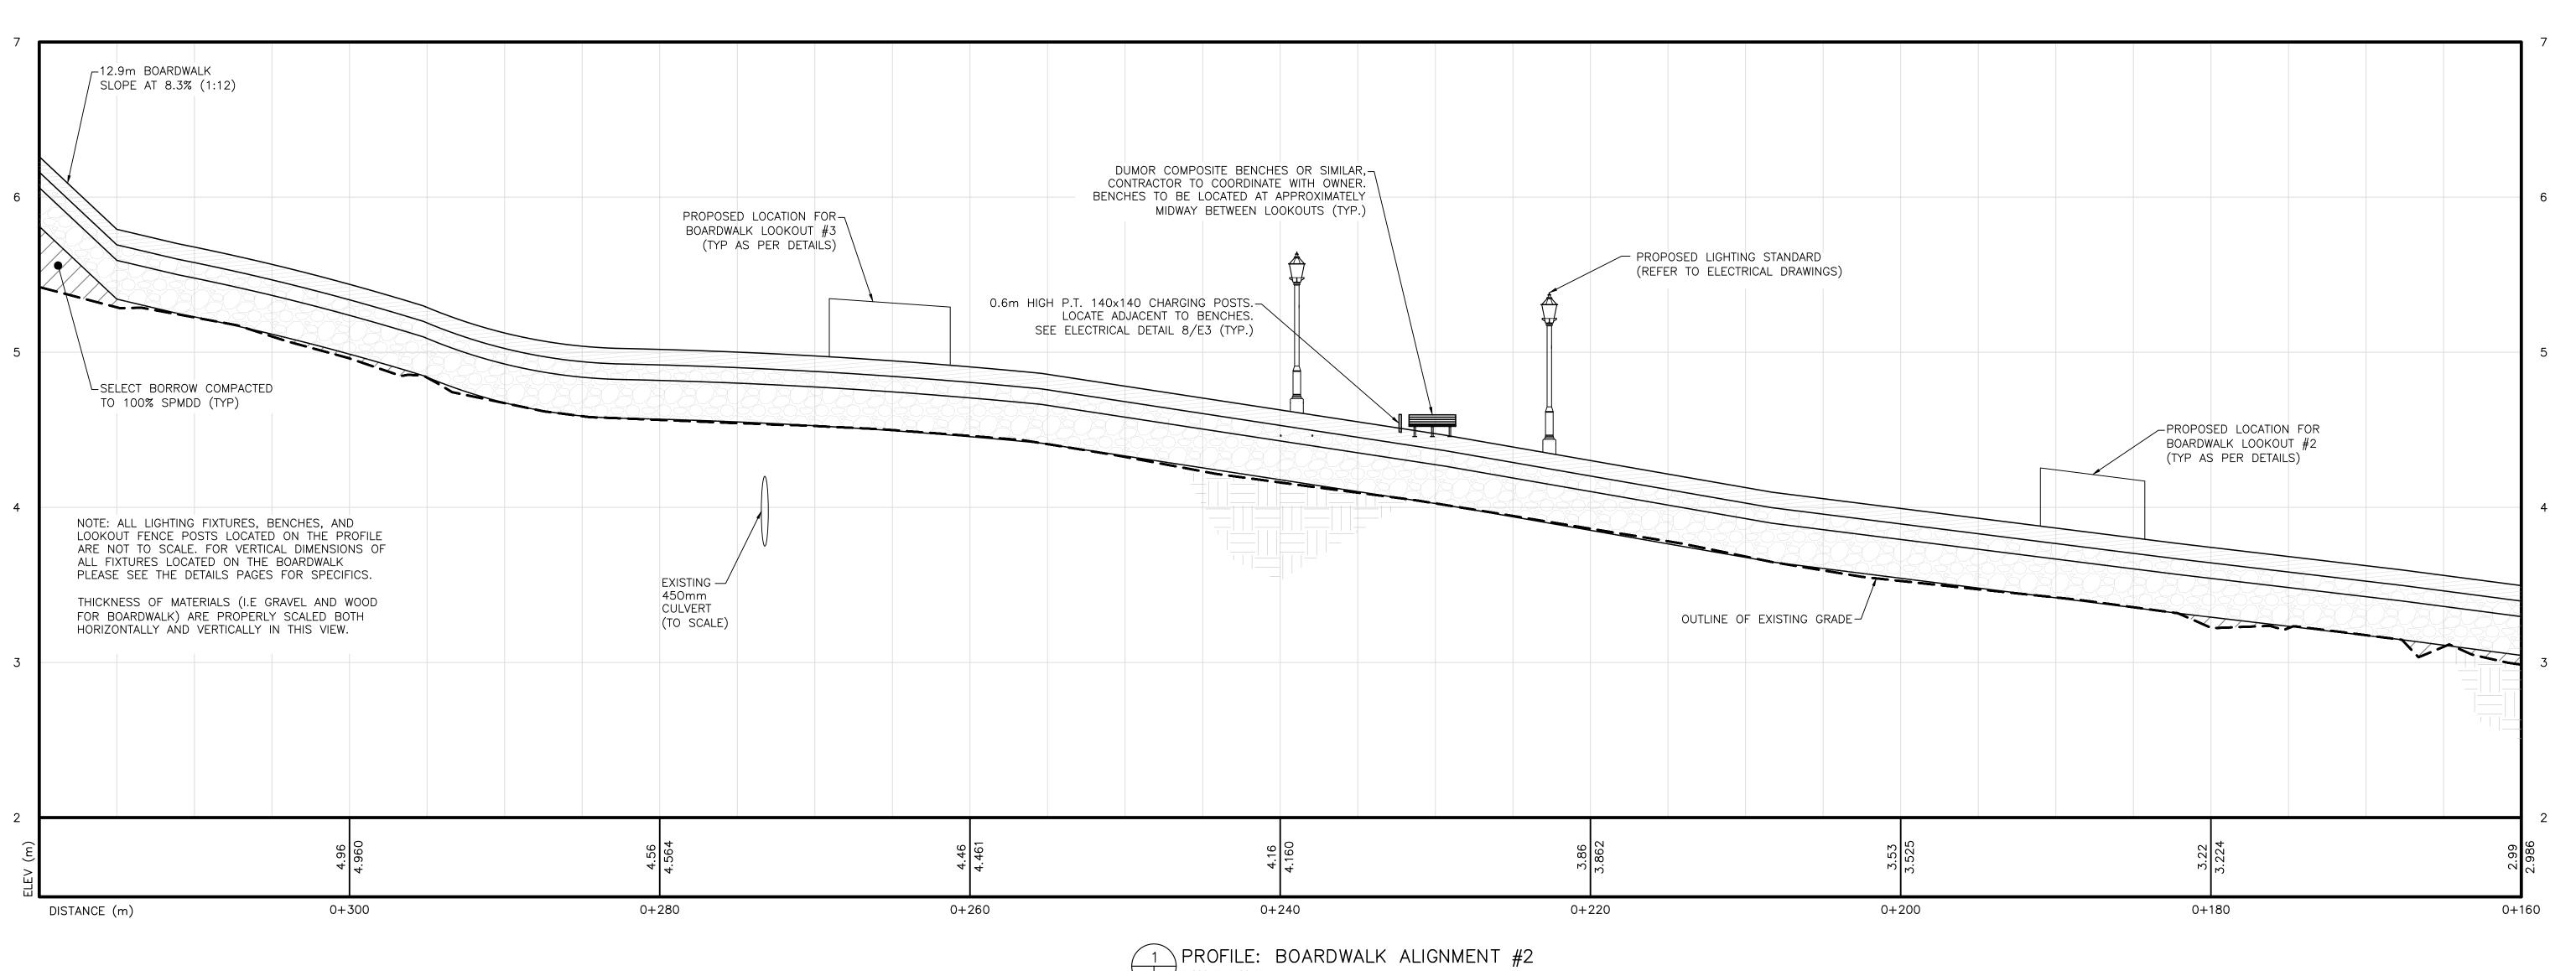

C2 C2 1:200 H, 1:20 V

Project Title

Suite 201, 85 Fitzroy Street Charlottetown, PEI, Canada, C1A 1R6 Phone (902) 368-2300 www.colesassociates.com Architecture + Engineering + Project Management

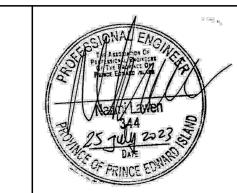



Town of Stratford

Sheet Title Stratford Waterfront Gathering & Event Space Site Plan & Profile #2 Station 0+160 to 0+320

Description Date: 2023-07-25 2023-07-25 Drn By: MK, EIT/ SPB Issued for Tender Chk By: NL, P.Eng Project Number: 221122 Drawing Number: C2


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PROFILE: BOARDWALK ALIGNMENT #3
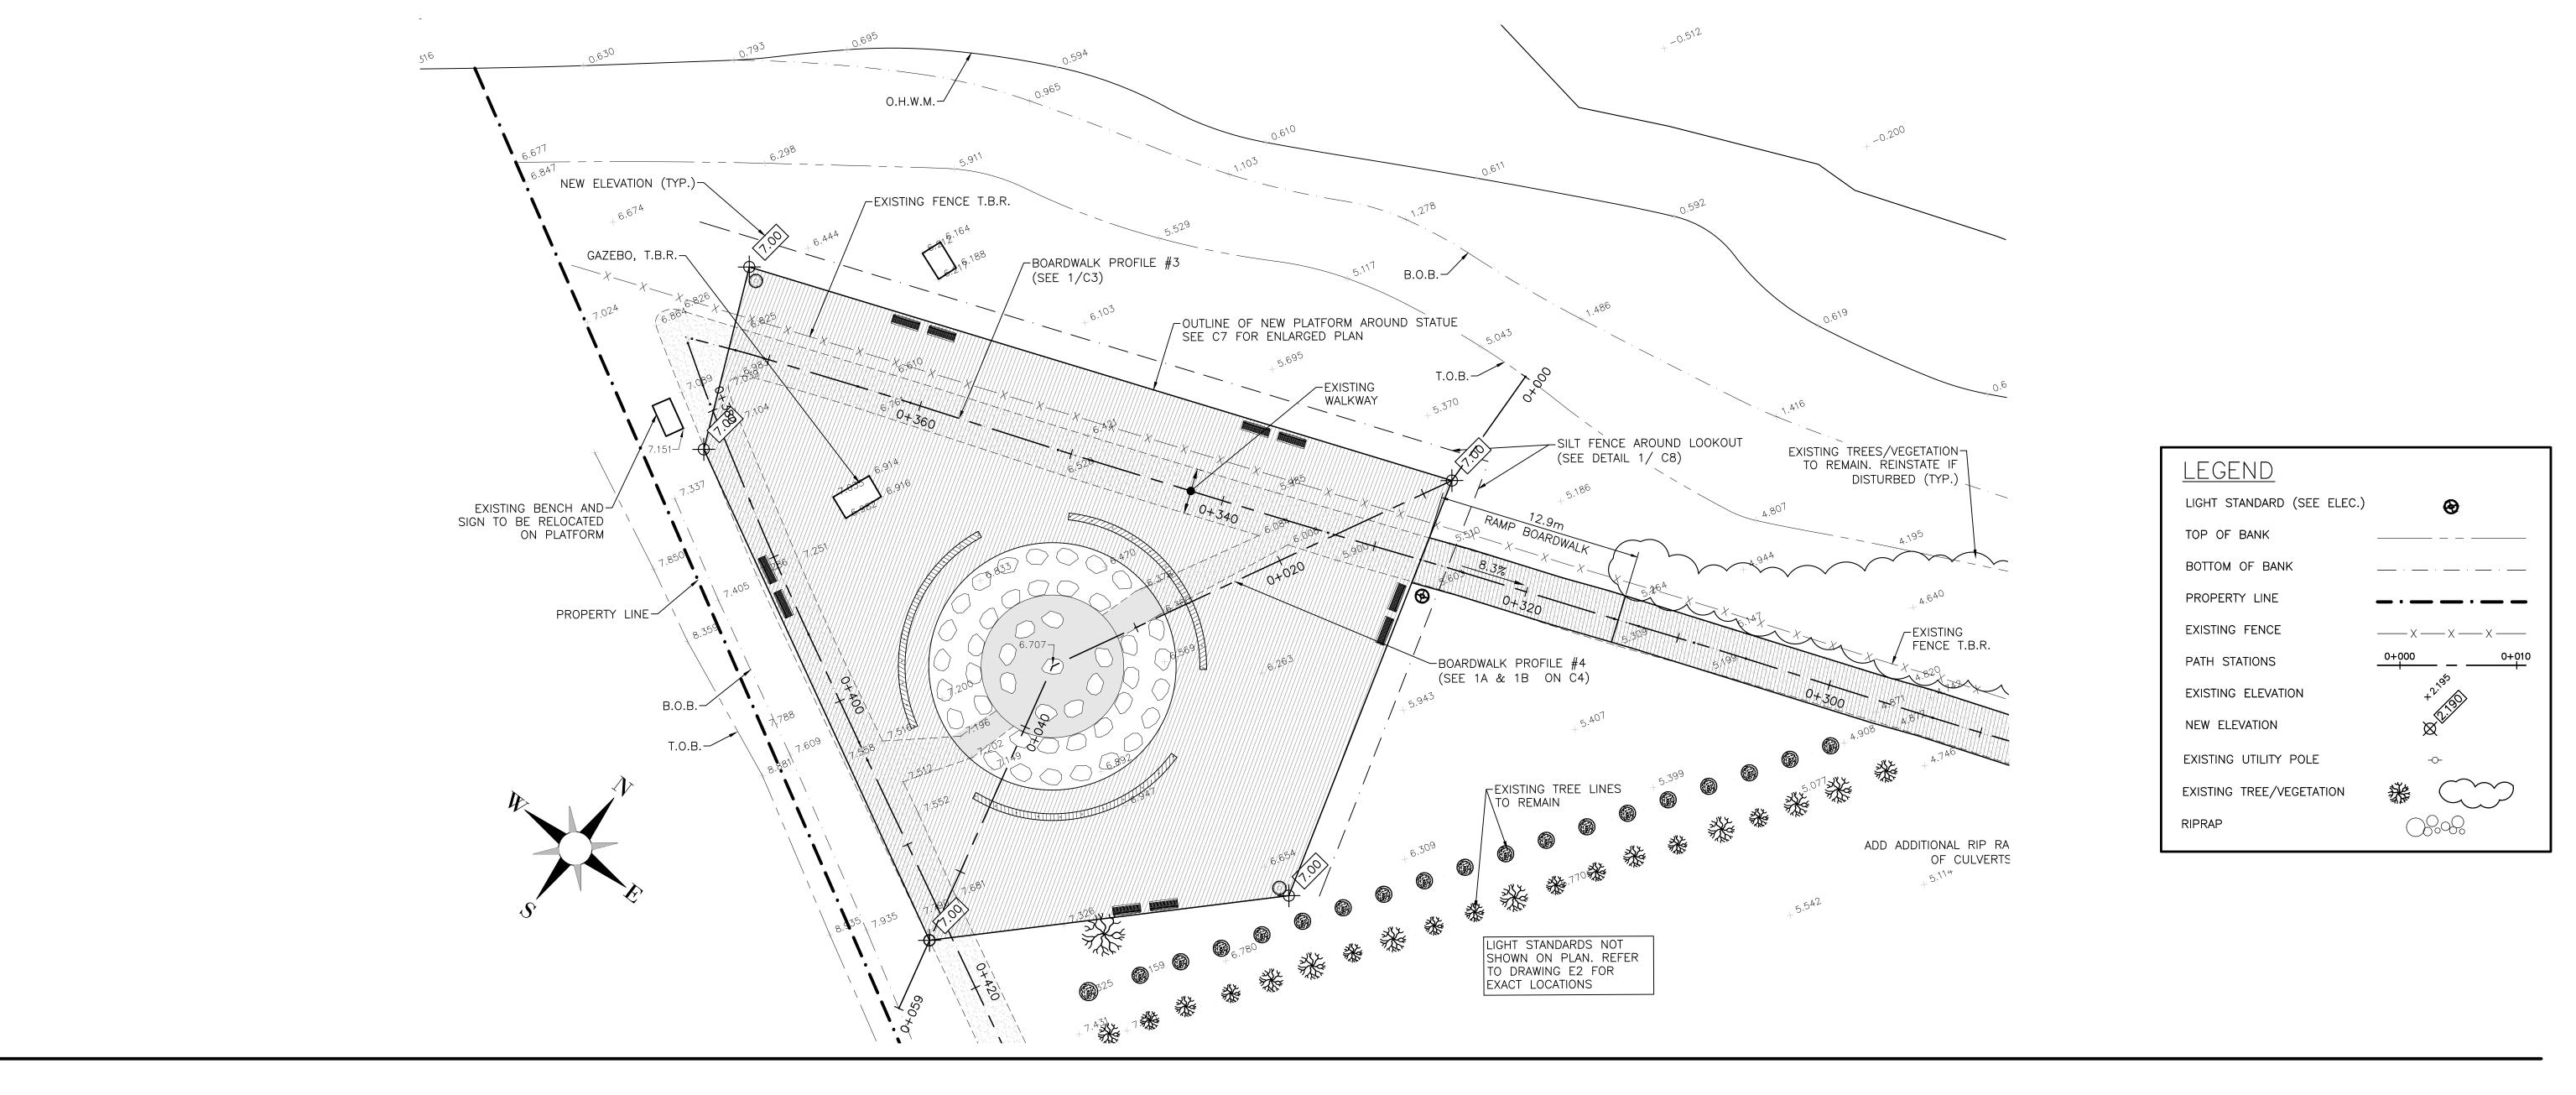
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Town of Stratford

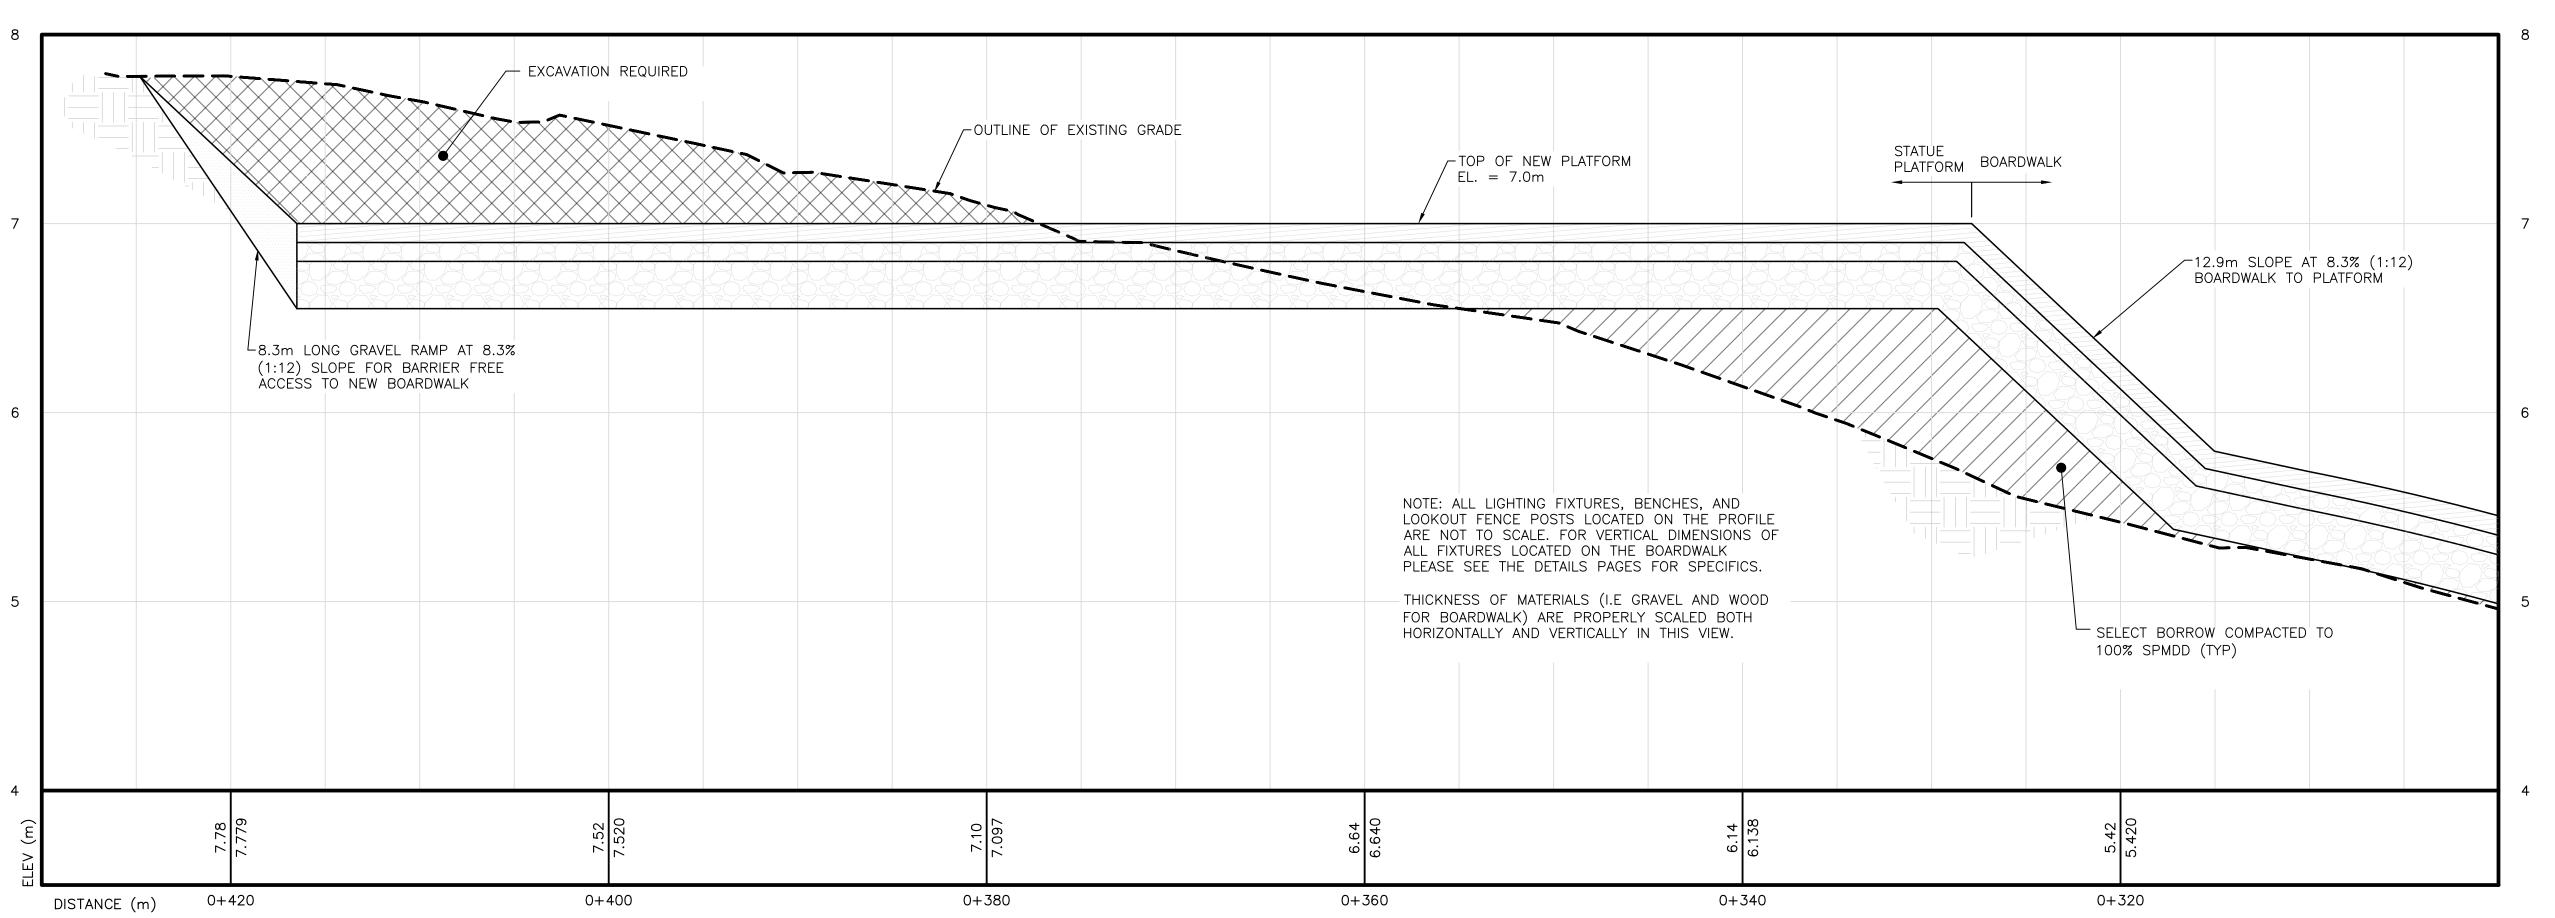Stratford Waterfront
Gathering & Event Space

Sheet Title

Site Plan & Profile #3

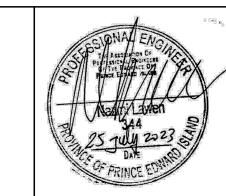Station 0+300 to 0+430

No. Description

Date

Date: 2023-07-25

Drn By: SPB

Chk By: NL, P.Eng

Project Number:


221122


Drawing Number:

C3

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Town of Stratford

Stratford Waterfront
Gathering & Event Space

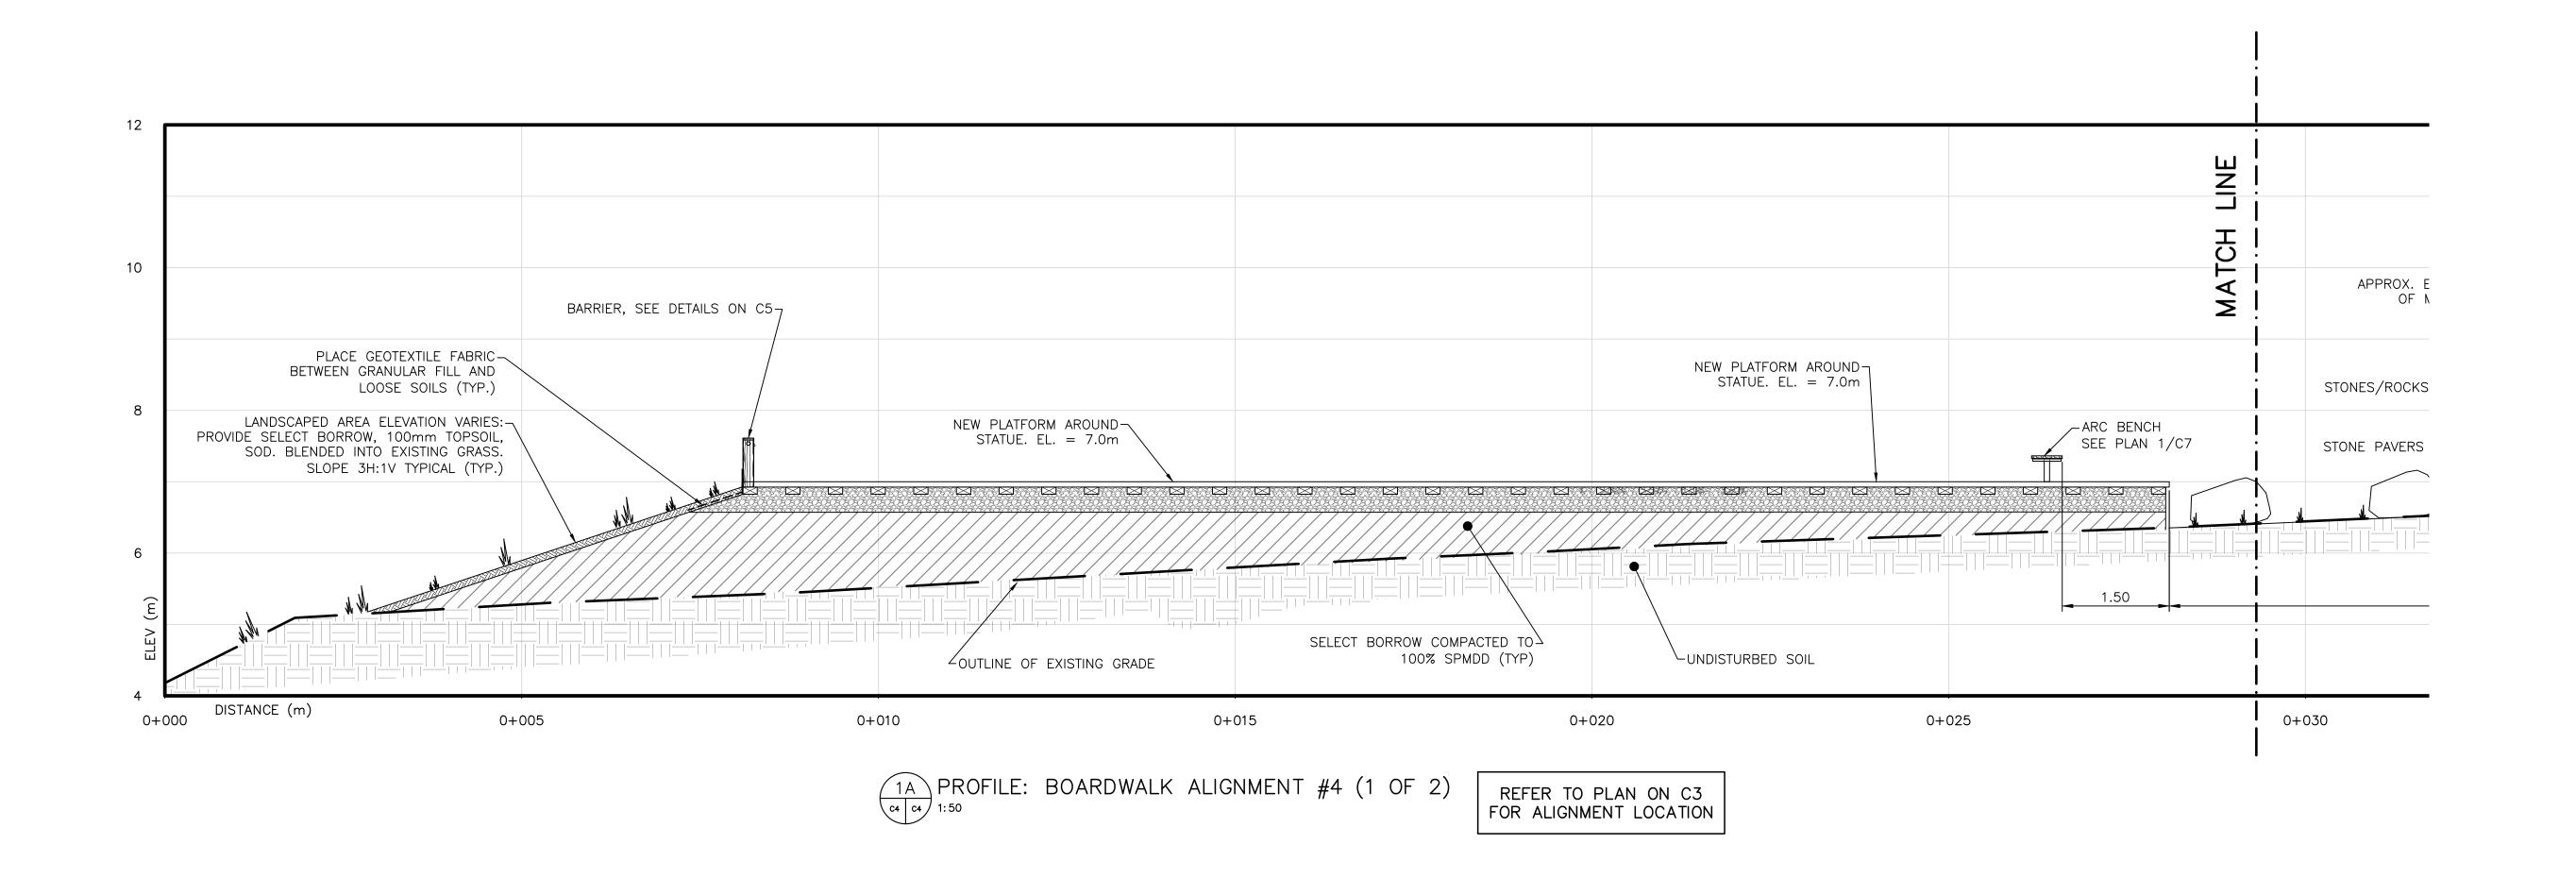Profile #4 Station 0+000 to 0+060

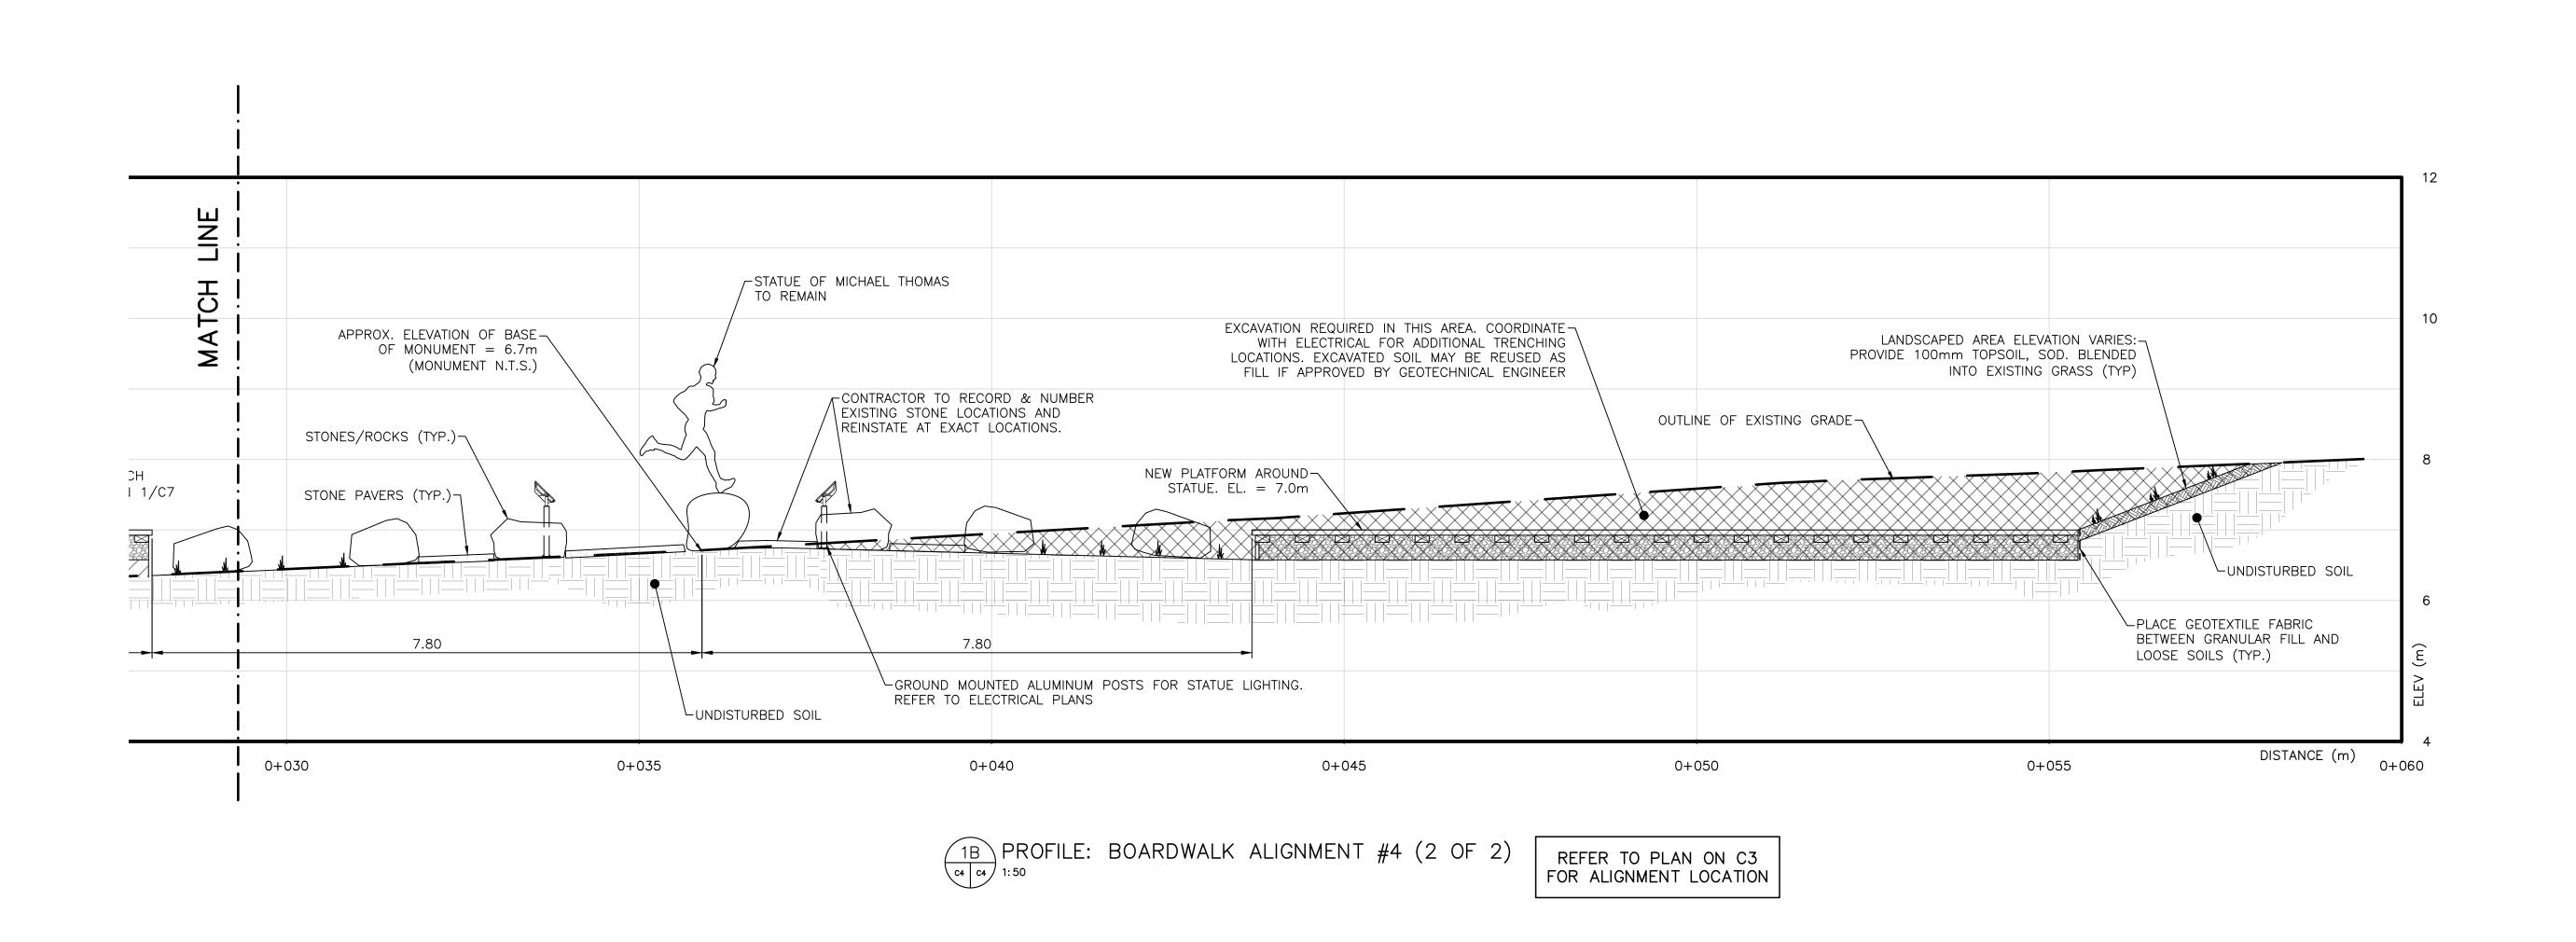Sheet Title

No. Description

Date

Date: 2023-07-25

Drn By: SPB


Chk By: NL, P.Eng


Project Number:

221122

Drawing Number:

C4

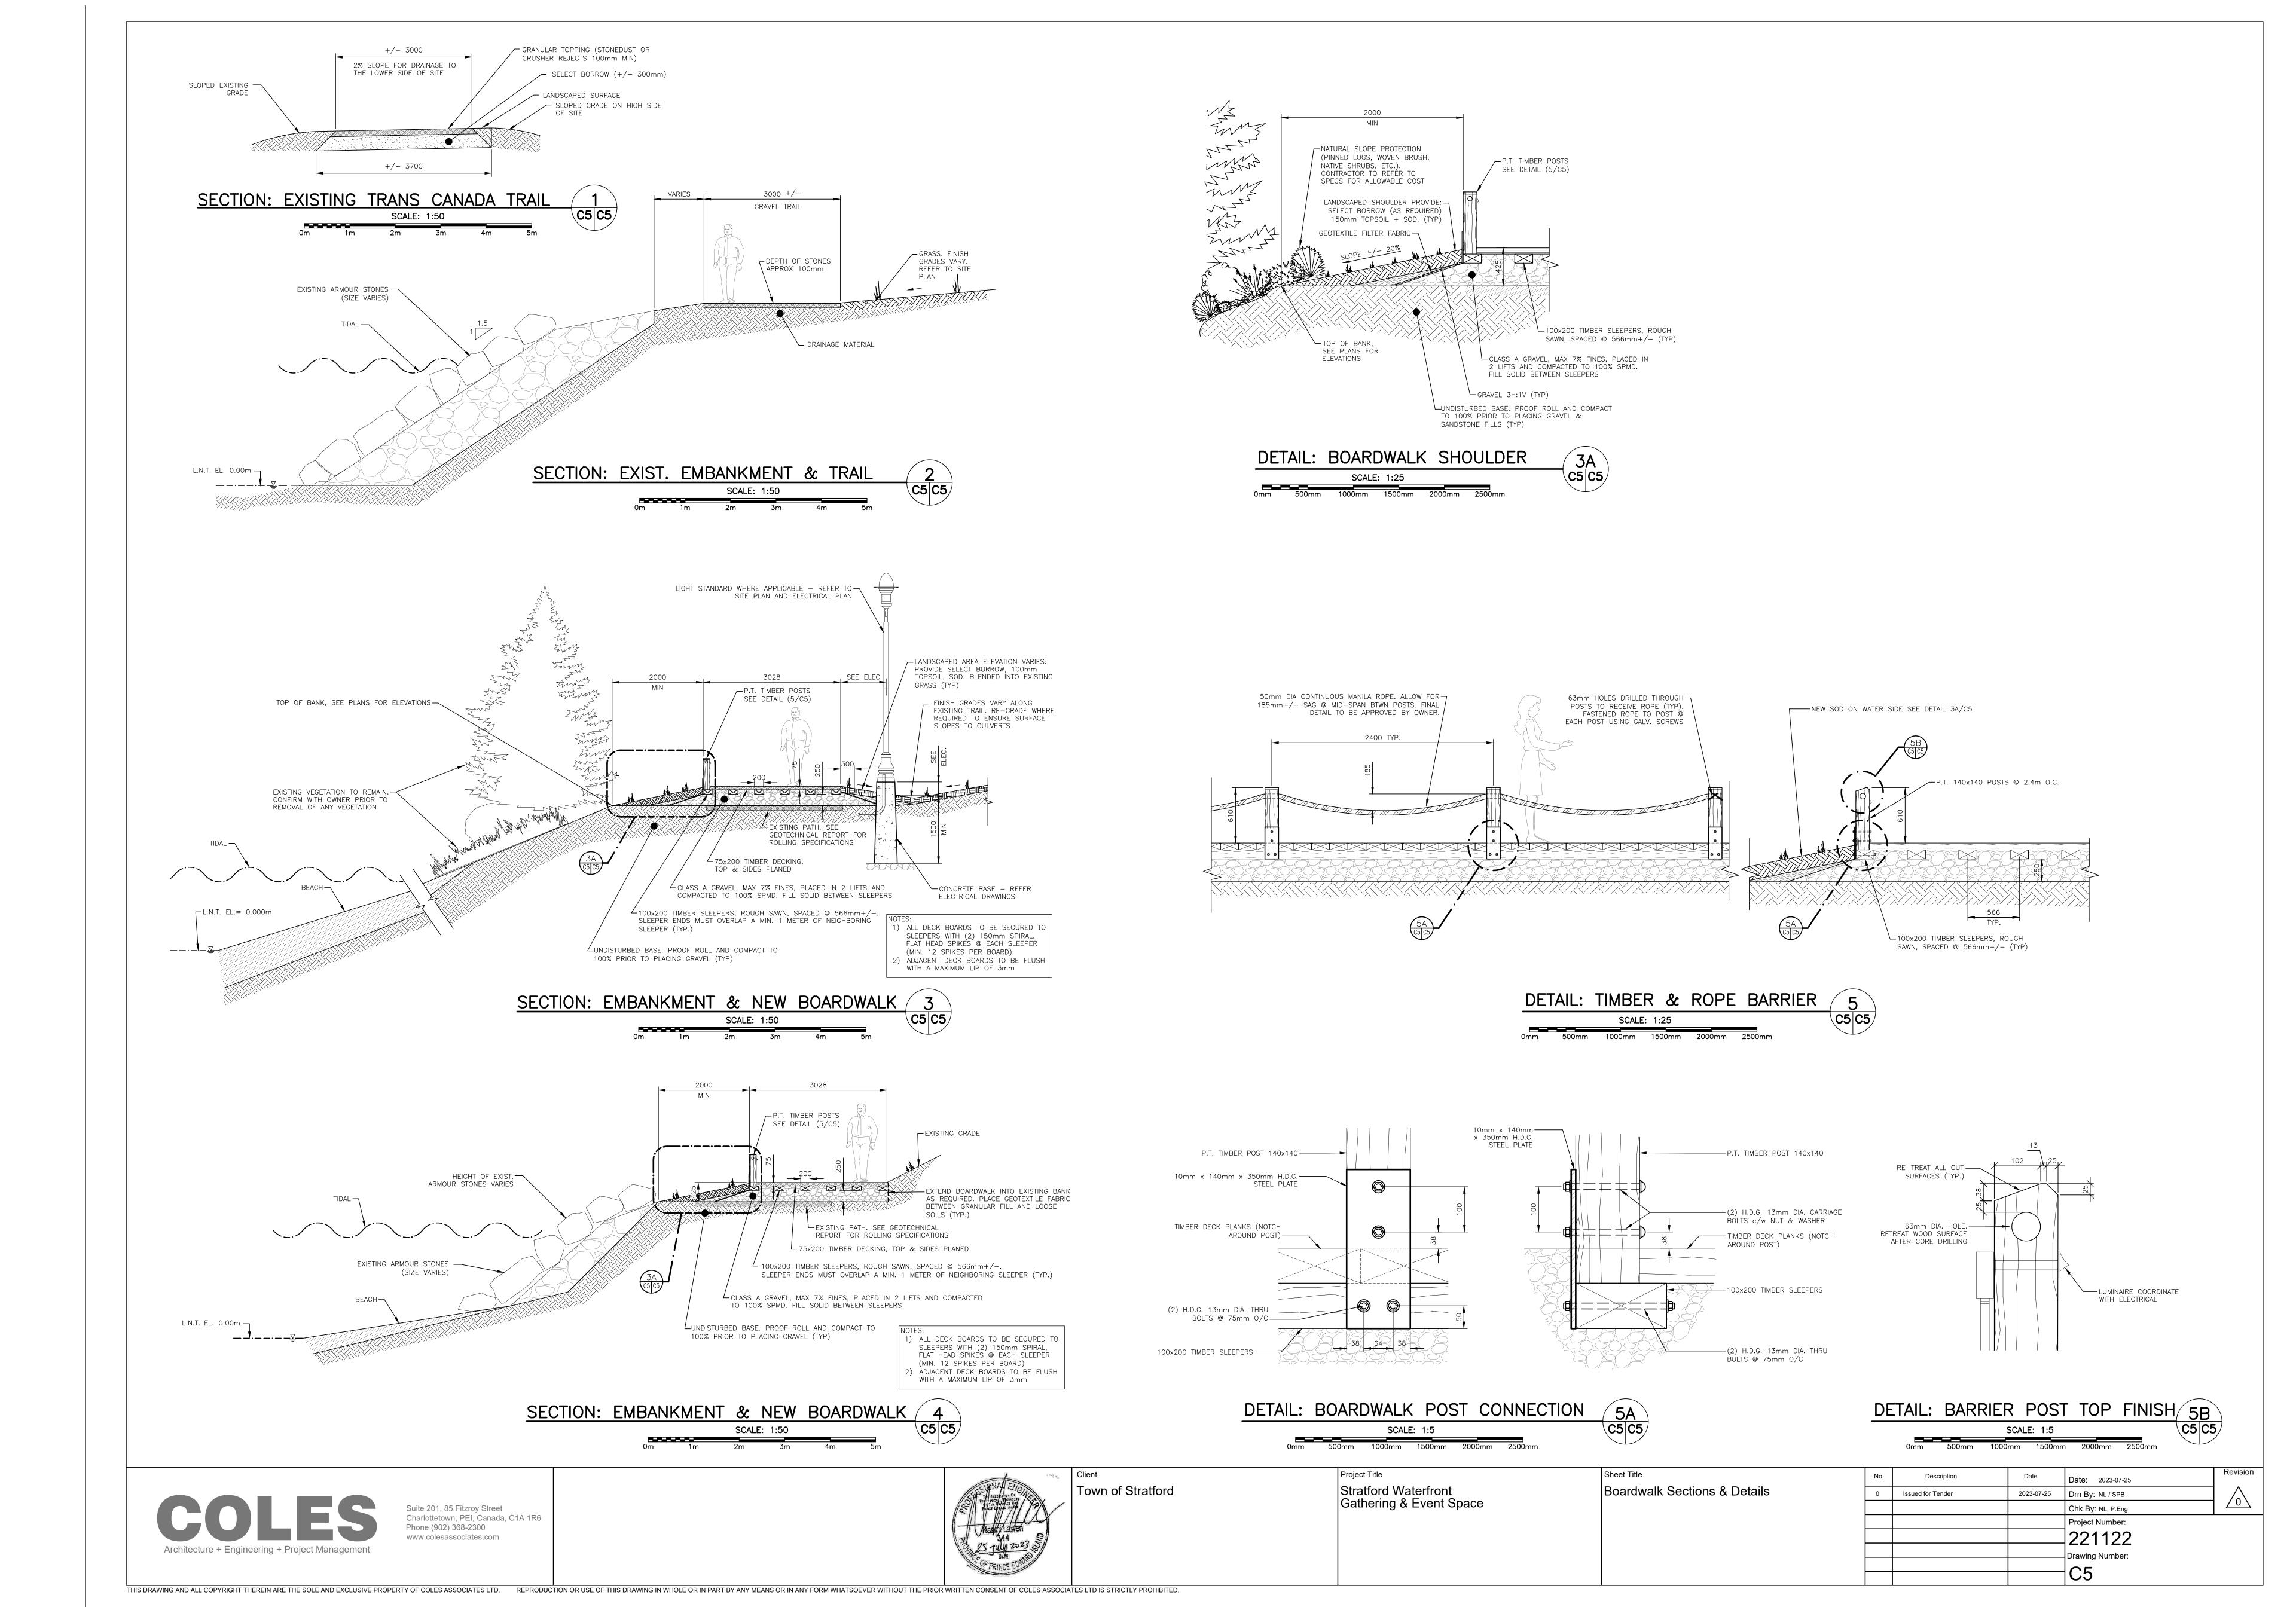

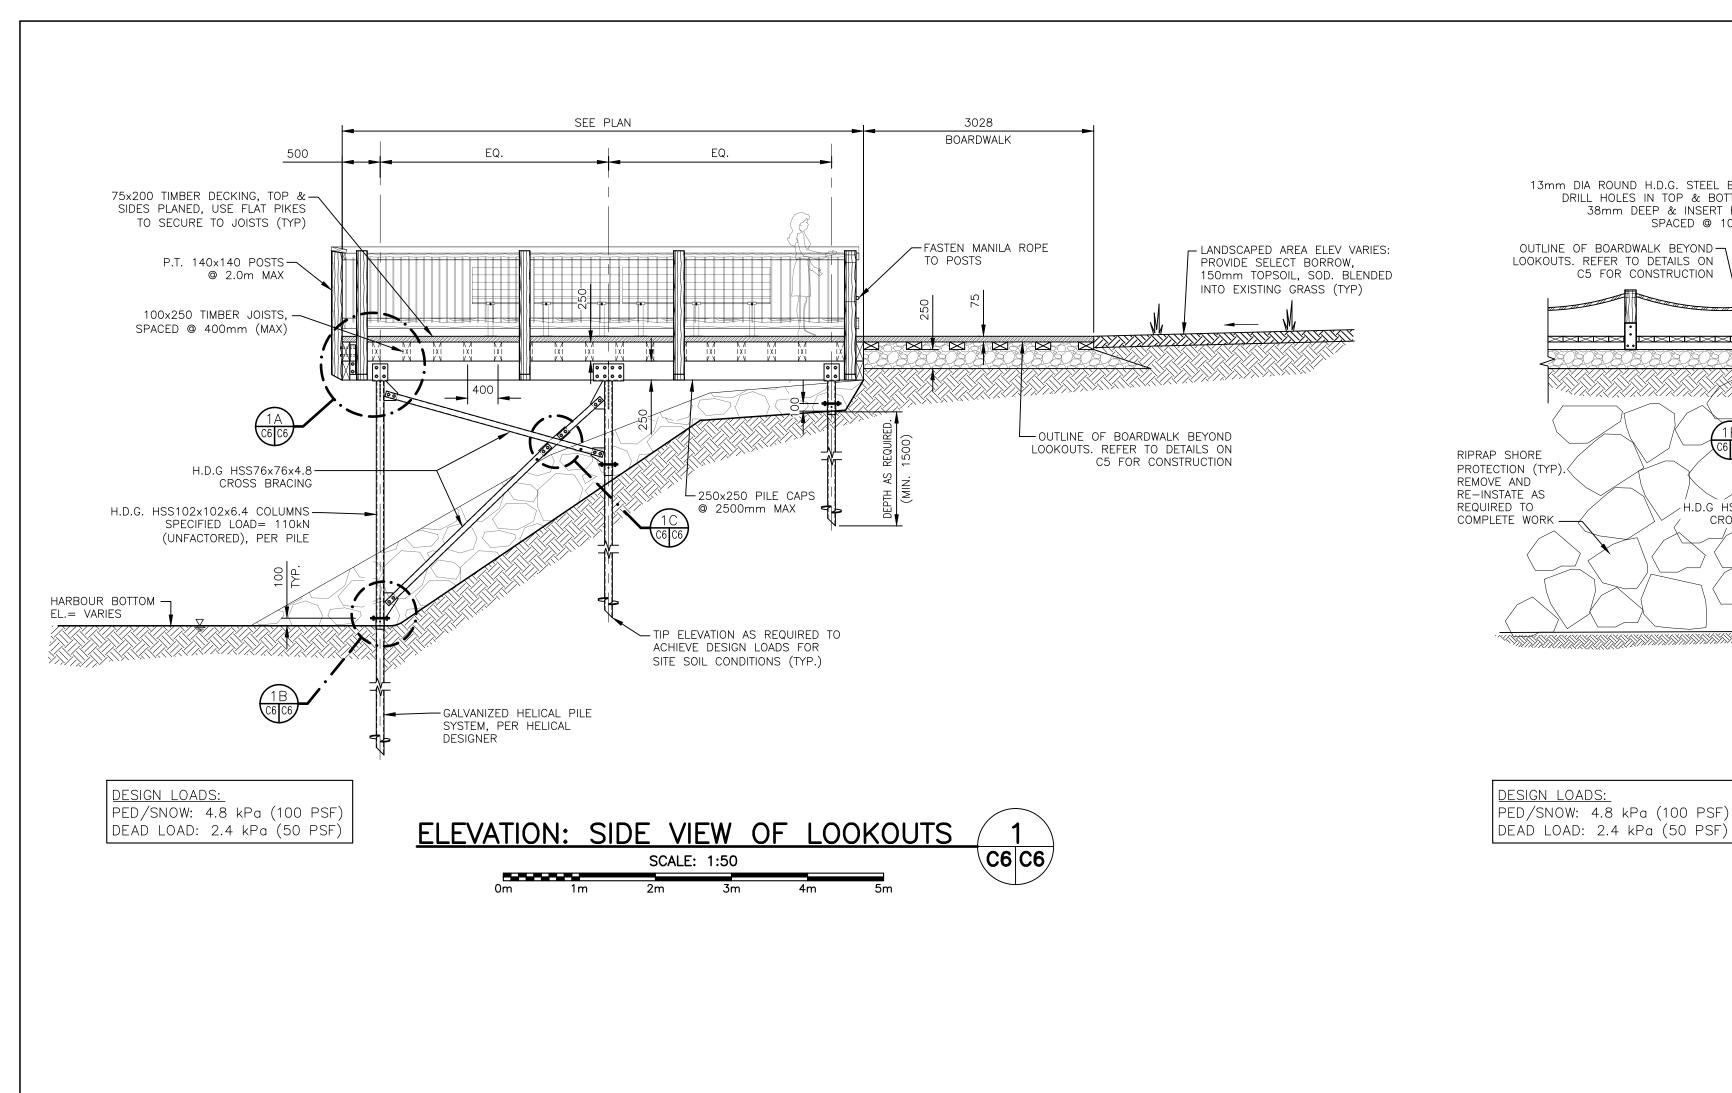

6885


— DuMor RECYCLED PLASTIC BENCH — SERIES 88 OR SIMILAR, COORDINATE

OUTLINE OF POSTS & BARRIER (TYP)

1 C6 C6

PLAN: LOOKOUT #1 & 2 & BOARDWALK


_ WITH OWNER (TYP.)

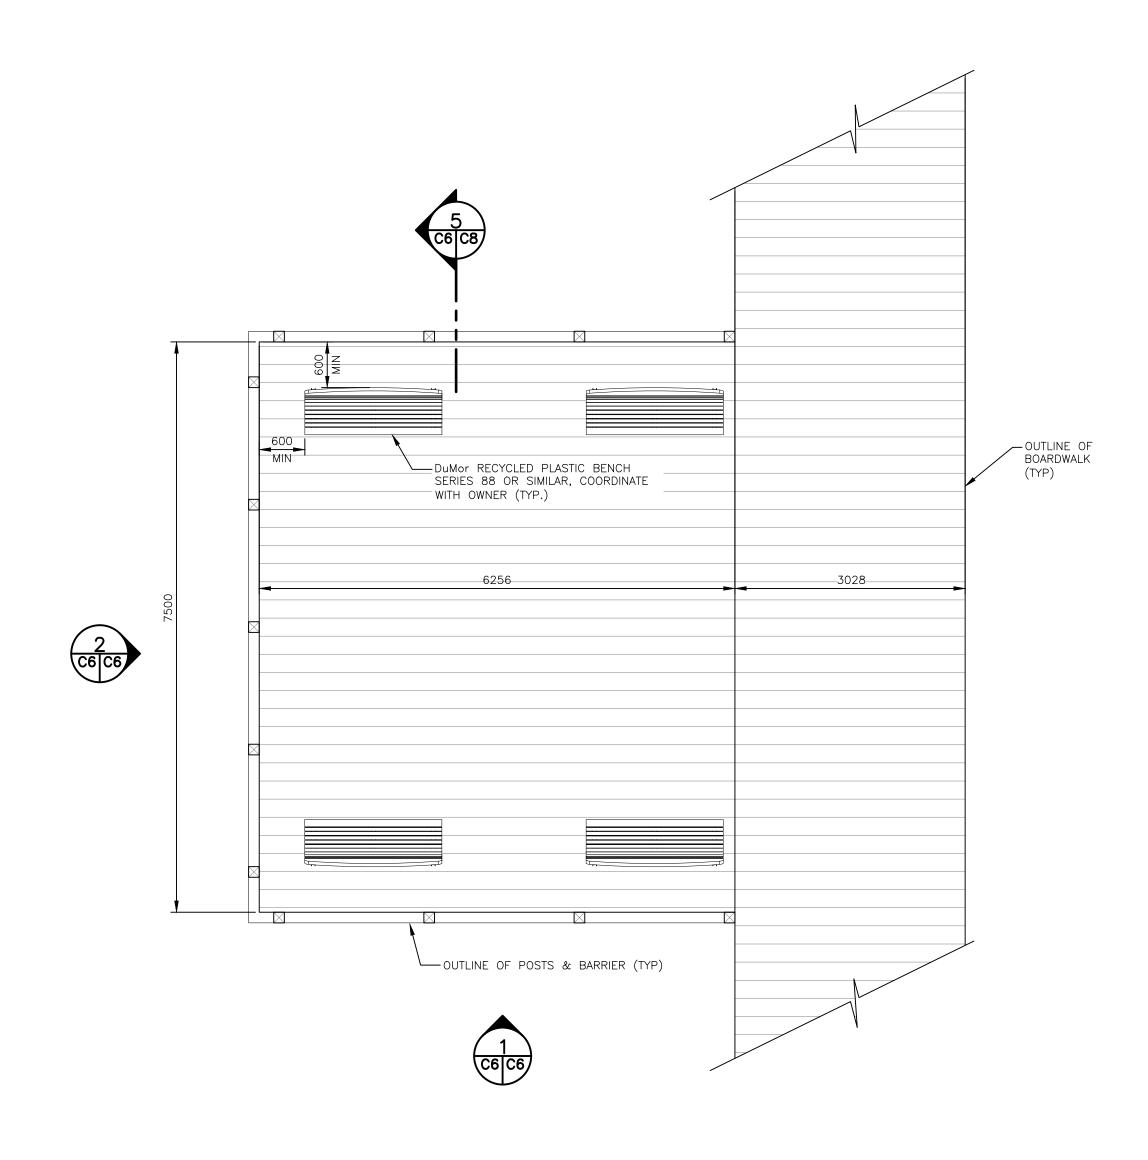

PLAN: LOOKOUT #3 & BOARDWALK

SCALE: 1:50

ELEVATION: FRONT VIEW OF LOOKOUTS

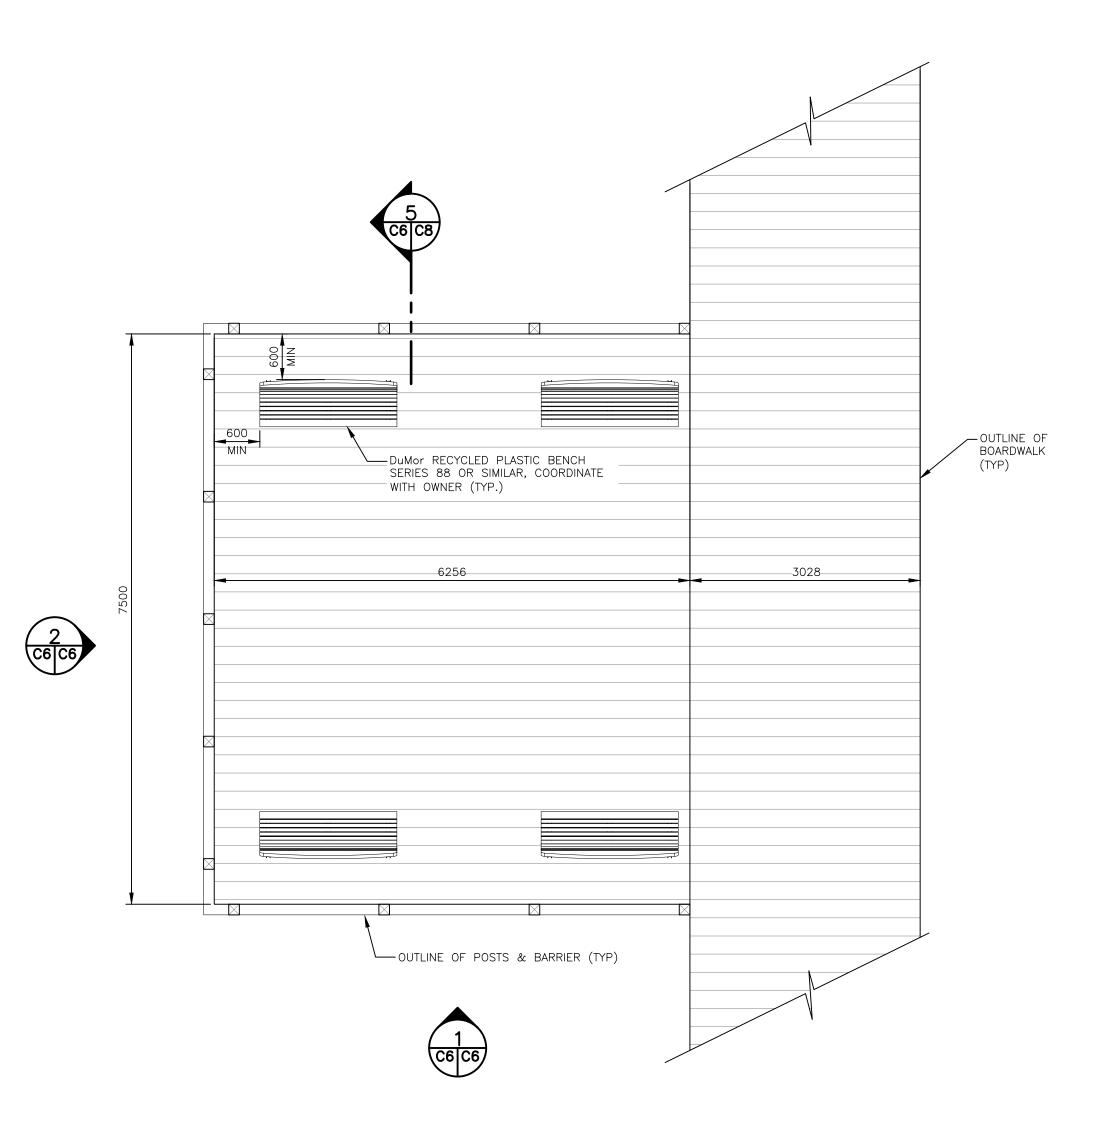

EQ

REFER TO LOOKOUT PLANS
FOR OVERALL DIMENSIONS

EQ

TIMBER JOISTS,

SPACED @

└100x250

BETWEEN

CAPS ENDS

400mm (MAX)

-P.T. 140x140 POSTS

250x250 PILE CAP @ 2500mm MAX.

SPECIFIED LOAD = 110kN

/ HARBOUR BOTTOM ELEV. VARIES

(UNFACTORED) PER PILE

- GALVANIZED HELICAL PILE

SYSTEM, PER HELICAL

DESIGNÉR

\C6 | **C6** /

@ 2.0m MAX

EQ

BLOCKING

@ 1800mm

RIPRAP NOT SHOWN FOR CLARITY

SIM (1C) (C6 C6)

75×200 DECKING →

13mm DIA ROUND H.D.G. STEEL BALUSTERS. — DRILL HOLES IN TOP & BOTTOM RAILS,

OUTLINE OF BOARDWALK BEYOND -


C5 FOR CONSTRUCTION


LOOKOUTS. REFER TO DETAILS ON

38mm DEEP & INSERT BALUSTERS
SPACED @ 100mm MAX

H.D.G HSS76x76x4.8 —


CROSS BRACING

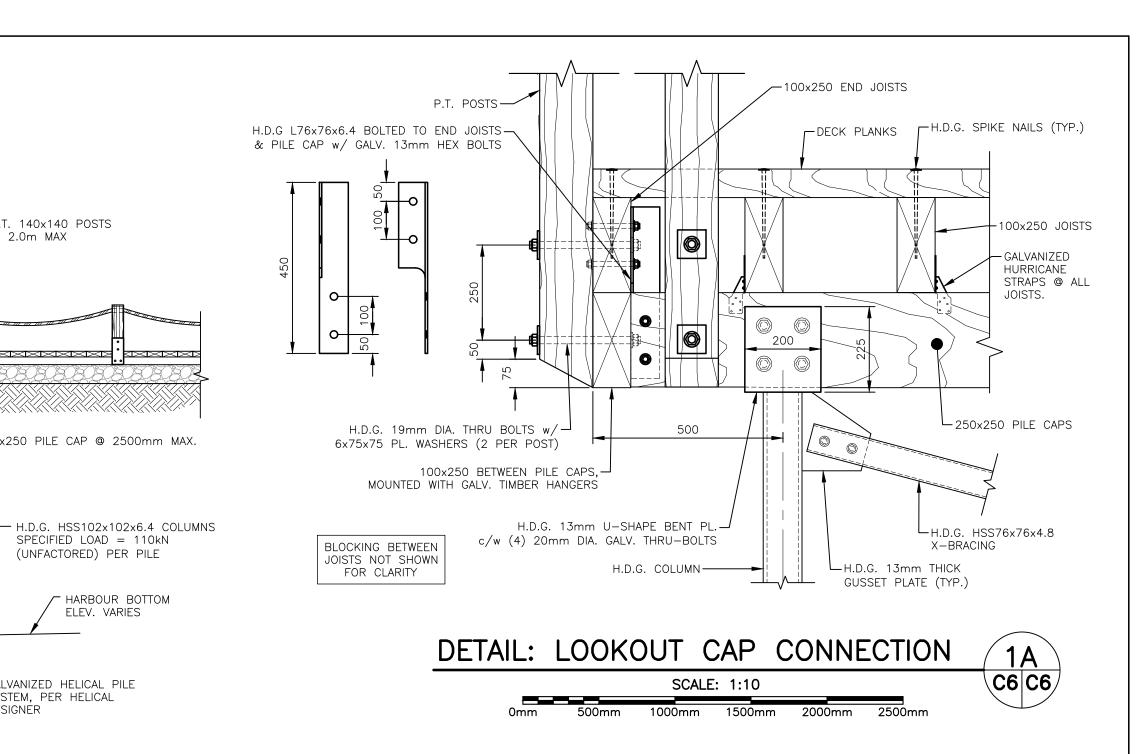


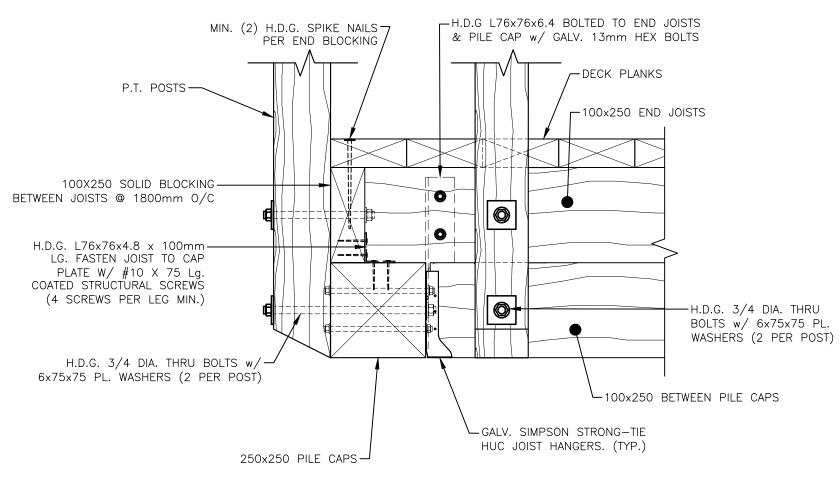



SHOWN FOR CLARITY, SEE DETAIL 1A/C6 DETAIL: LOOKOUT CAP CONNECTION

COLUMN, CAP PLATE & BRACING NOT

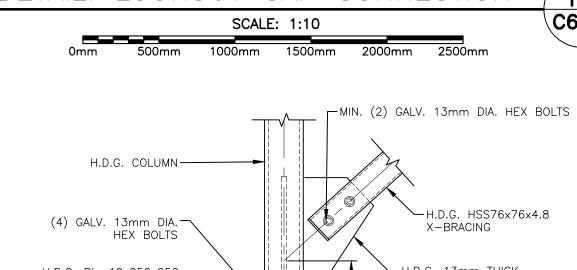


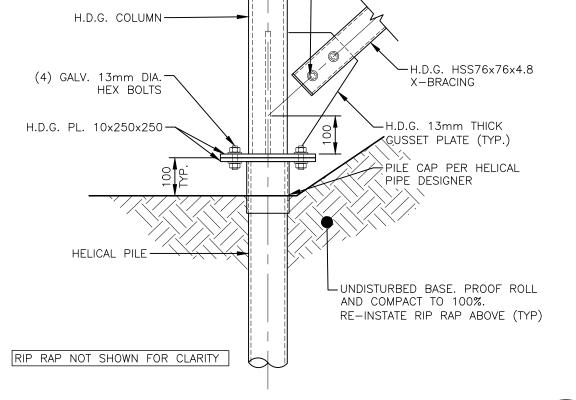

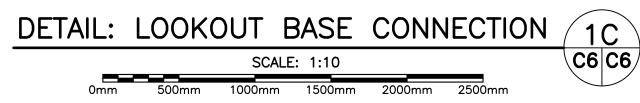

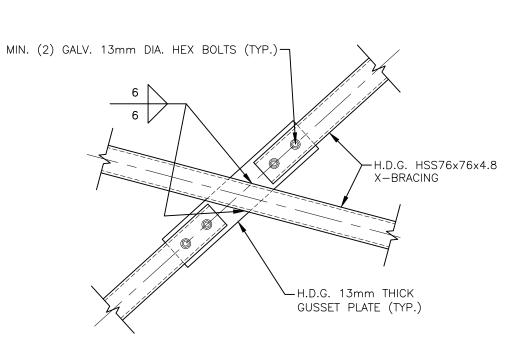


DETAIL: MIDDLE BRACING CONNECTION 1D

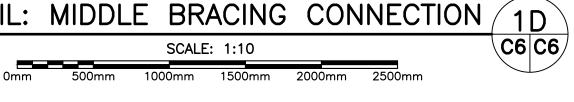



2 C6 C6

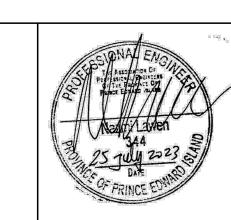

UDUTLINE OF BOARDWALK (TYP)

C6 C6


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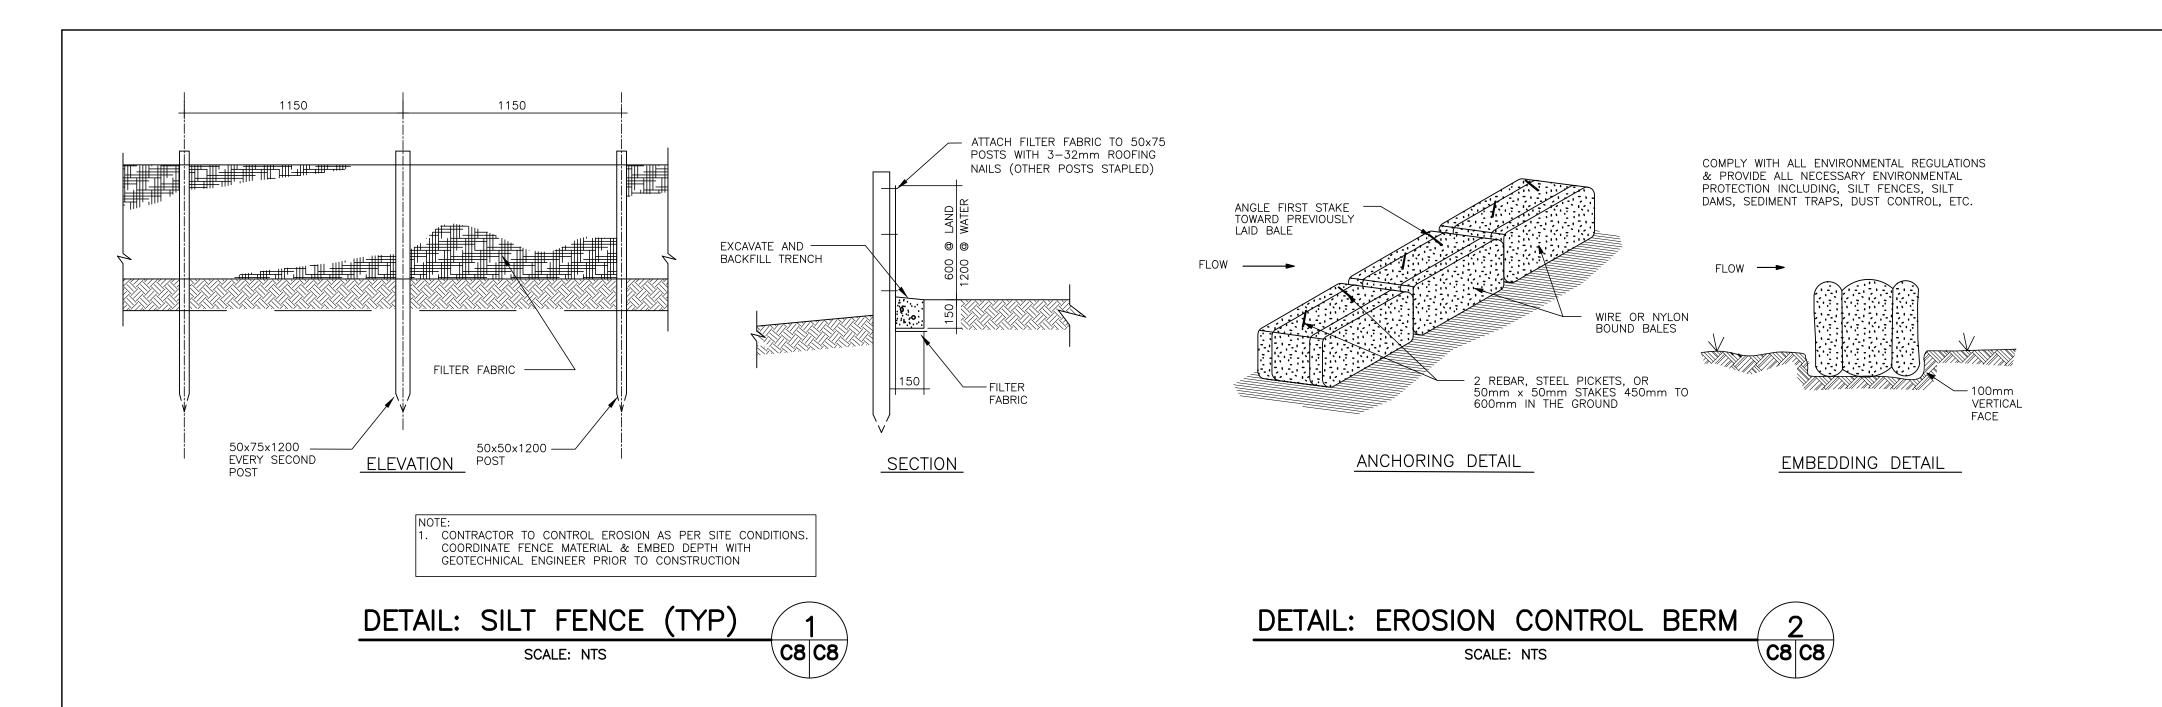
Town of Stratford


Project Title Stratford Waterfront Gathering & Event Space


Lookout Sections & Details

Description Date Date: 2023-07-25 2023-07-25 Drn By: NL / SPB Issued for Tender Chk By: NL, P.Eng Project Number: 221122 Drawing Number:



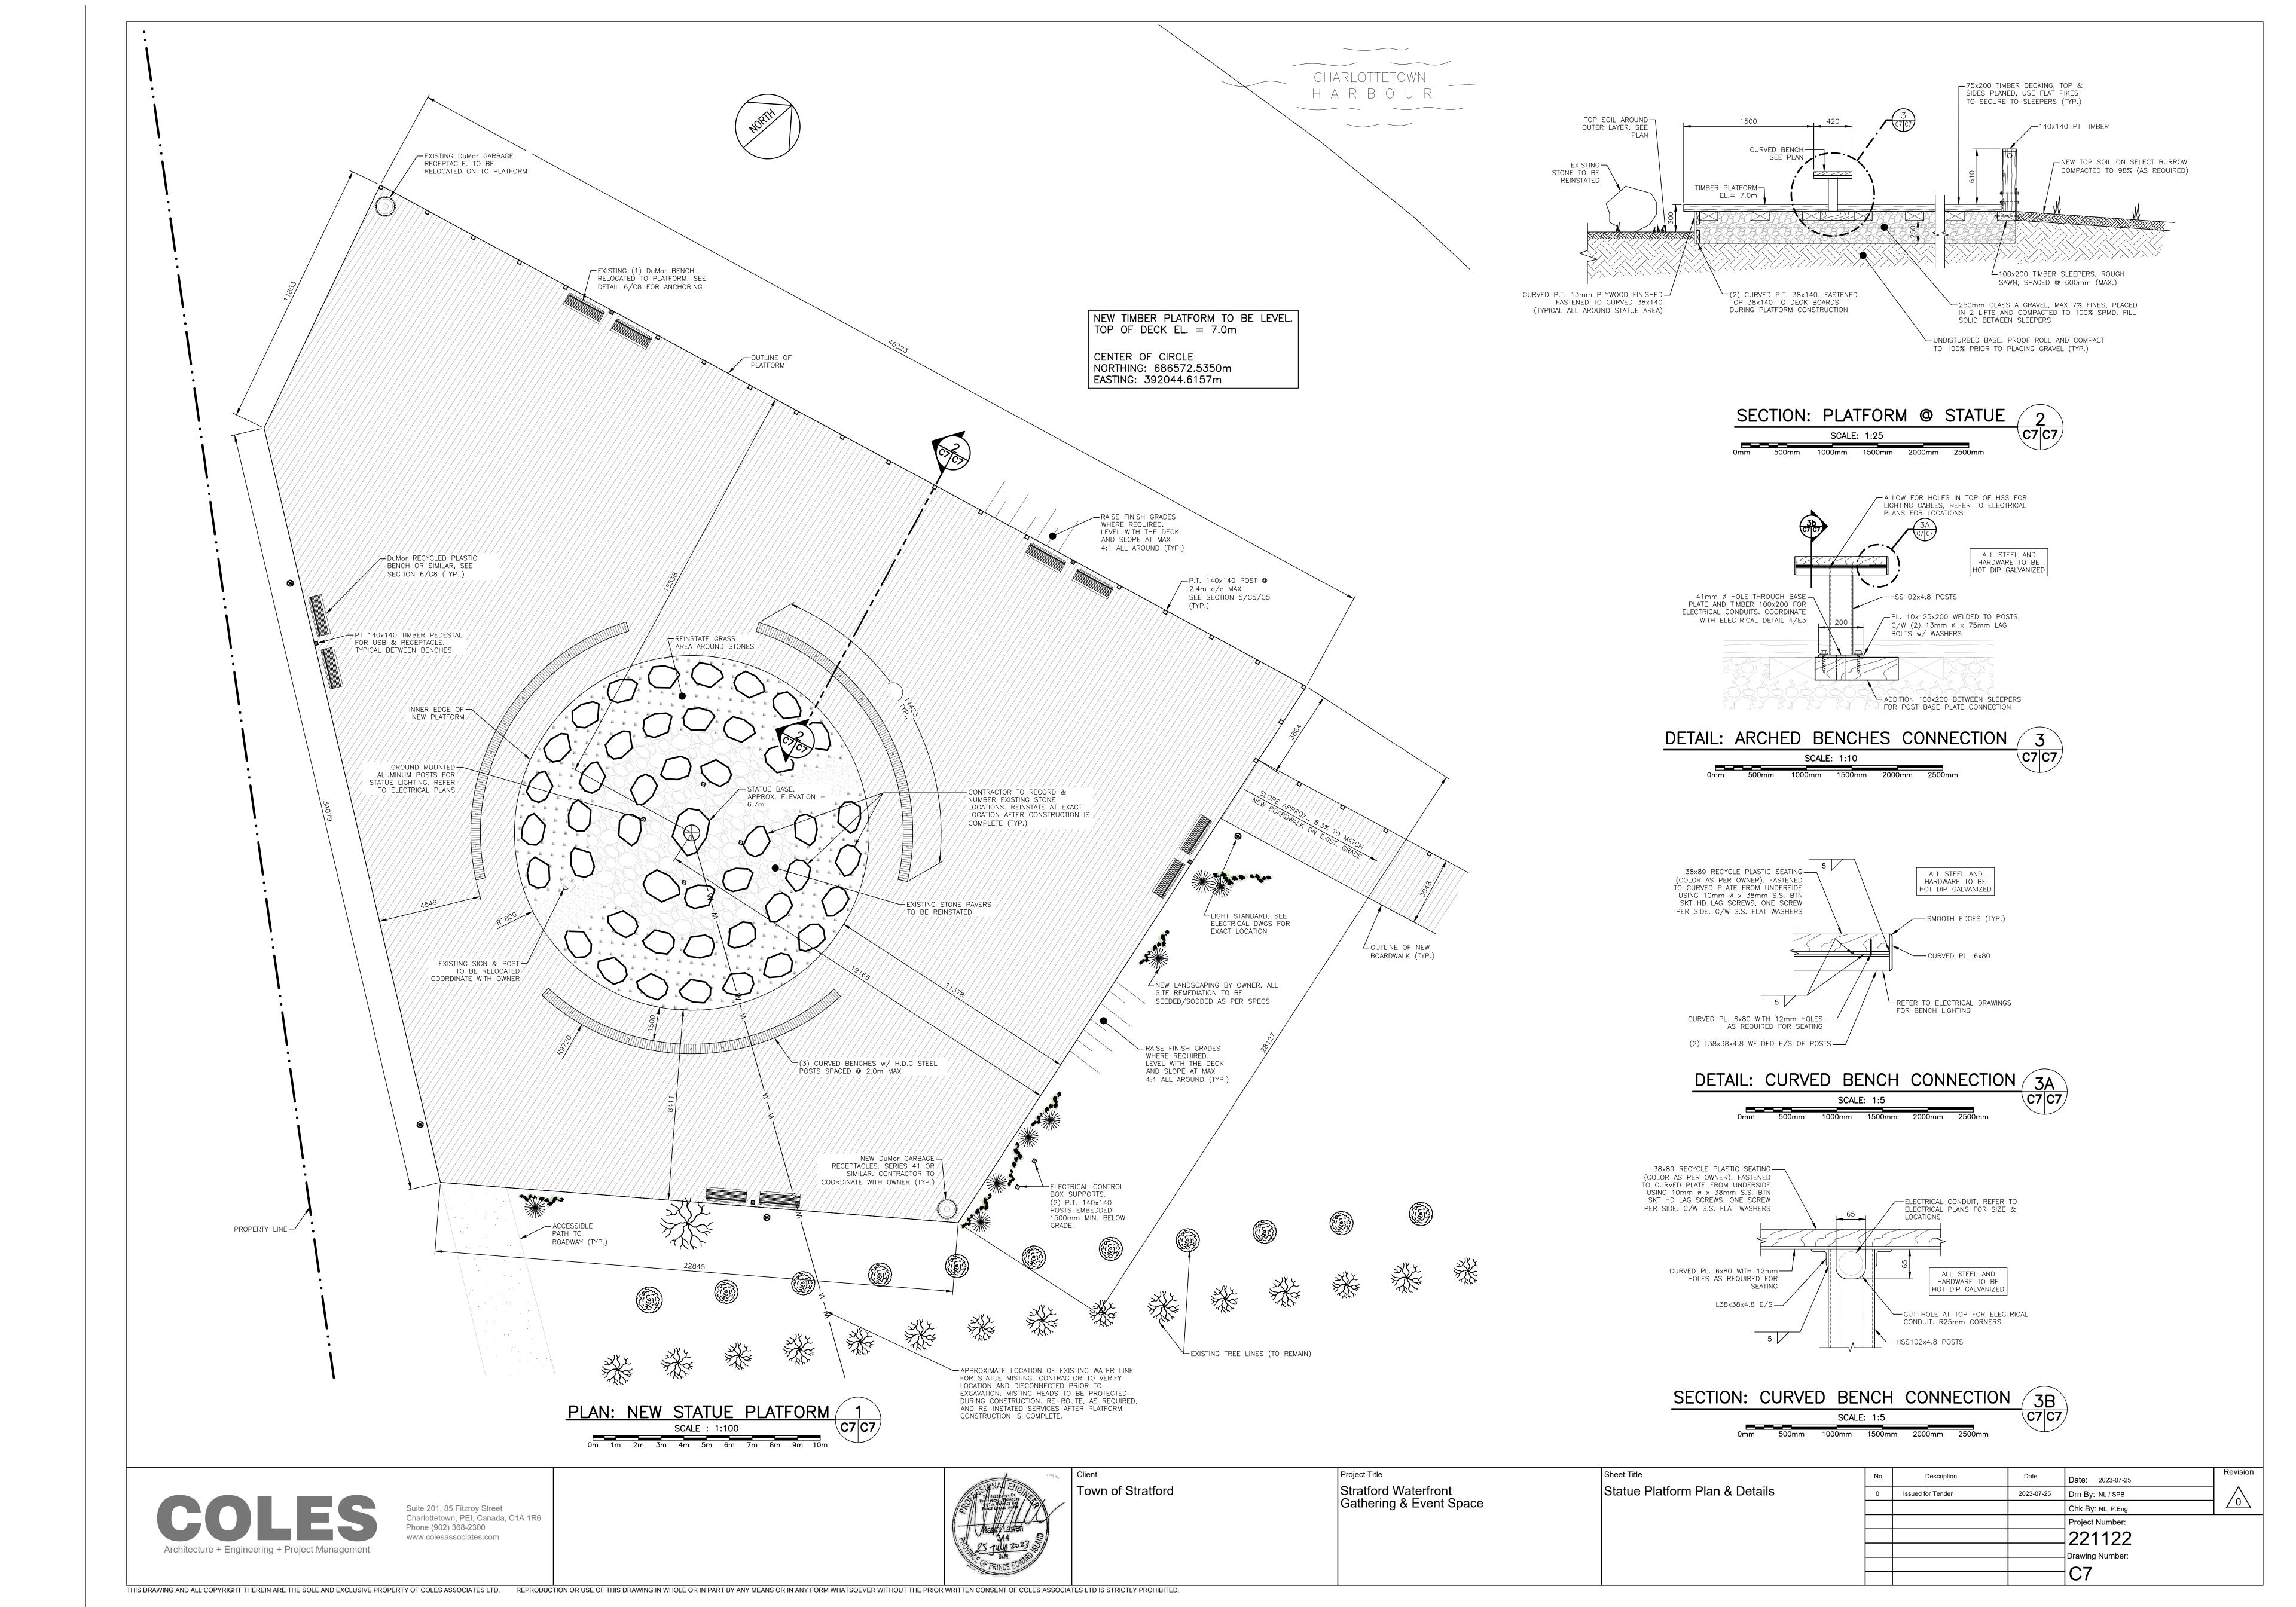


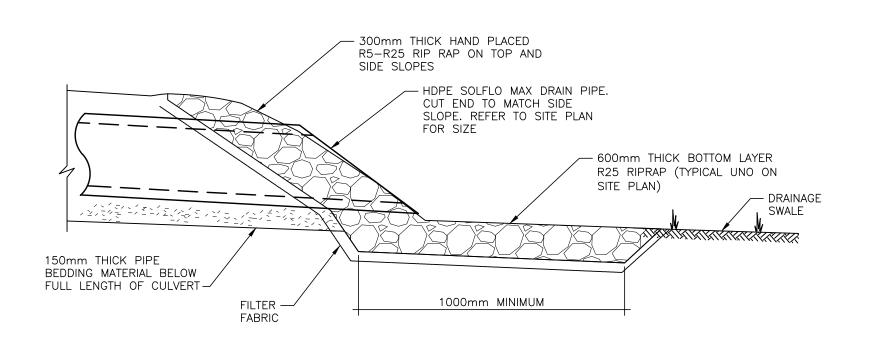

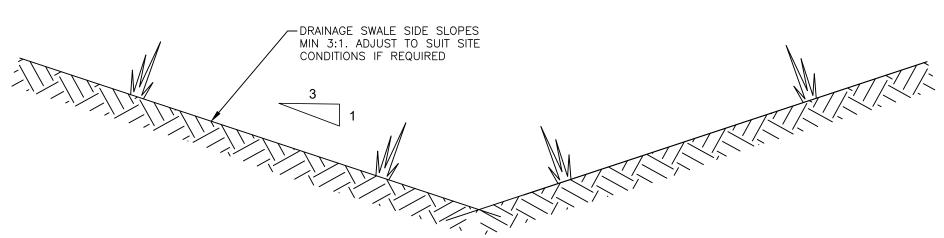

DETAIL: CULVERT END (TYP)



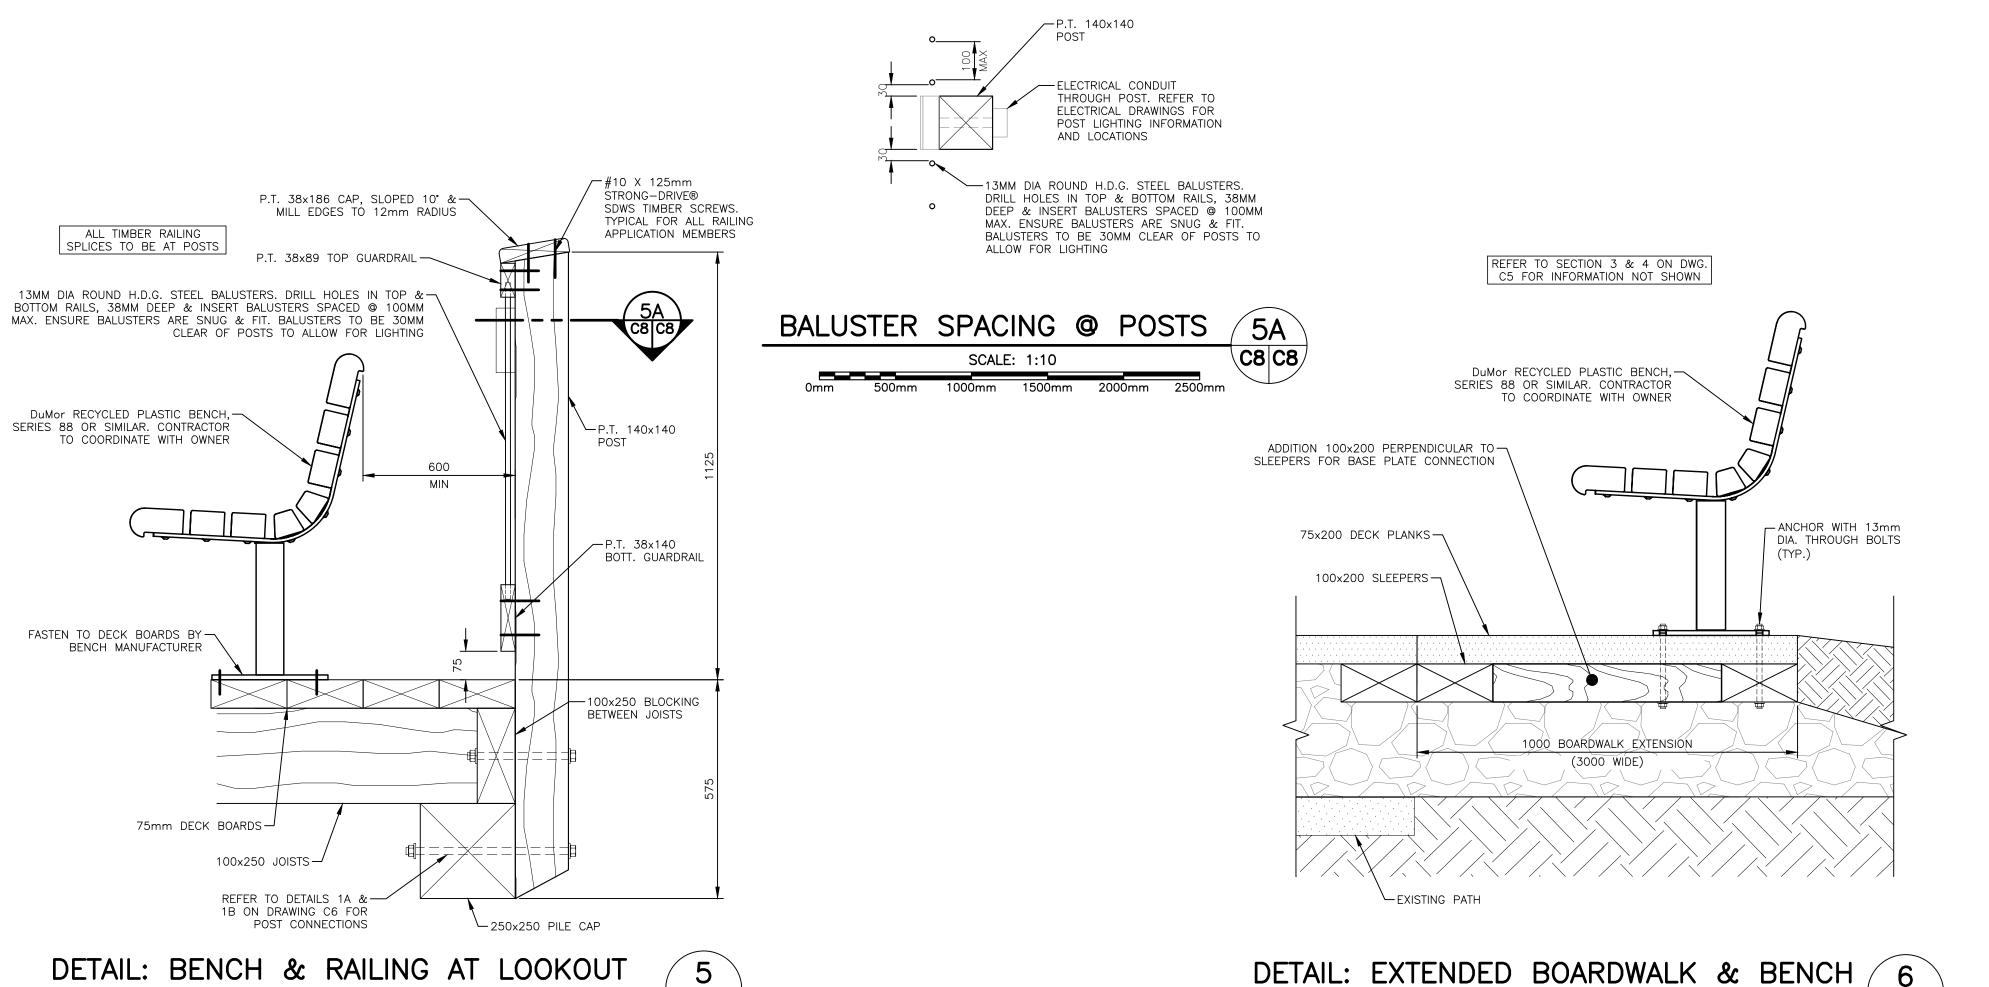

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ENVIRONMENTAL PROTECTION NOTES: GENERAL NOTES:

WORK EXECUTION: CONTRACTOR SHALL COORDINATE ALL WORK ACTIVITIES & COOPERATE WITH THE OWNER & AGENCIES HAVING JURISDICTION.

2. <u>SITE INSPECTION</u>: CONTRACTOR MUST VISIT THE SITE & BE FAMILIAR WITH EXISTING CONDITIONS.

3. <u>SITE COORDINATION</u>: VERIFY ALL DIMENSIONS & REPORT

4. <u>CONSTRUCTION SEQUENCE:</u> TO BE PROPOSED BY THE

5. <u>UNIT OF MEASURE</u>: ALL DIMENSIONS & ELEVATIONS ARE IN

6. TOPOGRAPHIC SURVEY: TOPOGRAPHIC SURVEY DATA WAS

CONTRACTOR FOR REVIEW BY THE OWNER & CONSULTANT

GATHERED & COMPILED BY BERNARD LAND SURVEYORS,

GEOTECHNICAL INVESTIGATION: A SUBSURFACE

8. <u>SPECIFICATIONS</u>: THESE DRAWINGS SHALL BE VIEWED IN

UTILITIES & SERVICES (SHOWN OR NOT SHOWN ON DRAWINGS) IN

CONJUNCTION WITH THE CONTRACT DOCUMENTS &

EXISTING UTILITIES: PRIOR TO COMMENCING WORK,

VERIFY EXACT LOCATION & ELEVATIONS OF ALL EXISTING

PRIOR TO START OF CONSTRUCTION.

PROJECT NO. 22-126, DATED 08 AUG 2022.

REPORT RECOMMENDATIONS.

SPECIFICATIONS.

REGULATIONS.

TO WORKERS & PUBLIC.

WITH THE WORK.

ANY DISCREPANCIES TO THE CONSULTANT BEFORE PROCEEDING

FIRST STEP IN THE CONSTRUCTION SEQUENCE, THEIR DESIGN, INSTALLATION AND MAINTENANCE SHALL BE AS PER PEI DTI'S ENVIRONMENTAL PROTECTION PLAN & PROJECT SPECIFICATIONS.

2. CONSTRUCT & INSTALL AT TOE OF SLOPE AROUND PERIMETER OF ALL TEMPORARY & PERMANENT

CONSTRUCTION AREAS INCLUDING AROUND STOCKPILES OF FILL SILT FENCES & EROSION CONTROL DEVICES. ALL ENVIRONMENTAL CONTROLS (E.G. SILT FENCING, CHECK

AVOID MIGRATION OF SILT OFFSITE. 3. ENSURE THAT RUNOFF IS DIRECTED THROUGH SEDIMENT COLLECTION PONDS. 4. INSTALL A LAYER OF MULCH OR AN EROSION CONTROL BLANKET TO ALL EXPOSED SLOPES THAT IS NOT IMMEDIATELY

DAMS, SEDIMENT COLLECTION PONDS, ETC.) SHALL BE IN

PLACE PRIOR TO, DURING AND AFTER PROJECT ACTIVITIES TO

EMERGENCY RESPONSE PHONE NUMBERS AND CONTACTS TO

CONTAMINATION SHOULD A SPILL OCCUR. MAINTAIN PROPER

ISSUE OF CSA G40.21 WITH A YIELD STRENGTH OF 350 MPa.

ALERT THE APPROPRIATE AUTHORITIES OF POSSIBLE

UNDER CONSTRUCTION APPLIED & MAINTAINED UNTIL THE AREA IS READY TO BE COMPLETED, SHAPED AND STABILIZED WITH SEEDING, SOD OR RIP-RAP.

INVESTIGATION WAS CARRIED OUT BY JOOSE ENVIRONMENTAL GEOTECH DIVISION, REPORT NO. JE0623, DATA 02 SEPTEMBER 5. SEED/SOD ALL EXPOSED AND BARREN SOIL AS SOON AS 2022. CARRY OUT SITE PREPARATION IN ACCORDANCE WITH POSSIBLE. 6. THE CONTRACTOR IS TO HAVE ON HAND, THE APPROPRIATE

STEEL NOTES:

SPILL KIT ONSITE.

THE FIELD WITHIN THE CONTRACT LIMIT. INFORMATION SHOWN ON PLANS IS APPROXIMATE ONLY. 1. ALL MISCELLANEOUS STEEL HALL CONFORM TO THE LATEST

10. <u>UNDERGROUND SERVICES</u>: WATER, SEWER, TELEPHONE & POWER SERVICES MAY EXIST BENEATH CITY STREETS. LOCATE 2. ALL STEEL SECTIONS SHALL BE CUT FROM FULL LENGTH ALL SERVICES PRIOR TO START OF CONSTRUCTION. EXERCISE STOCK OR ORDERED CUT TO LENGTH. CAUTION IN EXCAVATION & PROTECT FACILITIES FROM DAMAGE.

3. ALL STEEL COMPONENTS SHALL BE HOT DIPPED CARRIED OUT TO THE SATISFACTION OF THESE AUTHORITIES. GALVANIZED (270G/M2). CONTACT UTILITIES BEFORE EXCAVATING.

11. TEMPORARY SUPPORT: PROVIDE TEMPORARY SUPPORT TO UTILITY POLES AS REQUIRED BY THE UTILITIES. FINAL LOCATIONS OF RELOCATED UTILITY POLES TO BE CO-ORDINATED ON-SITE BTWN CONTRACTOR & UTILITIES. ENSURE NEW OVERHEAD WIRE PATHS MEET ALL REQUIRED CLEARANCES TO OH&S

REPAIR DAMAGES AT NO COST TO THE OWNER. WORK SHALL BE

12. CODES & STANDARDS: ALL WORK SHALL BE IN ACCORDANCE W/ THE 2015 NATIONAL BUILDING CODE OF CANADA & APPLICABLE STANDARDS. ALL SOIL MATERIALS AND PAVEMENT TO CONFORM TO PEI DEPT OF TRANSPORTATION AND INFRASTRUCTURE GENERAL PROVISIONS CONTRACT SPECIFICATIONS FOR HIGHWAY CONSTRUCTION.

13. REGULATIONS: PERFORM WORK & COMPLY WITH ALL FEDERAL, PROVINCIAL & MUNICIPAL BY-LAWS AND REGULATIONS.

14. <u>MATERIAL TESTING</u>: CONTRACTOR TO RETAIN THE SERVICES OF CERTIFIED MATERIAL TESTING LABORATORY TO TEST SOIL, CONCRETE, PAVEMENT & OTHER MATERIAL AS PER APPLICABLE STANDARDS.

15. <u>TRAFFIC</u>: MAINTAIN TWO WAY TRAFFIC ON CITY STREETS AT ALL TIMES DURING THIS CONTRACT.

16. SIGNS & BARRICADES: PROVIDE SIGNS, BARRICADES, FLAGGERS, TRAFFIC CONTROL AS REQUIRED TO ENSURE SAFETY

17. TEMPORARY UTILITIES: CONTRACTOR IS FINANCIALLY RESPONSIBLE FOR SUPPLY & MAINTENANCE OF TEMPORARY SANITARY FACILITIES, WATER SUPPLY, ELECTRICAL & OTHER SERVICES REQUIRED DURING THE CONSTRUCTION.

18. TEMPORARY FACILITIES: WHERE REQUIRED, PROVIDE TEMPORARY SECURE FACILITIES TO STORE MATERIAL & EQUIPMENT DURING CONSTRUCTION PERIOD.

19. EXCAVATION & BACKFILLING: ALL MATERIAL AND PEI DEPT OF TRANSPORTATION & INFRASTRUCTURE "GENERAL PROVISIONS and CONTRACT SPECIFICATIONS FOR HIGHWAY CONSTRUCTION".

20. TRENCHES: ALL TRENCHES WITHIN CITY RIGHT OF WAYS MUST BE BACKFILLED AT THE END OF EACH DAY.

21. <u>ASPHALT PAVEMENT</u>: ALL MATERIAL & EXECUTION SHALL BE IN ACCORDANCE WITH PEI DTI SPECIFICATIONS. REINSTATE DISTURBED ASPHALT PAVEMENT DAMAGED BY WORK OF

GRASSED & LANDSCAPED AREAS DAMAGED BY WORK OF 23. REINSTATEMENT: REPAIR & REINSTATE ALL DISTURBED SURFACES, GRASSED & LANDSCAPED AREAS, SIGNS, ETC.,

22. <u>TOPSOIL AND SODDING</u>: APPLY 6" TOPSOIL TO SURFACES TO BE LANDSCAPED & SOD. REPAIR & REINSTATE ALL DISTURBED

DAMAGED BY WORK OF CONTRACT INCLUDING ALL AREAS IMPACTED BEYOND LIMIT OF CONTRACT. 24. <u>CLEANING</u>: CLEAN ALL NEW & EXISTING SURFACES, EQUIPMENT, MATERIAL WITHIN THE LIMIT OF THE CONTRACT TO

25. WASTE MANAGEMENT: REMOVE & DISPOSE OF ALL WASTE MATERIAL IN A SAFE MANNER AT APPROVED DISPOSAL SITES.

THE SATISFACTION OF THE OWNER & CONSULTANT.

1. INSTALLATION OF ENVIRONMENTAL CONTROLS SHALL BE A

3. WITHIN 48 HRS OF DOING DITCHING WORK, OR AS DIRECTED

BY THE ENGINEER, ALL EXPOSED SOILS WILL BE EITHER SEEDED OR RECEIVE STRAW/HAY MULCH APPLICATION. 4. DITCHING SHALL NOT BE DONE PRIOR TO MAY 1 OR AFTER SEPTEMBER 30 WITHOUT WRITTEN APPROVAL FROM EMS. 5. EFFORTS TO REDUCE THE TURBIDITY OF WATER PUMPED FROM WORK AREAS WILL BE IMPLEMENTED. PRIOR TO FINAL DISCHARGE, THROUGH THE USE OF FILTRATION THROUGH VEGETATION, EROSION CONTROL DEVICES SUCH AS SEDIMENT COLLECTION PONDS, CHECK DAMS OR OTHER

ERODIBLE SOIL SHALL NOT REMAIN EXPOSED FOR LONGER

WILL BE SUSPENDED DURING AND IMMEDIATELY AFTER

INTENSE RAINSTORMS AND DURING PERIOD OF HIGH

2. WORK WILL BE COMPLETED AS SOON AS POSSIBLE, AND

EROSION & SEDIMENT CONTROL MEASURES

DEVICES.

GENERAL REQUIREMENTS

THAN ABSOLUTELY NECESSARY

DO NOT REMOVE OR DISTURB ANY VEGETATION BEYOND THE LIMITS OF WORK. 2. STABILIZE ACCESS ROADS AS SOON AS POSSIBLE AFTER

BEING DISTURBED 3. EROSION CONTROL MEASURES MUST BE CHECKED AND MAINTAINED ON A REGULAR BASIS (DAILY AND AFTER HEAVY

4. ALL MEASURES SHALL BE TAKEN BY THE CONTRACTOR TO MINIMIZE THE TRANSPORT OF SEDIMENT FROM THE

CONSTRUCTION SITE ANY MUD OR DEBRIS THAT IS CARRIED OFFSITE AND ONTO THE PUBLIC ROADWAY MUST BE CLEANED OFF AT THE END

OF EACH WORKDAY. FAILURE TO COMPLY WITH THE EROSION AND

SEDIMENTATION CONTROLS MAY RESULT IN A STOP WORK ORDER UNTIL ADEQUATE MEASURES HAVE BEEN CORRECTED.

EROSION CONTROL MEASURES SHALL NOT BE REMOVED UNTIL THE SITE IS STABLE AND VEGETATION IS ESTABLISHED, UNLESS OTHERWISE DIRECTED BY THE ENGINEER. 8. A SPILL CONTAINMENT KIT SHALL BE ONSITE AT ALL TIMES

WHILE HEAVY EQUIPMENT IS ONSITE. 9. ANY CONCERNS OR EMERGENCIES RELATED TO EROSION AND SEDIMENTATION FROM THE SITE SHALL BE DIRECTED TO THE ENGINEER.

TIMBER NOTES:

ALL WOOD STRUCTURAL MEMBERS, ASSEMBLIES AND FASTENERS SHALL CONFORM TO THE REQUIREMENTS OF CSA STANDARD 086.1 (LATEST EDITION).

2. ALL LUMBER SHALL BE IDENTIFIED BY THE GRADE MARK IN ACCORDANCE WITH THE MARKING PROVISIONS OF CSA STANDARD 0141.

3. ALL LUMBER (U.N.O.) SHALL BE PRESSURE TREATED, STRUCTURAL GRADE DRY, SPF NO. 1 MINIMUM, MOISTURE CONTENT NOT GREATER THAN 19% AT INSTALLATION.

4. ALL PLYWOOD SHALL BE EXTERIOR GRADE DOUGLAS FIR PLYWOOD TO CSA 0121 AND MANUFACTURED WITH WATERPROOF GLUE.

5. ALL FASTENERS AND METAL IN CONTACT WITH PRESSURE TREATED LUMBER SHALL BE HOT DIPPED GALVANIZED OR APPROVED EQUAL.

ALL BOARDWALK TIMBER SHALL BE MARINE GRADE PRESSURE TREATED EASTERN HEMLOCK (U.N.O.). MINIMUM NO.1 GRADE

ROUGH SAWN LUMBER MAY NOT EXCEED LIPS GREATER THAN 3mm OF ADJACENT BOARDS, TO ENSURE NO TRIPPING HAZARDS ARE PRESENT AFTER CONSTRUCTION IS COMPLETE

8. ALL MODIFIED PRESSURE TREATED LUMBER (CUT, CORED,

NOTCHED, ETC.) MUST RECEIVE A MINIMUM OF TWO COATS

OF WOOD PRESERVATION PRIOR TO INSTALLATION

1. ALL CONCRETE IN ACCORDANCE WITH CSA A23.1 AND NBCC. MIX DESIGN: TYPE 10 PORTLAND CEMENT MINIMUM COMPRESSIVE STRENGTH 32Mpa @ 28 DAYS:

 CLASS OF EXPOSURE:C-2 NOMINAL AGGREGATE SIZE: 20mm SLUMP: 80mm ±20

 AIR CONTENT: 6%-8% ALL TESTING SHALL CONFORM TO CSA A23.2. RECORD TESTS FOR SLUMP, AIR CONTENT AND COMPRESSIVE STRENGTH.

NO CONCRETE SHALL BE POURED WITHOUT THE PRIOR KNOWLEDGE AND APPROVAL OF ENGINEER. 4. CONCRETE PROTECTIVE COVER (EXCEPT AS NOTED): POURED AGAINST GROUND: 3" (75mm) • FORMED SURFACE AGAINST GROUND: 2" (50mm)

 FORMED SURFACE EXPOSED TO WEATHER: 2" (50mm) CONSTRUCTION SCHEDULE:

1. THE CONSTRUCTION ACTIVITIES SHALL START AS SOON AS

AUTHORIZED AND CONTRACT IS AWARDED. 2. CONSTRUCTION SHALL BE SUBSTANTIALLY COMPLETED ON

OR BEFORE 01 JULY 2023. 3. REFER TO REQUIREMENTS OF ENVIRONMENTAL PERMIT STRAW BALE CHECK DAMS

PROVIDE STRAW BALE CHECK DAMS FOR DITCHES WITH LESS THAN 2% GRADIENTS. AL SILT FENCES AND BARRIERS SHOULD BE INSPECTED FOR BREACHES AFTER EACH RAINFALL AND AT LEAST DAILY DURING PERIODS OF PROLONGED RAINFALL.

RIRAP CHECK DAMS

PROVIDE RIPRAP CHECK DAMS FOR DITCHES WITH STEEP THAN 2% GRADIENTS. CHECK DAMS TO REMAIN IN A FUNCTIONAL CONDITION UNTIL THE GRASS ON SEEDED SLOPES IS SUFFICIENTLY ESTABLISHED TO BE AN EFFECTIVE DETERRENT TO

SEDIMENT RUNOFF. SEDIMENT DEPOSITS SHALL BE REMOVED BEFORE THE LEVEL OF SEDIMENTATION REACHES A POINT WITHIN 100mm OF THE CREST OF THE OVERFLOW

SEDIMENT TRAPS / PONDS

SEDIMENT TRAPS AND SEDIMENT COLLECTION PONDS SHALL BE CONSTRUCTED PRIOR TO INITIAL GRUBBING AND EXCAVATION OF A WORK SITE AND SHALL REMAIN IN USE UNTIL THE DISTURBED AREA IS PROTECTED AGAINST EROSION BY PERMANENT STABILIZATION. SEDIMENT TRAPS / PONDS SHALL BE SIZED FOR A MINIMUM STORAGE VOLUME OF 75 CM PER HECTARE OF

CONTRIBUTING DISTURBED AREA. THIS MAY RESULT IN MULTIPLE SEDIMENT TRAPS/PONDS THROUGHOUT THE DEVELOPMENT AREA. WHEN A PERMANENT STORM WATER DETENTION POND WILL BE CONSTRUCTED FOR THE SUBDIVISION, 50% OF THE

STORAGE VOLUME FROM THE SEDIMENT TRAPS/POND: SHALL BE LOCATED IMMEDIATELY UPSTREAM OF THE DETENTION POND TO MINIMIZE THE AMOUNT OF SEDIMENT BUILD-UP IN THE DETENTION POND THE REMAINDER OF THE STORAGE VOLUME OF THE SEDIMENT TRAPS/PONDS MAY BE LOCATED THROUGHOUT THE DEVELOPMENT AREA WITHIN

THE DITCHES. 4. SEDIMENT TRAPS AND SEDIMENT COLLECTION PONDS SHALL BE INSPECTED REGULARLY AND AFTER RAINFALLS OF 5mm OR MORE. ANY DAMAGED AREAS SHALL BE REPAIRED.

SOIL STABILIZATION

COMPLETED.


1. TOP AND OUTSIDE OF SLOPES OF THE EARTHEN EMBANKMENTS SHALL BE HYDRO SEEDED AND COVERED WITH JUTE MAT IMMEDIATELY AFTER INSTALLATION.

SEEDING SHALL BE CARRIED OUT WITHIN 48 HRS OF COMPLETING SURFACE PREPARATION, OR AS SOON AS POSSIBLE AFTER COMPLETING SURFACE PREPARATION. IN STEEP AREAS, SUCH AS ROAD SIDE SLOPES, THE SEED


MUST BE COVERED WITH MULCH OR AN EROSION CONTROL MAT SO THAT THE SEED REMAINS IN PLACE DURING ITS GERMINATION PERIOD. MULCHED AREAS SHALL BE INSPECTED REGULARLY AND


AFTER RAIN OF 5mm OR MORE ACCUMULATION, REPAIRED AS REQUIRED UNTIL THE AREA HAS STABILIZED. 5. SOD SHALL BE LAID DURING THE GROWING SEASON. SODDING SHALL NOT OCCUR DURING DRY SUMMER

PERIODS, AT FREEZING TEMPERATURES, OR OVER FROZEN 6. ALL SODDED AREAS SHALL BE WATERED THROUGHOUT THE GROWING SEASON OF THE YEAR IN WHICH SODDING WAS

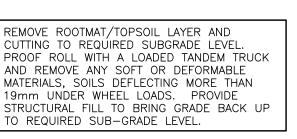


NOTE: SUBGRADE/SUBBASE TO BE COMPACTED TO 98% SPMD AND BASE LAYERS TO BE COMPACTED TO 100% SPMD.

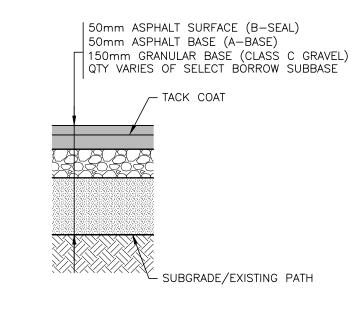


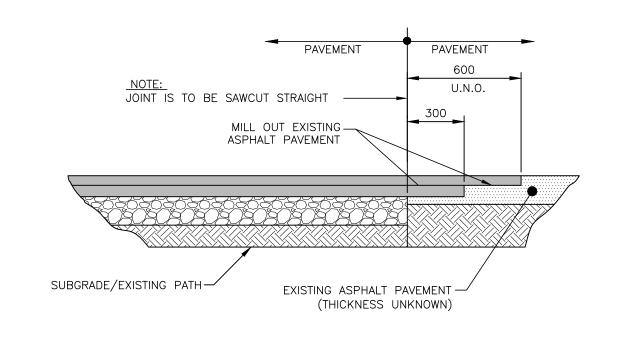

ASPHALT: PAVEMENT SCHEDULE

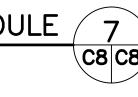


ASPHALT: PAVEMENT JOINT AT EXIST./NEW / 8

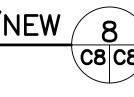



SCALE: 1:10


500mm 1000mm 1500mm 2000mm 2500mm

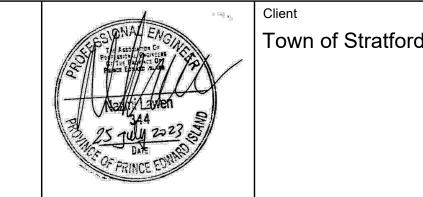

Project Title Stratford Waterfront Gathering & Event Space

Typical Sections, Details & Notes


Description Date Date: 2023-07-25 Issued for Tender 2023-07-25 Drn By: SPB Chk By: NL, P.Eng Project Number: 221122 **Drawing Number:**

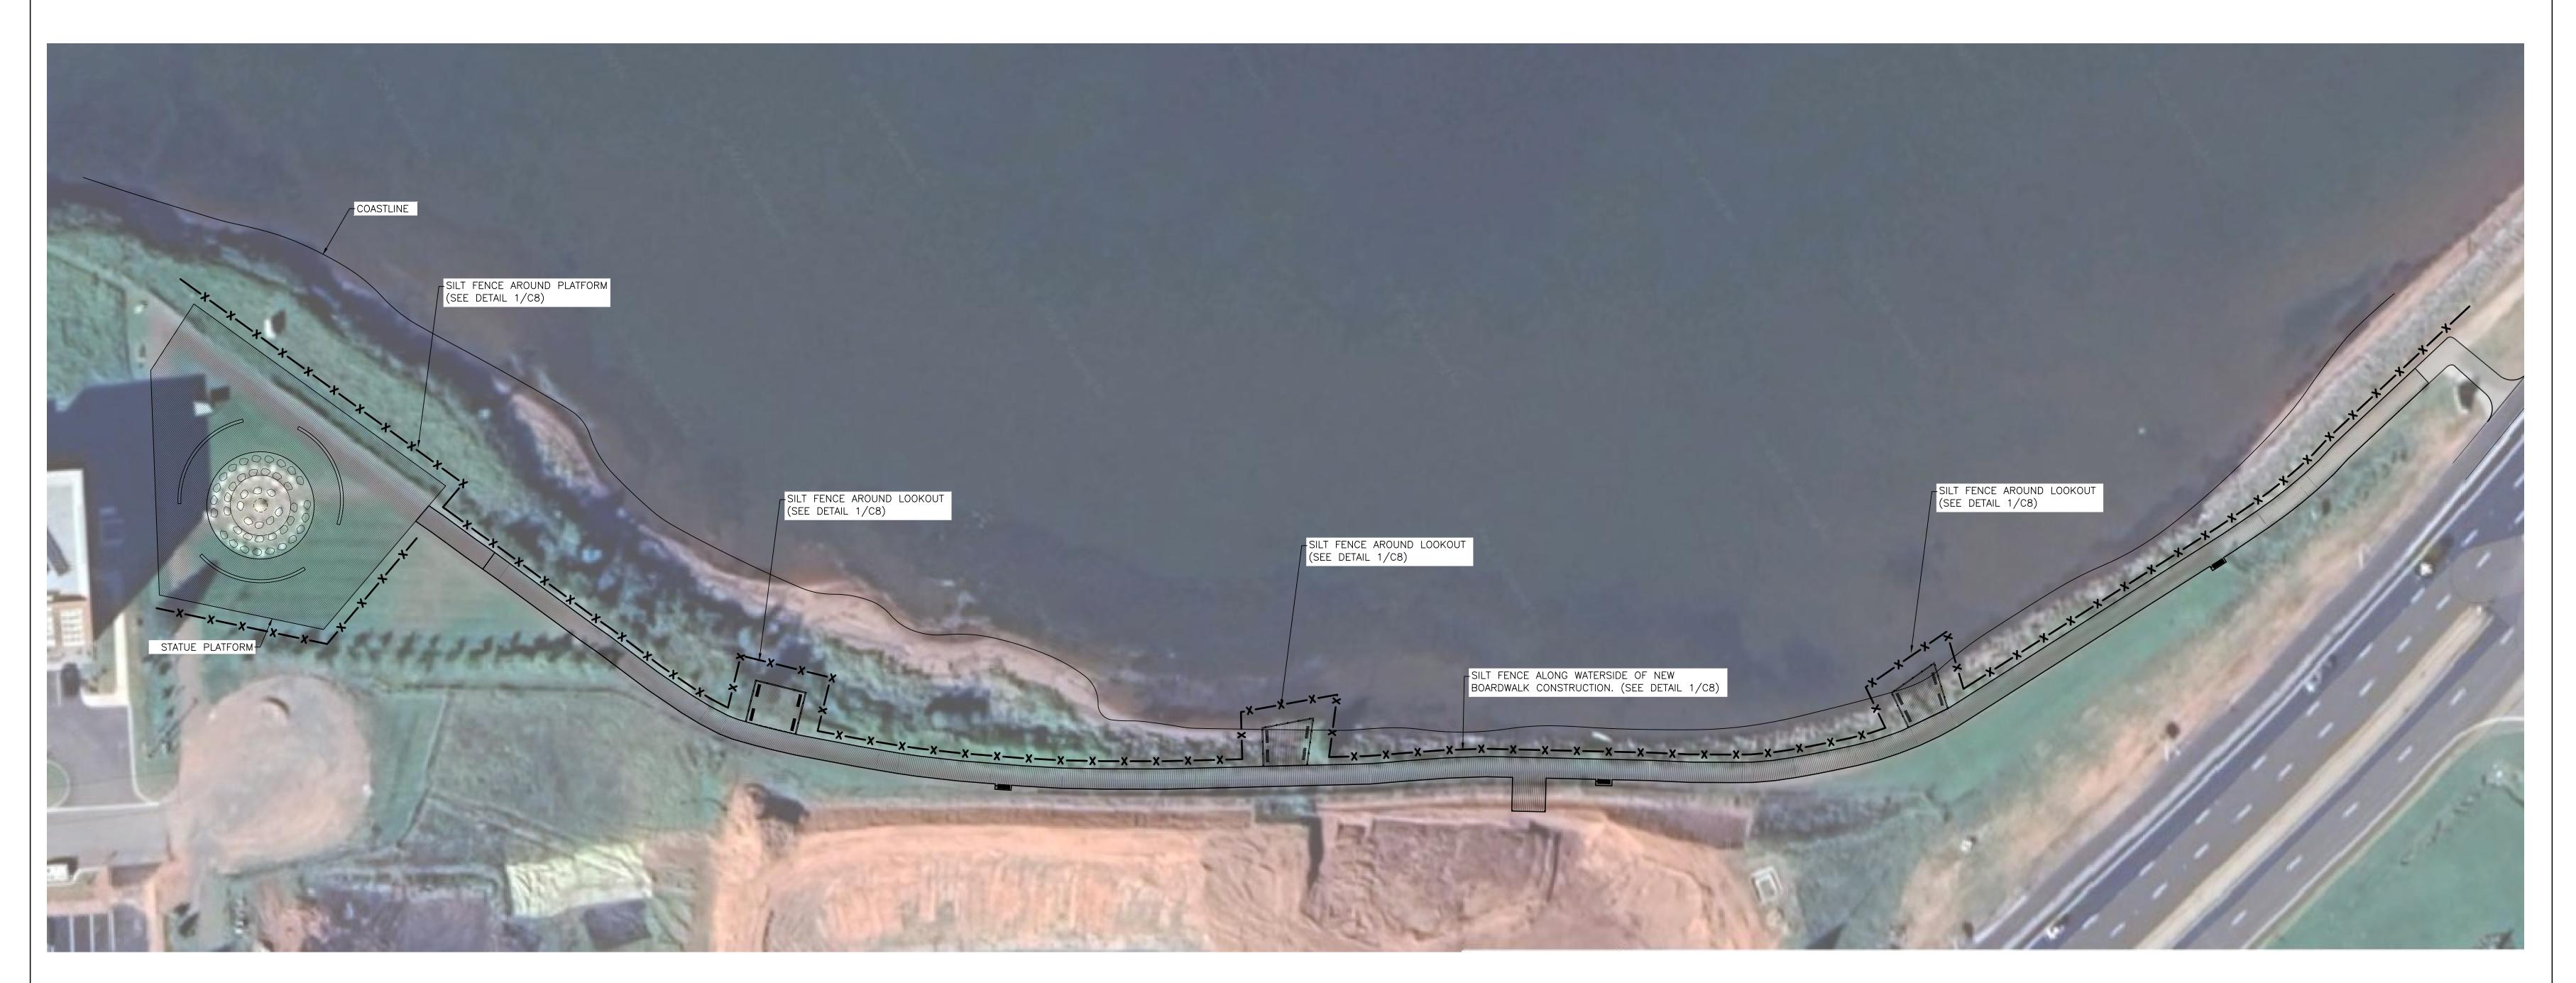

1 AERIAL PLAN: STRATFORD BOARDWALK

(c) (c) (c) (c) (1:400)



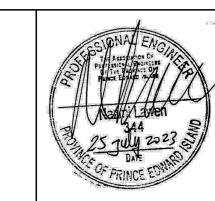

Town of Stratford

Stratford Waterfront Gathering & Event Space

Project Title

Erosion Control Plan

Sheet Title

No. Description

Date

Date: 2023-07-25

Drn By: SPB

Chk By: NL, P.Eng

Project Number:

221122

Drawing Number:

C9

ELECTRICAL SPECIFICATIONS

1. GENERAL CONDITIONS

- 1.1. TENDER REQUIREMENTS, THE PROJECT CONTRACT, RELATED DOCUMENTATION AND GENERAL REQUIREMENTS GOVERN THE WORK OF THIS CONTRACT/TRADE.
- 1.2. ALL ELECTRICAL WORK IS TO BE CARRIED OUT BY QUALIFIED, LICENSED ELECTRICIANS OR APPRENTICES FOR THE PROVINCE OF PRINCE EDWARD ISLAND AND THE ELECTRICAL CONTRACTOR MUST HAVE A VALID CONTRACTOR LICENSE ISSUED BY THE PROVINCE OF PRINCE EDWARD ISLAND
- 1.3. ELECTRICAL CONTRACTOR TO FURNISH ALL LABOUR, MATERIALS, TOOLS AND EQUIPMENT REQUIRED TO COMPLETE ALL WORK SHOWN ON THE DRAWINGS AND HEREIN SPECIFIED. THE WORK IS TO BE IN ACCORDANCE WITH RULES AND REGULATIONS OF ALL AUTHORITIES HAVING LEGAL JURISDICTION OVER THE WORK. PROVIDE ANY SMALL ITEMS OF WORK NOT SPECIFICALLY CALLED FOR BUT REQUIRED TO COMPLETE THE INTENDED INSTALLATION.
- 1.4. THE TERM "OWNER" TO HEREIN AFTER REFER TO THE TOWN OF STRATFORD. THE TERM "ENGINEER" TO HEREIN AFTER REFER TO COLES ASSOCIATES LTD.
- 1.5. THE ENGINEER RESERVES THE RIGHT TO APPROVE THE QUALITY OF MATERIAL AND WORKMANSHIP, AND TO CALL FOR ANY TESTS WHICH THEY DEEM NECESSARY TO ESTABLISH THE INTEGRITY OF THE INSTALLATION DURING THE PROGRESS OF THE WORK AND A COMPLETE TEST OF EACH SYSTEM AT THE COMPLETION OF THE WORK. THE COST OF SUCH TESTS ARE NOT TO BE CONSIDERED AS EXTRAS.

2. <u>DESCRIPTION OF WORK</u>

- 2.1. THE WORK IS TO CONSIST OF, BUT NOT BE LIMITED TO, THE FOLLOWING:
- 2.1.1. POWER DISTRIBUTION INCLUDING UNDERGROUND BRANCH CIRCUIT WIRING
- 2.1.3. ALL EXCAVATION, ENVIRONMENTAL CONTROLS TRENCHING AND ASSOCIATED SITE REMEDIATION. COORDINATE WORK WITH GENERAL CONTRACTOR.
- 2.1.4. LIGHTING, INCLUDING LIGHT STANDARDS AND CONCRETE BASES, POST LIGHTING, STATUES AND BENCH LIGHTING
- 2.1.5. ALL CABLE AND CONDUIT INSTALLATION
- 2.1.6. ALL NECESSARY CONNECTIONS FOR A COMPLETE SYSTEM

- 3. CODES, PERMITS AND INSPECTION
- 3.1. ALL WORK IS TO BE IN ACCORDANCE WITH THE LATEST ADOPTED EDITION OF THE CANADIAN ELECTRICAL CODE (CSA 22.1-21)
- 3.2. ELECTRICAL CONTRACTOR TO BE RESPONSIBLE FOR AND IS TO OBTAIN ALL PERMITS, INSPECTIONS, ETC. AS REQUIRED BY ALL AUTHORITIES HAVING JURISDICTION OVER THIS WORK AND IS TO PAY FOR SAME. THESE COSTS ARE TO BE INCLUDED IN THE TENDER PRICES. ALL PERMITS ARE TO BE DELIVERED TO THE PROJECT MANAGER AS SOON AS THEY BECOME AVAILABLE.
- 4.1. PREPARE AT OWN EXPENSE, ANY LARGE SCALE WORKING DRAWINGS WHICH MAY BE REQUIRED BY THE EXAMINING AUTHORITIES TO FACILITATE INSTALLATION

5. SHOP DRAWINGS

5.1. SUBMIT SHOP DRAWINGS OF ALL ELECTRICAL EQUIPMENT FOR REVIEW BY THE ENGINEER SHOP DRAWINGS ARE TO INCLUDE POWER DISTRIBUTION AND CONTROL EQUIPMENT; WIRING DEVICES; LIGHTING; LIGHTING CONTROL AND ALL ASSOCIATED REQUIRED EQUIPMENT, CONTRACTOR IS TO STAMP, SIGN AND DATE SHOP DRAWINGS PRIOR TO SUBMISSION AS PROOF OF THEIR APPROVAL, COORDINATION WITH FIELD MEASUREMENTS, AND COMPLIANCE WITH THE CONTRACT DOCUMENTS.

6. EXAMINATION OF SITE AND DRAWINGS

- 6.1. EXAMINE CIVIL AND ELECTRICAL DRAWINGS, VISIT THE SITE AND BECOME FAMILIAR WITH THE PROJECT. ANY DEVIATION AND/OR CONFLICTS ON THE PLANS OR SITE IS TO BE REPORTED TO THE ENGINEER PRIOR TO SUBMITTING TENDER, OTHERWISE IT WILL BE CONSIDERED THAT THEY HAVE BEEN ACCOUNTED FOR IN TOTAL TENDERED PRICE.
- 7. CONSTRUCTION SCHEDULE
- 7.1. COORDINATE AND PERFORM WORK TO MEET THE COMPLETION SCHEDULE, ANY OVERTIME WORK TO MEET THE COMPLETION SCHEDULE IS TO BE INCLUDED IN TOTAL TENDERED PRICE. TYPICAL DAY-TO-DAY USAGE AND ACCESS OF THE SITE AND CAMPUS FACILITIES TO BE MAINTAINED UNLESS OTHERWISE APPROVED BY THE OWNER.
- 8. <u>BILLINGS, REVISIONS AND EXTRAS</u>
- 8.1. BILLINGS FOR WORK ARE TO BE BROKEN DOWN INTO A NUMBER OF SUBSECTIONS TO INDICATE HOW VALUES WERE DERIVED. SUBMIT PROPOSED BREAKDOWN TO ENGINEER FOR APPROVAL, PRIOR TO FIRST BILLING. MATERIALS ON SITE TO BE SUPPORTED WITH
- 8.2. NO ADDITIONAL MONEY OVER THE CONTRACT PRICE WILL BE PAID UNLESS AN APPROVED CHANGE ORDER IS ISSUED. CLAIMS FOR EXTRAS MUST BE SUBMITTED WITH A COMPLETE BREAKDOWN OF MATERIAL, LABOUR, HOURLY RATES, ETC.
- 9. <u>CLEANUP</u>
- 9.1. REMOVE ALL WASTE PRODUCTS AND DEBRIS AND KEEP THE WORK AREA CLEAN AT ALL
- 9.2. PRIOR TO LEAVING SITE AT THE END OF EACH WORK DAY REMOVE SURPLUS PRODUCTS, TOOLS, CONSTRUCTION EQUIPMENT ETC.

10. EXISTING STRUCTURES AND SERVICES

- 10.1. CONTRACTOR TO BE RESPONSIBLE FOR ANY DAMAGE CAUSED BY CUTTING OR DISRUPTING EXISTING STRUCTURES OR SERVICES DESIGNATED TO REMAIN IN USE.
- 10.2. CONTRACTOR IS TO LOCATE AND COORDINATE WITH UNDERGROUND SERVICES BEFORE COMMENCING WORK.
- 10.3. NEW AND EXISTING UNDERGROUND SERVICES ARE TO BE RUN PARALLEL AND PERPENDICULAR TO EACH OTHER, MINIMUM VERTICAL AND/OR HORIZONTAL CLEARANCE

11. <u>ALTERATIONS</u>

- 11.1. PRIOR TO TENDER SUBMISSION, VISIT THE SITE AND SURVEY AND QUANTIFY THE EXTENT OF THE ALTERATIONS REQUIRED FOR THIS CONTRACT AND INCLUDE FOR ALL COSTS IN THE TOTAL TENDERED PRICE.
- 11.2. IN CONJUNCTION WITH SITE VISIT, REVIEW CIVIL AND ELECTRICAL DRAWINGS AND INCLUDE ALL COSTS DUE TO EXISTING CONDITIONS IN TOTAL TENDERED PRICE.

- 12.1. PLACE ORDER FOR ALL MATERIAL AND EQUIPMENT IMMEDIATELY AFTER SIGNING OF CONTRACT. SUBMIT A LIST OF DELIVERY DATES FOR EACH TYPE OF EQUIPMENT WITHIN FIVE (5) DAYS OF THE AWARD OF CONTRACT. THE LIST IS TO INCLUDE SUPPLIER'S AND MANUFACTURER'S NAMES. USE ONLY MATERIALS THAT CAN BE DELIVERED ON TIME TO MEET CONSTRUCTION SCHEDULE, OTHERWISE PROVIDE TEMPORARY AT NO COST TO
- 13. EQUIPMENT AND MATERIAL
- 13.1. ALL EQUIPMENT AND MATERIAL, UNLESS SPECIFICALLY NOTED OTHERWISE, IS TO BE NEW AND WITHOUT BLEMISH OR DEFECT. ALL MATERIAL AND EQUIPMENT ARE TO BE CERTIFIED BY A CERTIFICATION AGENCY WHICH IS ACCREDITED BY THE CANADIAN STANDARDS COUNCIL OF CANADA IN ACCORDANCE WITH THE REQUIREMENTS OF CSA STANDARDS OR OTHER RECOGNIZED DOCUMENTS AND HAVE ALL REQUIRED LABELS PERMANENTLY AFFIXED AND VISIBLE WHEN INSTALLED.

- 14.1. PANELBOARDS ARE TO BE BALANCED WITHIN 5%. MEASURE PHASE CURRENT TO PANELS WITH NORMAL LOADS OPERATING AT TIME OF ACCEPTANCE. ADJUST BRANCH CIRCUIT CONNECTIONS AS REQUIRED TO OBTAIN BEST BALANCE OF CURRENT BETWEEN PHASES. INCLUDE SIGNED AND DATED LOAD BALANCE SHEETS IN MAINTENANCE MANUALS.
- 14.2. TEST ALL SYSTEM GROUNDING CONDUCTORS FOR PHASE TO GROUND LOADS, AMMETER IS TO READ LESS THAN AMPERE. INCLUDE SIGNED AND DATED LOAD BALANCE SHEETS IN
- 14.3. ALL ELECTRICAL EQUIPMENT AND SYSTEMS TO BE COMMISSIONED BY ELECTRICAL CONTRACTOR, READY FOR USE BY OWNER

15. <u>DEMONSTRATION OF THE SYSTEM</u>

15.1. DEMONSTRATE THE FUNCTION AND OPERATION OF EACH SYSTEM TO THE ENGINEER AND

16. <u>IDENTIFICATION</u>

- 16.1. PROVIDE AND INSTALL LAMICOID IDENTIFICATION NAMEPLATES ON ALL ELECTRICAL EQUIPMENT, INCLUDING BUT NOT LIMITED TO PANELBOARD, COVER OF PULLBOXES, HANDHOLD COVER OF LIGHT STANDARDS, CONTACTOR, ETC. INDICATING THE LOAD SERVED, SYSTEM AMPERAGE, VOLTAGE, AND PHASING WHERE APPLICABLE.
- 16.2. LAMICOID NAMEPLATES ARE TO BE WHITE WITH BLACK ENGRAVED LETTERS AND ARE TO BE INSTALLED WITH CONTACT CEMENT TO EQUIPMENT ENCLOSURES, MECHANICAL FASTENERS TO PULLBOXES.
- 16.3. SERVICE RATED PANELBOARD IS TO HAVE A TYPEWRITTEN BREAKER DIRECTORY INDICATING THE LOAD CONNECTED TO EACH CIRCUIT. DIRECTORIES ARE TO BE MOUNTED ON THE INSIDE OF THE PANEL DOOR WITH A TRANSPARENT PLASTIC COVER.
- 16.4. EACH WIRE TO HAVE SELF-LAMINATING OR HEAT SHRINK STYLE CABLE MARKER INDICATING THE CIRCUIT NUMBER IT IS CONNECTED TO.

17. COORDINATION

- 17.1. BE RESPONSIBLE FOR COORDINATING THE INSTALLATION OF EQUIPMENT, CONDUIT AND CABLE WORK, LIGHTING FIXTURES, ETC. WITH OTHER TRADES PRIOR TO THE ACTUAL
- 18. ACCESSIBILITY
- 18.1. ALL WORK IS TO BE INSTALLED SO IT CAN BE READILY ACCESSIBLE FOR OPERATION, MAINTENANCE AND REPAIRS.
- 19. <u>RESPONSIBILITY</u>
- 19.1. BE RESPONSIBLE FOR WORK UNTIL THE COMPLETION AND FINAL ACCEPTANCE, INCLUDING REPLACING ANY ITEM THAT MAY BE DEFECTIVE, DAMAGED, LOST OR STOLEN WITHOUT ADDITIONAL COST TO THE OWNER OR DELAY TO THE COMPLETION OF THE PROJECT.

20. <u>WARRANTY</u>

20.1. WARRANT ALL WORK AND MATERIALS INSTALLED UNDER THIS CONTRACT, AGAINST ALL DEFECTS AND WORKMANSHIP FOR A PERIOD OF ONE (1) YEAR AFTER ACCEPTANCE OF SAME BY OTHERS.

21. FASTENINGS AND SUPPORTS

FOR ALL ELECTRICAL EQUIPMENT.

- 21.1. PROVIDE FASTENINGS AND SUPPORTS SPECIFICALLY DESIGNED TO SUPPORT THE LOAD
- 21.2. SPECIFIC PURPOSE HEAT TREATED, SPRING STEEL FASTENERS TO SUPPORT BOXES, CONDUIT AND CABLE FROM MAIN STRUCTURES.
- 22. CONDUIT AND FITTINGS
- 22.1. WHEN SHOWN, CONDUIT SIZES ARE TO BE AS INDICATED ON THE DRAWINGS AND ARE NOT TO BE REDUCED IN SIZE UNLESS APPROVAL IS OBTAINED FROM THE ENGINEER; OTHERWISE, SIZE CONDUIT TO CSA 22.1-21 REQUIREMENTS.
- 22.2. PVC CONDUIT TO BE USED UNDERGROUND AND IN CONCRETE SLAB WHERE ALLOWED BY SECTION 12 OF THE CSA 22.1-21. UNLESS OTHERWISE INDICATED, EXPOSED PVC WILL NOT
- 22.3. MINIMUM CONDUIT SIZE IS TO BE 1" UNLESS SPECIFICALLY OTHERWISE INDICATED.

22.4. PROVIDE LOW VOC MASTIC COMPOUND WEATHERPROOF SEAL WHERE CONDUITS PASS

23. OUTLET, PULL AND JUNCTION BOXES

- 23.1. BOXES TO BE CODE GAUGE STEEL, SIZED TO MEET CSA 22.1-21 REQUIREMENTS AND SUITABLE FOR THE TYPE OF CONSTRUCTION. USE CAST FS OR FD BOXES FOR SURFACE
- MOUNTED OUTLETS AS REQUIRED. 23.2. EXTERIOR BOXES TO BE WATERTIGHT.
- 23.3. PROVIDE PULL BOXES ON CONDUIT RUNS AT A MAXIMUM OF 100' INTERVALS.
- 23.4. BOXES TO BE SUPPORTED INDEPENDENT OF CONDUIT RUNS.

THROUGH EXPOSED EXTERIOR WALLS OR STRUCTURES.

- 24.1. ALL WIRES TO BE COPPER RW90, RATED 600V, INSTALLED IN CONDUIT UNLESS OTHERWISE INDICATED.
- 24.2. ALL WIRING TO BE SIZED TO MEET ALL REQUIREMENTS OF THE CSA 22.1-21. MINIMUM SIZE FOR BRANCH CIRCUIT WIRING TO BE #12 AND 14# FOR CONTROL WIRING UNLESS INDICATED OTHERWISE.
- 24.3. ALL WIRES TO BE NEW AND DELIVERED TO THE SITE OF THE PROJECT IN THEIR ORIGINAL PACKING. WIRES #8 AND LARGER TO BE STRANDED, #10 AND SMALLER TO BE SOLID. WIRES TO BE FACTORY IDENTIFIED SHOWING SIZE, VOLTAGE RATING AND INSULATION
- 24.4. NEUTRAL CONDUCTOR TO BE WHITE THROUGHOUT, THREE PHASE WIRES TO BE: ONE RED, ONE BLACK AND ONE BLUE.
- 24.5. WHERE COMMON NEUTRALS ARE USED ENSURE THAT CIRCUITS ARE FROM DIFFERENT
- 24.6. CABLES ARE TO BE INSTALLED WITHOUT SPLICES AND BE RUN CONTINUOUS FROM
- 24.7. TECK CABLES TO BE RATED FOR 600V WITH FT4 JACKET TO WIRE POST MOUNT LIGHTING FIXTURES OR WHERE INDICATED.

25. CONNECTORS FOR WIRES

SOURCE TO LOAD.

25.1. USE TWIST-ON PRESSURE TYPE WIRE CONNECTORS FOR #8 TO #14 SIZED WIRE CONNECTIONS. ACCEPTABLE MATERIAL: MARRETTE

WIRES AND FOR CONNECTING SOLID TO STRANDED CONDUCTORS.

- 25.2. USE CRIMP STYLE ALLOY WIRE CONNECTORS, NYLON INSULATED FOR #16 AND SMALLER
- 25.3. COMPRESSION TYPE CONNECTORS TO BE USED FOR CONNECTING #6 CONDUCTORS AND
- 25.4. USE GEL FILLED TWIST-ON CONNECTORS IN DAMP OR WET LOCATIONS. ACCEPTABLE MATERIAL: KING INNOVATION DRY CONN.

26. GROUNDING AND BONDING

- 26.1. ENTIRE ELECTRICAL SYSTEM TO BE GROUNDED AND BONDED IN ACCORDANCE WITH THE REQUIREMENTS OF THE CEC AND LOCAL AUTHORITIES.
- 26.2. ALL CONDUITS TO HAVE SEPARATE INSULATED BONDING CONDUCTOR.
- 26.3. ALL INSULATED GROUNDING AND BONDING WIRES TO HAVE GREEN JACKET.
- 27. SERVICE ENTRANCE
- 27.1. GENERAL CONTRACTOR IS RESPONSIBLE FOR ANY UTILITY COSTS FOR NEW SERVICE.
- 27.2. GENERAL CONTRACTOR IS RESPONSIBLE TO COORDINATE WITH UTILITY TO ENSURE AVAILABILITY OF SERVICE TO MEET CONSTRUCTION SCHEDULE AND ARRANGE AN ON SITE MEETING WITH SERVICE UTILITY TO OBTAIN THEIR APPROVAL FOR LAYOUT AND CONSTRUCTION DETAILS PRIOR TO INSTALLATION.
- 27.3. ELECTRICAL CONTRACTOR TO BE RESPONSIBLE TO SUPPLY AND INSTALL ALL CABLING AND CONDUIT FROM THE SECONDARY SIDE OF THE POLE MOUNTED UTILITY TRANSFORMER AS INDICATED. PRIMARY AND SECONDARY CONNECTIONS TO THE UTILITY TRANSFORMER ARE TO BE COMPLETED BY THE UTILITY.

- 28.1. PANELBOARD TO BE SERVICE RATED C/W MAIN BONDING OF THE AMPERAGE, VOLTAGE AND PHASING INDICATED ON THE DRAWINGS, COMPLETE WITH CIRCUIT BREAKERS AS
- 28.2. PANELBOARD TO BE SECURELY FASTENED TO THE WOODEN CROSS BRACING OF THE WOODEN POST AS INDICATED ON THE DRAWING, PANELBOARD TO BE C/W A TYPE 4x ENCLOSURE, HINGED DOOR, LATCH AND LOCK AND DIRECTORY, BAKED GREY ENAMEL
- 28.3. CIRCUIT BREAKERS TO HAVE THERMAL MAGNETIC TRIP PROTECTION WITH BIMETALLIC ELEMENTS FOR DELAY OVERLOAD PROTECTION. TWO POLE BREAKERS TO HAVE INTERNAL COMMON TRIP. BREAKERS ARE TO BE BOLT-IN FIELD INTERCHANGEABLE, 10
- 28.4. CIRCUIT BREAKERS TO BE BY THE SAME MANUFACTURER AS THE PANELBOARD IN WHICH THEY ARE BEING INSTALLED. BREAKERS MUST BE NEW, COMPLETE WITH ORIGINAL FACTORY WARRANTY AND SUPPLIED FROM AN AUTHORIZED MANUFACTURER'S

28.5. ACCEPTABLE MATERIAL: SQUARE D, SIEMENS, EATON.

- 29.1. DUPLEX CSA TYPE 5-15R GROUND FAULT CIRCUIT INTERRUPTER (GFCI) RECEPTACLES TO BE WHITE, DECORA, COMMERCIAL SPECIFICATION GRADE, NYLON FACEPLATE C/W 0.025 SECONDS TRIP-TIME. 10.000A MAXIMUM INTERRUPTING CAPACITY INTEGRAL TEST BUTTON AND INDICATOR LIGHT. ACCEPTABLE MATERIAL: COOPER #VGF15-W, HUBBELL
- 29.2. PROVIDE CIRCUIT IDENTIFICATION AT ALL WIRING DEVICES USING PRE-PRINTED THERMAL NON-SMEAR LABELS, CLEAR VINYL WITH BLOCK LETTERING, ATTACHED TO COVER PLATE. WHITE VINYL LABELS WILL NOT BE ACCEPTED.
- 29.3. RECEPTACLES DESIGNATED AS WEATHERPROOF TO BE GFCI TYPE C/W SPRING LOADED GASKETTED WHILE-IN-USE COVERS. ACCEPTABLE MATERIAL: HUBBELL TAYMAC ML SERIES; PASS & SEYMOUR #WIUC1OSG.

- 30.1. PROVIDE LUMINAIRES C/W DRIVERS AS INDICATED IN THE LUMINAIRE SCHEDULE ON


#GFRST15WNL; LEVITON #N7599-W; PASS & SEYMOUR #1595W.


- 30.2. CO-ORDINATE THE EXACT MOUNTING AND LOCATION OF LUMINAIRES. 30.3. ALIGN LUMINAIRES IN CONTINUOUS ROWS TO FORM STRAIGHT UNINTERRUPTED LINE.
- 30.4. PROVIDE TIME CLOCK AND LIGHTING CONTACTOR AS REQUIRED FOR CONTROLLING STATUE, BENCH AND POST LIGHTING FIXTURES. REFER TO DETAIL 2/E4 FOR ADDITIONAL


31. MAINTENANCE MANUALS

INFORMATION.


- 31.1. AT COMPLETION OF CONTRACT PROVIDE THREE (3) COPIES OF MAINTENANCE MANUALS TO GENERAL REQUIREMENTS. INCLUDE ALL SHOP DRAWINGS, CERTIFICATES, TEST SHEETS, GUARANTEES, WARRANTEES AND MAINTENANCE INFORMATION NAME, ADDRESS AND TELEPHONE NUMBER OF CONTRACTOR, PLUS NAMES, ADDRESSES AND TELEPHONE NUMBERS OF DISTRIBUTORS, MANUFACTURERS, AND SUPPLIERS OF EQUIPMENT.
- THE PLANS FOR THE WORK ACCOMPANYING THESE SPECIFICATIONS ARE MADE AS ACCURATELY AS POSSIBLE, BUT ABSOLUTE ACCURACY OF DIMENSIONS CANNOT BE GUARANTEED. THEY ARE INTENDED TO SUPPLEMENT AND SIMPLIFY THE GENERAL CONTRACT DRAWINGS. NO CLAIMS FOR EXTRA PAYMENT ON ACCOUNT OF THE
- DIFFERENCE OF ACTUAL AND ESTIMATED DIMENSIONS WILL BE ALLOWED. EXACT LOCATION OF ALL ELECTRICAL WORK TO BE DETERMINED WITH ARCHITECTURAL FLOOR PLANS, FURNITURE AND EQUIPMENT LAYOUTS PRIOR TO ANY INSTALLATION
- THE PLANS LISTED BELOW FORM AN INTEGRAL PART OF THIS SPECIFICATION: E1 - ELECTRICAL SPECIFICATIONS, LEGEND & DETAILS
- E2 ELECTRICAL SITE PLAN, TRENCHES & DETAILS E3 - STATUE & LOOKOUT DECK PLANS, ELEVATIONS & DETAILS E4 - SERVICE ENTRANCE DETAIL, SCHEMATICS & SCHEDULES

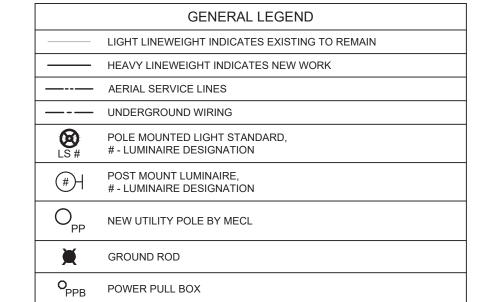

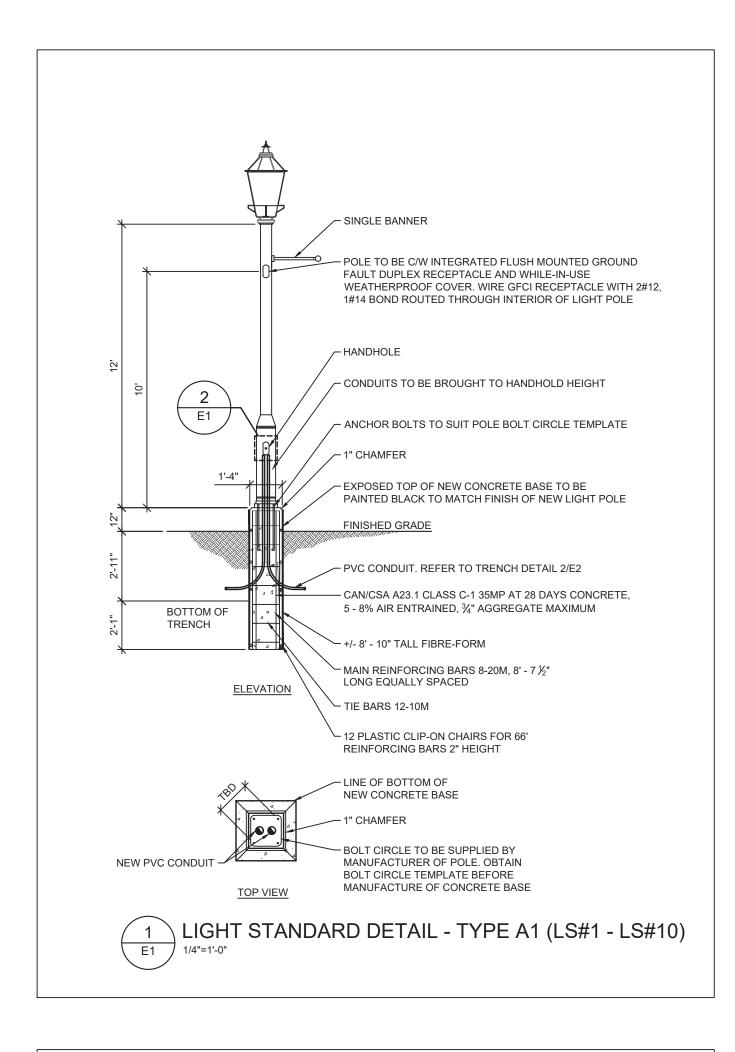

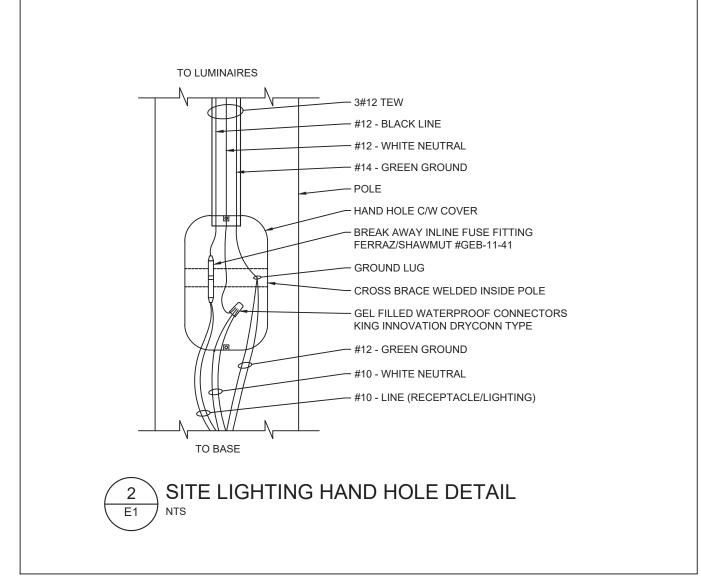



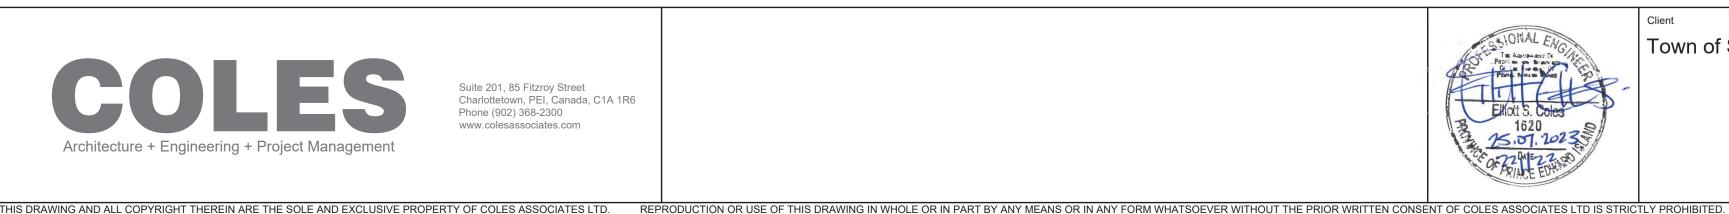


Stratford Waterfront

Electrical Specifications, Legend & Details


Revision Description Date: 2023-07-25 0 Issued for Tender 2023-07-25 Drn Bv: A.Y. EIT / E.A. EIT Chk By: E.S.C. P. Eng 221122 Drawing Number:


Suite 201, 85 Fitzroy Street Charlottetown, PEI, Canada, C1A 1R6 Phone (902) 368-2300 www.colesassociates.com

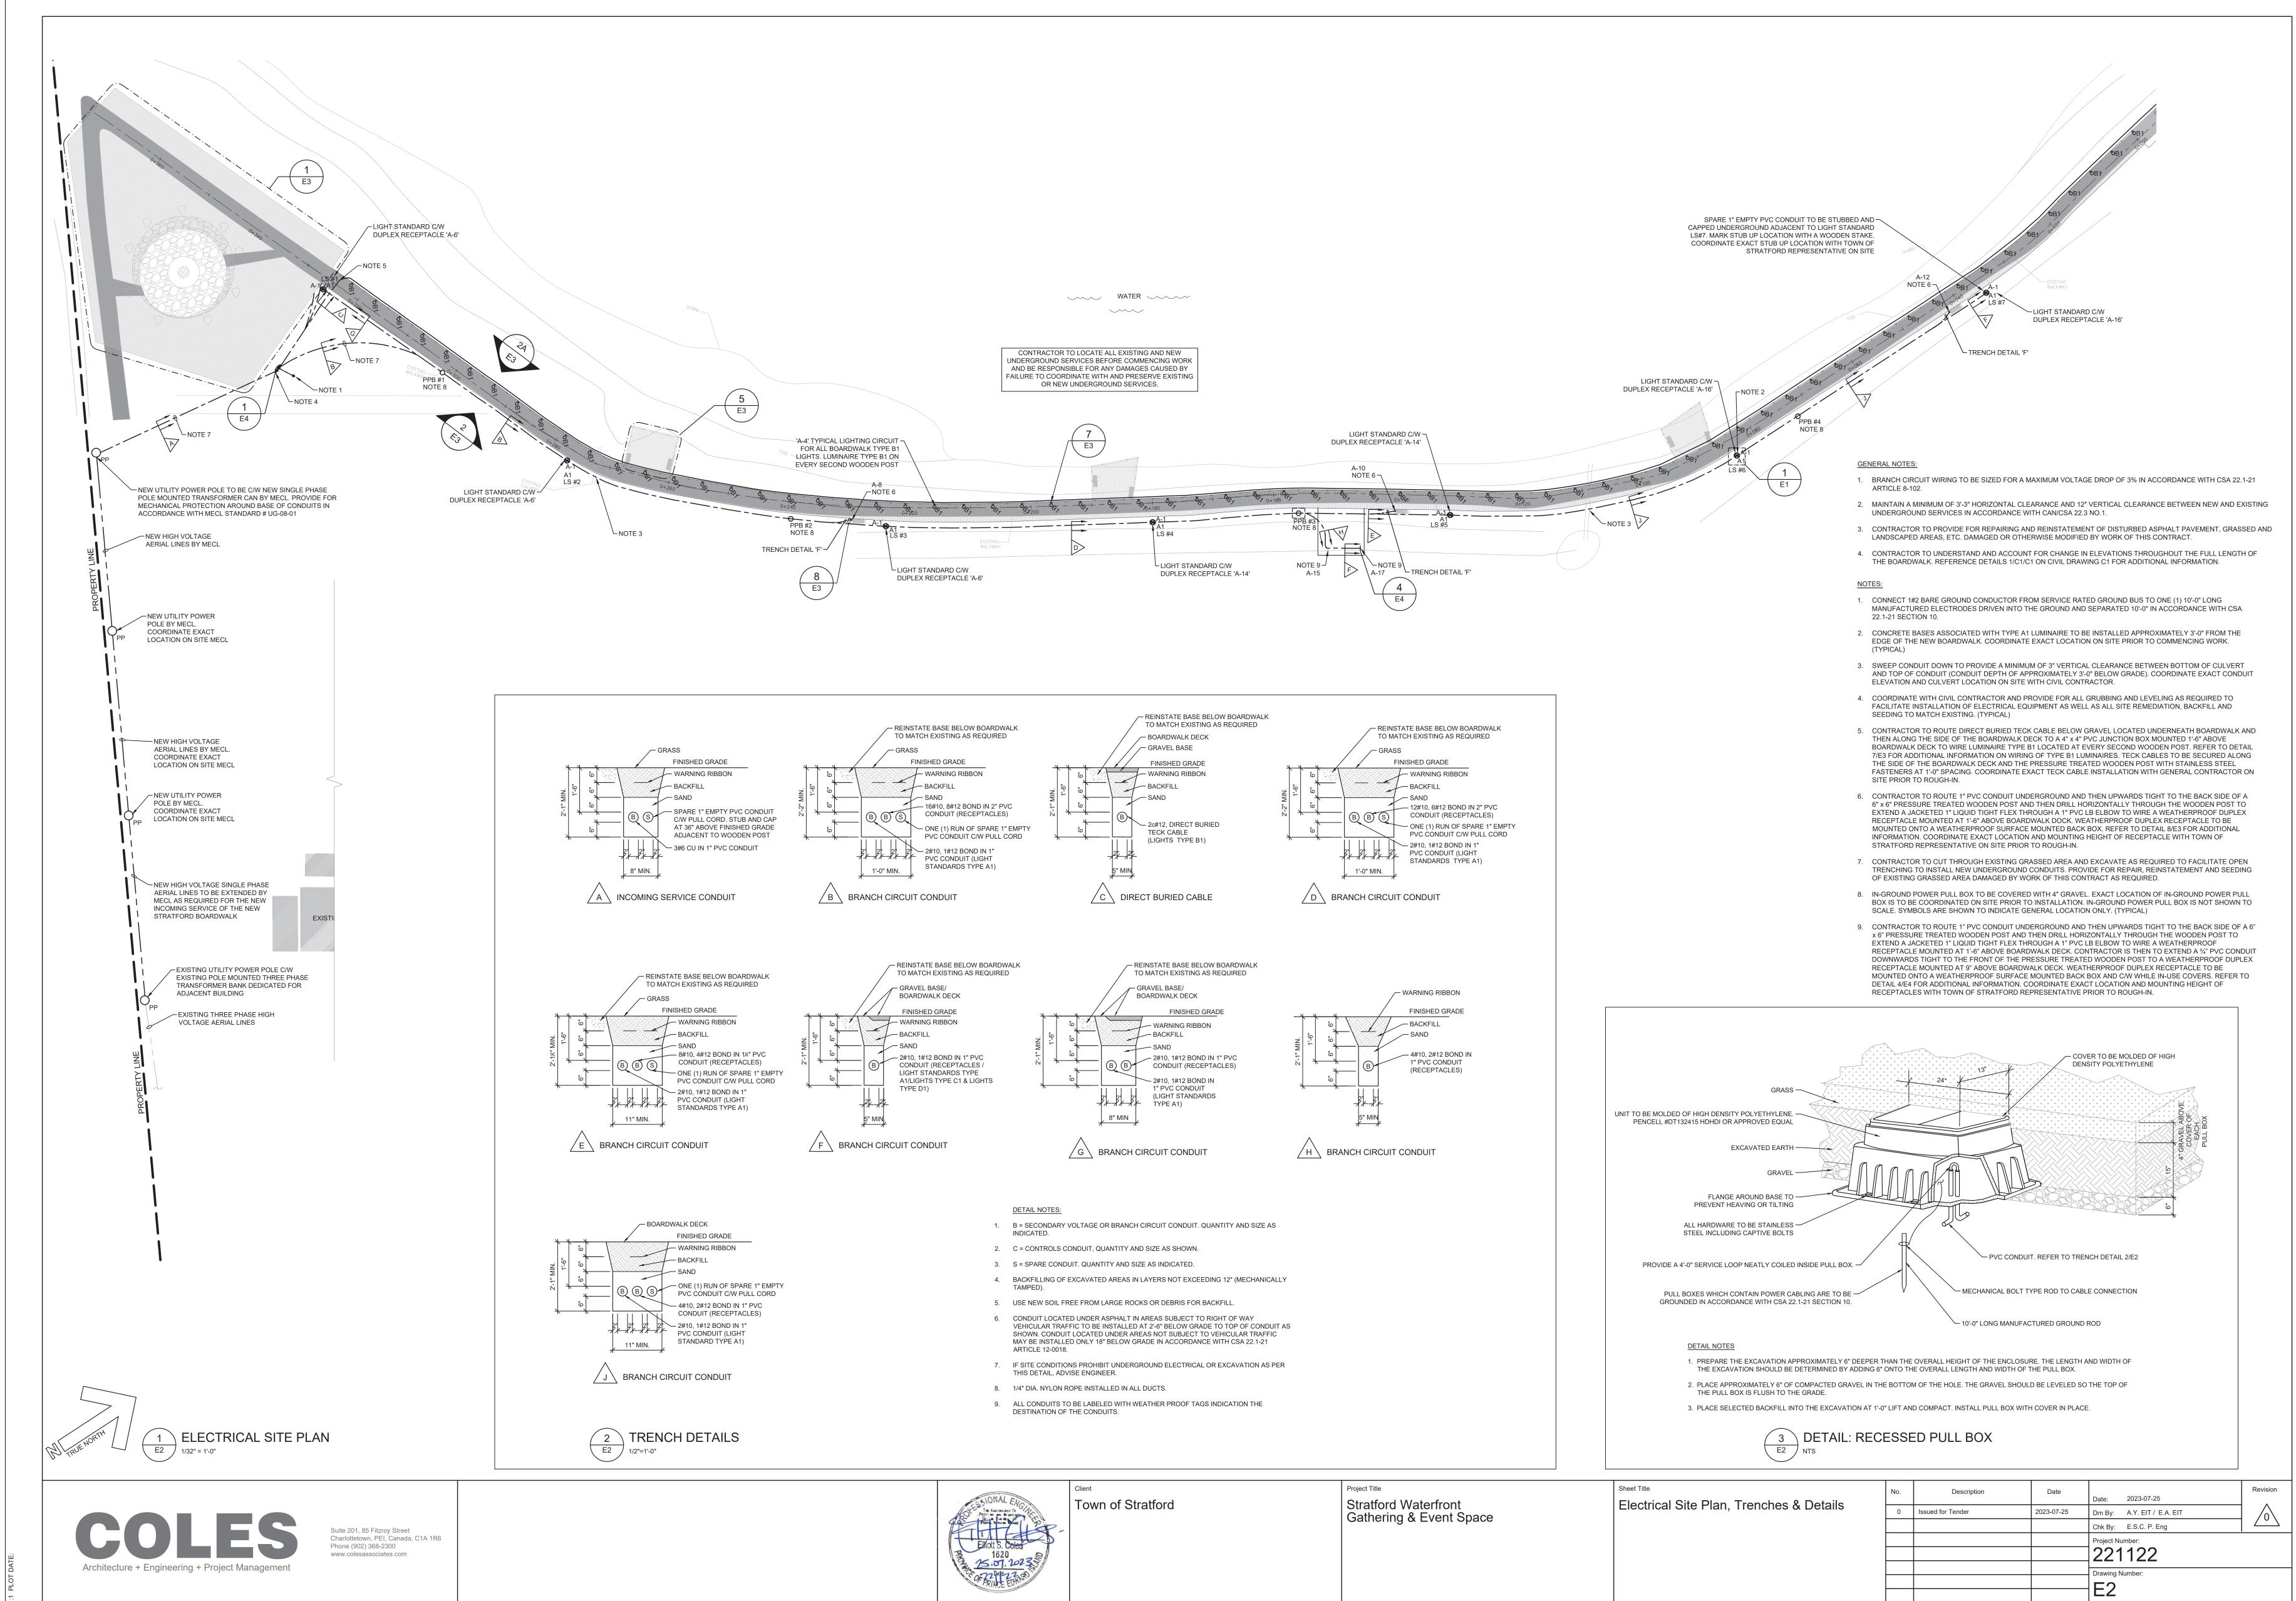

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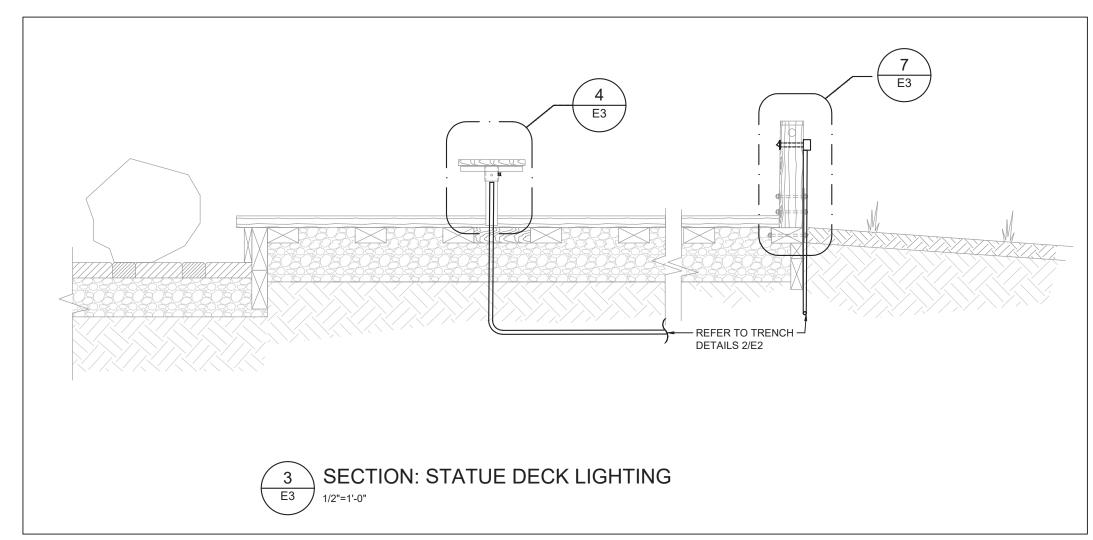
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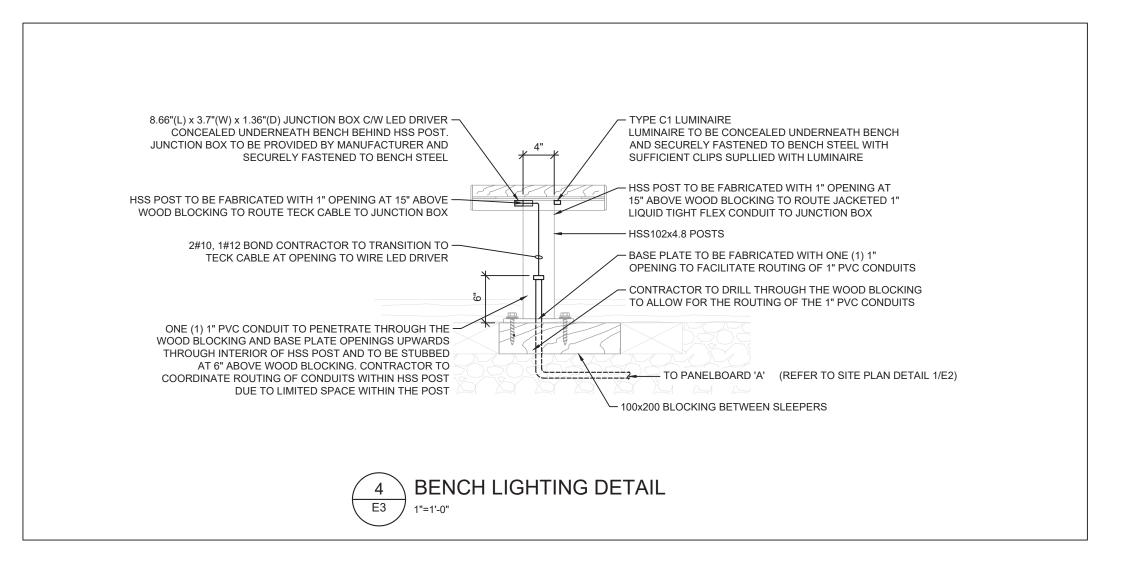


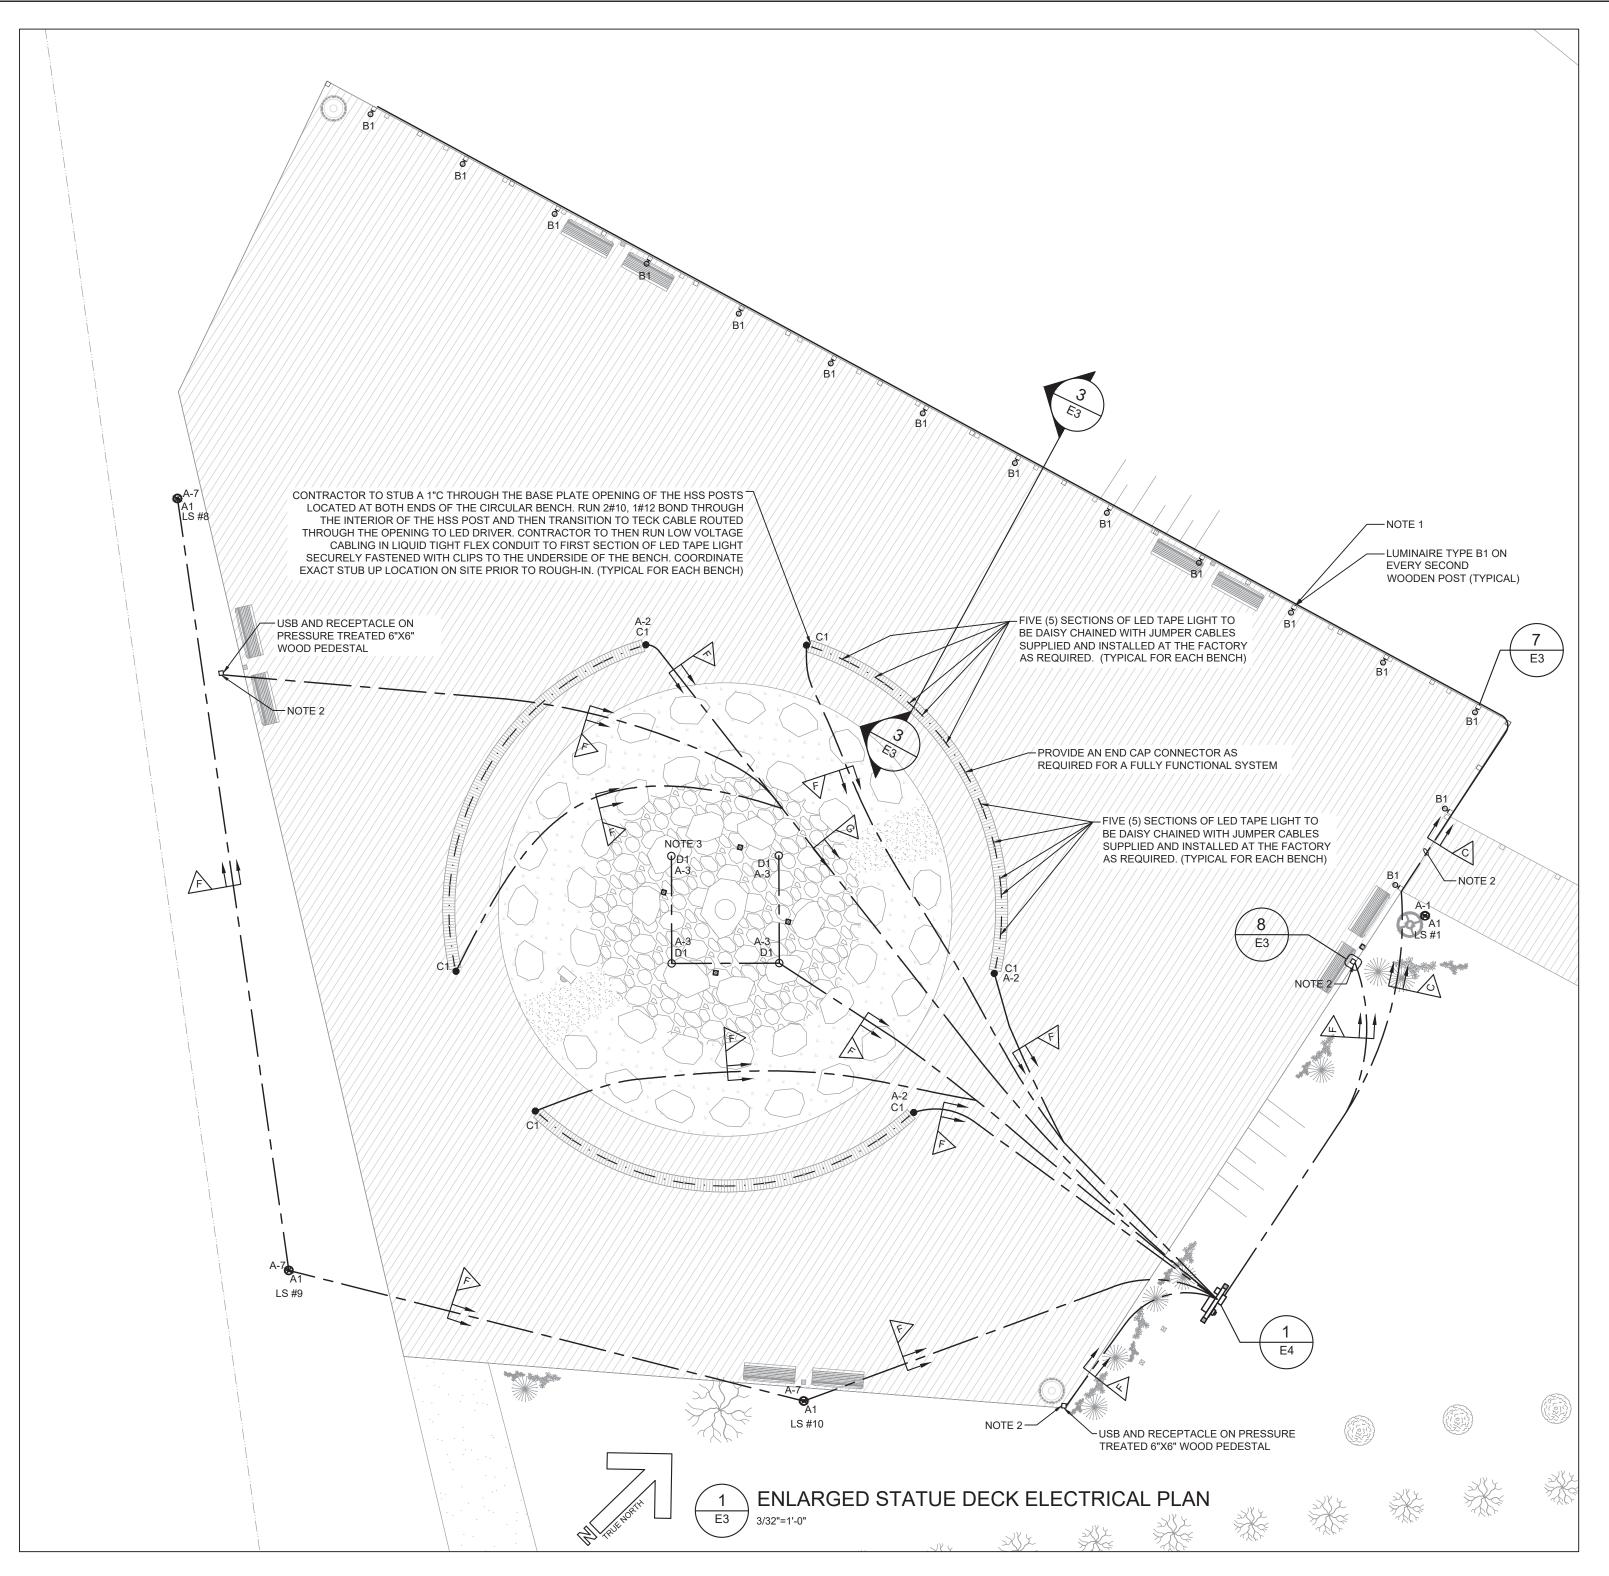



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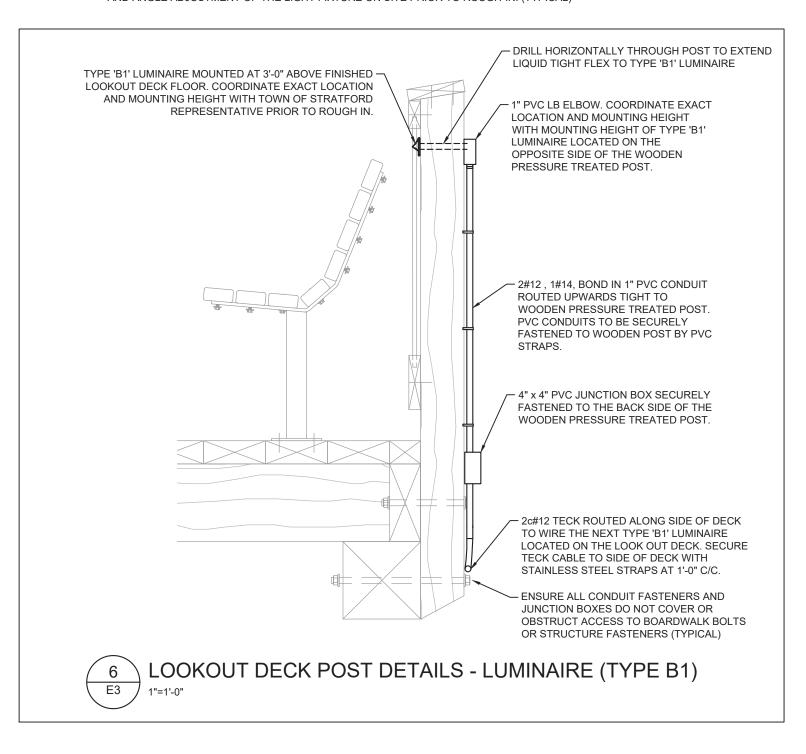


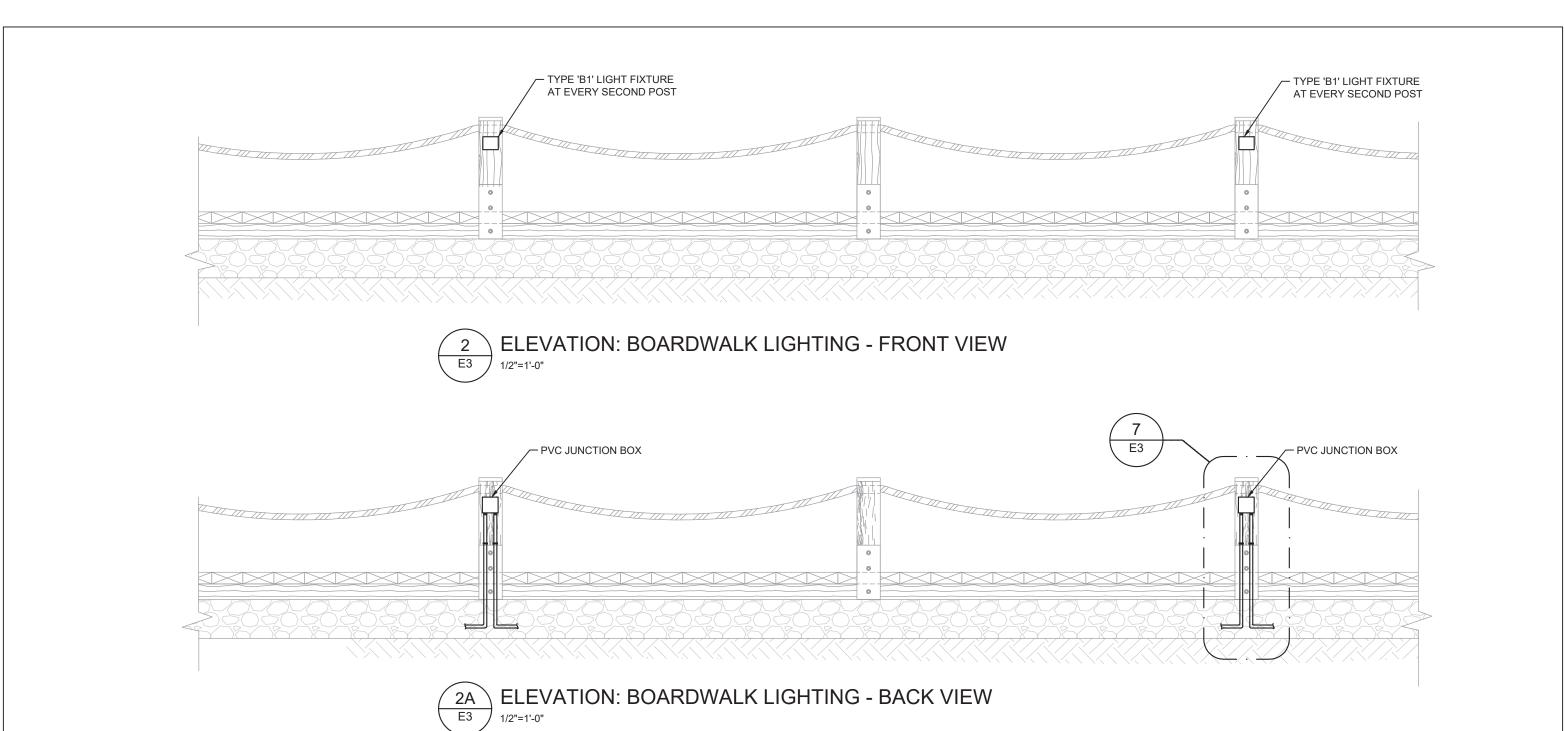
2. BRANCH CIRCUIT WIRING TO BE SIZED FOR A MAXIMUM VOLTAGE DROP OF 3% IN ACCORDANCE WITH CSA 22.1-21 ARTICLE


1. CONTRACTOR TO ROUTE 2c#12 TECK CABLE ALONG SIDE OF DECK AND THEN UPWARDS CONCEALED ALONG THE BACK SIDE OF THE PRESSURE TREATED WOODEN POST TO A 4" X 4" PVC JUNCTION BOX SECURELY FASTENED TO THE POST. CONTRACTOR IS THEN TO DRILL THROUGH THE WOODEN POST TO EXTEND A JACKETED 1" LIQUID TIGHT FLEX TO WIRE THE TYPE B1 LUMINAIRE. COORDINATE EXACT LOCATION AND MOUNTING HEIGHT OF PVC JUNCTION BOX WITH EXACT LOCATION AND MOUNTING HEIGHT OF TYPE B1 LUMINAIRE. TECK CABLE TO BE SECURELY FASTENED TO PRESSURE TREATED WOODEN POST WITH STAINLESS STEEL STRAPPING. REFER TO DETAIL 7/E3 FOR ADDITIONAL INFORMATION. (TYPICAL)


2. 1" UNDERGROUND PVC CONDUIT TO BE STUBBED AT THE BACK SIDE OF THE WOODEN PRESSURE TREATED POST AND ROUTED UPWARDS TIGHT TO THE POST TO A 4" X 4" PVC JUNCTION BOX. CONTRACTOR IS THEN TO DRILL THROUGH THE WOODEN PRESSURE TREATED POST TO EXTEND A JACKETED 1" LIQUID TIGHT FLEX TO THE WEATHERPROOF DUPLEX RECEPTACLE. COORDINATE EXACT LOCATION OF PVC JUNCTION BOX WITH THE LOCATION OF WEATHERPROOF DUPLEX RECEPTACLE ON SITE PRIOR TO ROUGH-IN. REFER TO DETAIL 8/E3 FOR ADDITIONAL INFORMATION. (TYPICAL)

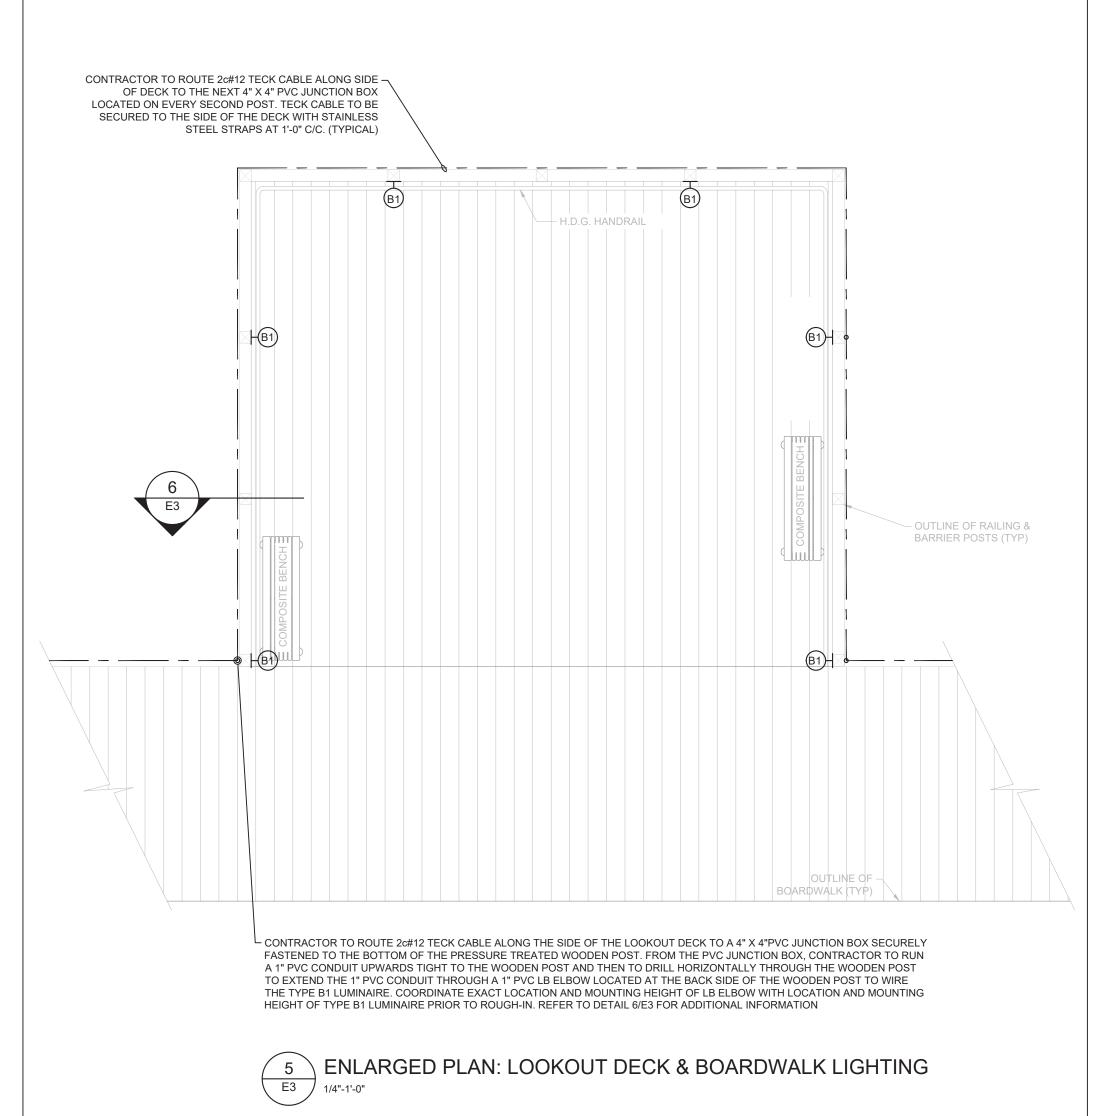3. TYPE D1 LUMINAIRE TO BE MOUNTED TO AN ALUMINUM GROUND MOUNT POST SUPPLIED WITH THE LIGHTING FIXTURE. GROUND MOUNT POST TO BE STUBBED 18" INTO THE GROUND FLOOR IN ACCORDANCE WITH MANUFACTURER'S INSTALLATION INSTRUCTIONS. CONTRACTOR TO ROUTE 1" CONDUIT TO GROUND MOUNT POST AND THEN RUN 2#12, 1#14 BOND THROUGH THE INTERIOR OF THE POST AS REQUIRED TO WIRE LUMINAIRE. COORDINATE EXACT INSTALLATION, WIRING AND ANGLE ADJUSTMENT OF THE LIGHT FIXTURE ON SITE PRIOR TO ROUGH-IN. (TYPICAL)

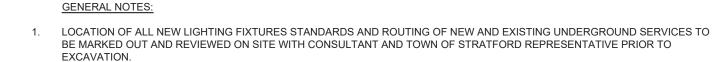

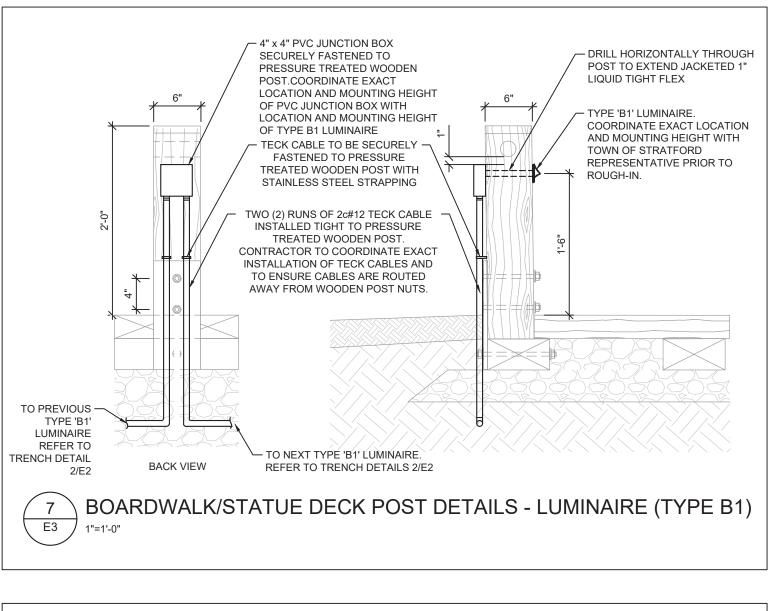

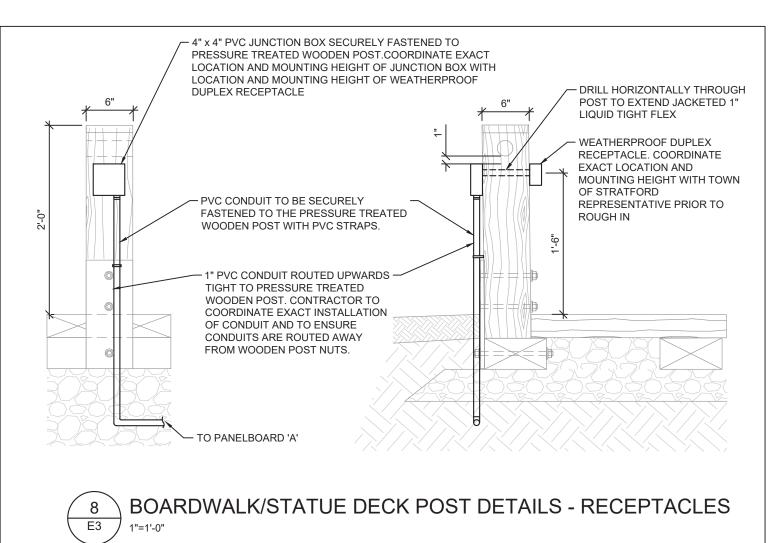

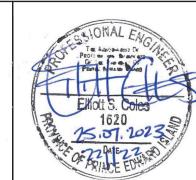


Town of Stratford


Stratford Waterfront Gathering & Event Space Statue & Lookout Deck Plans, Elevations & Details


No.	Description	Date	Date: 2023-07-25	Revision	
0	Issued for Tender	2023-07-25	Drn By: A.Y. EIT / E.A. EIT		
			Chk By: E.S.C., P.Eng		
			Project Number:		
			221122		
			Drawing Number:		
			F3		







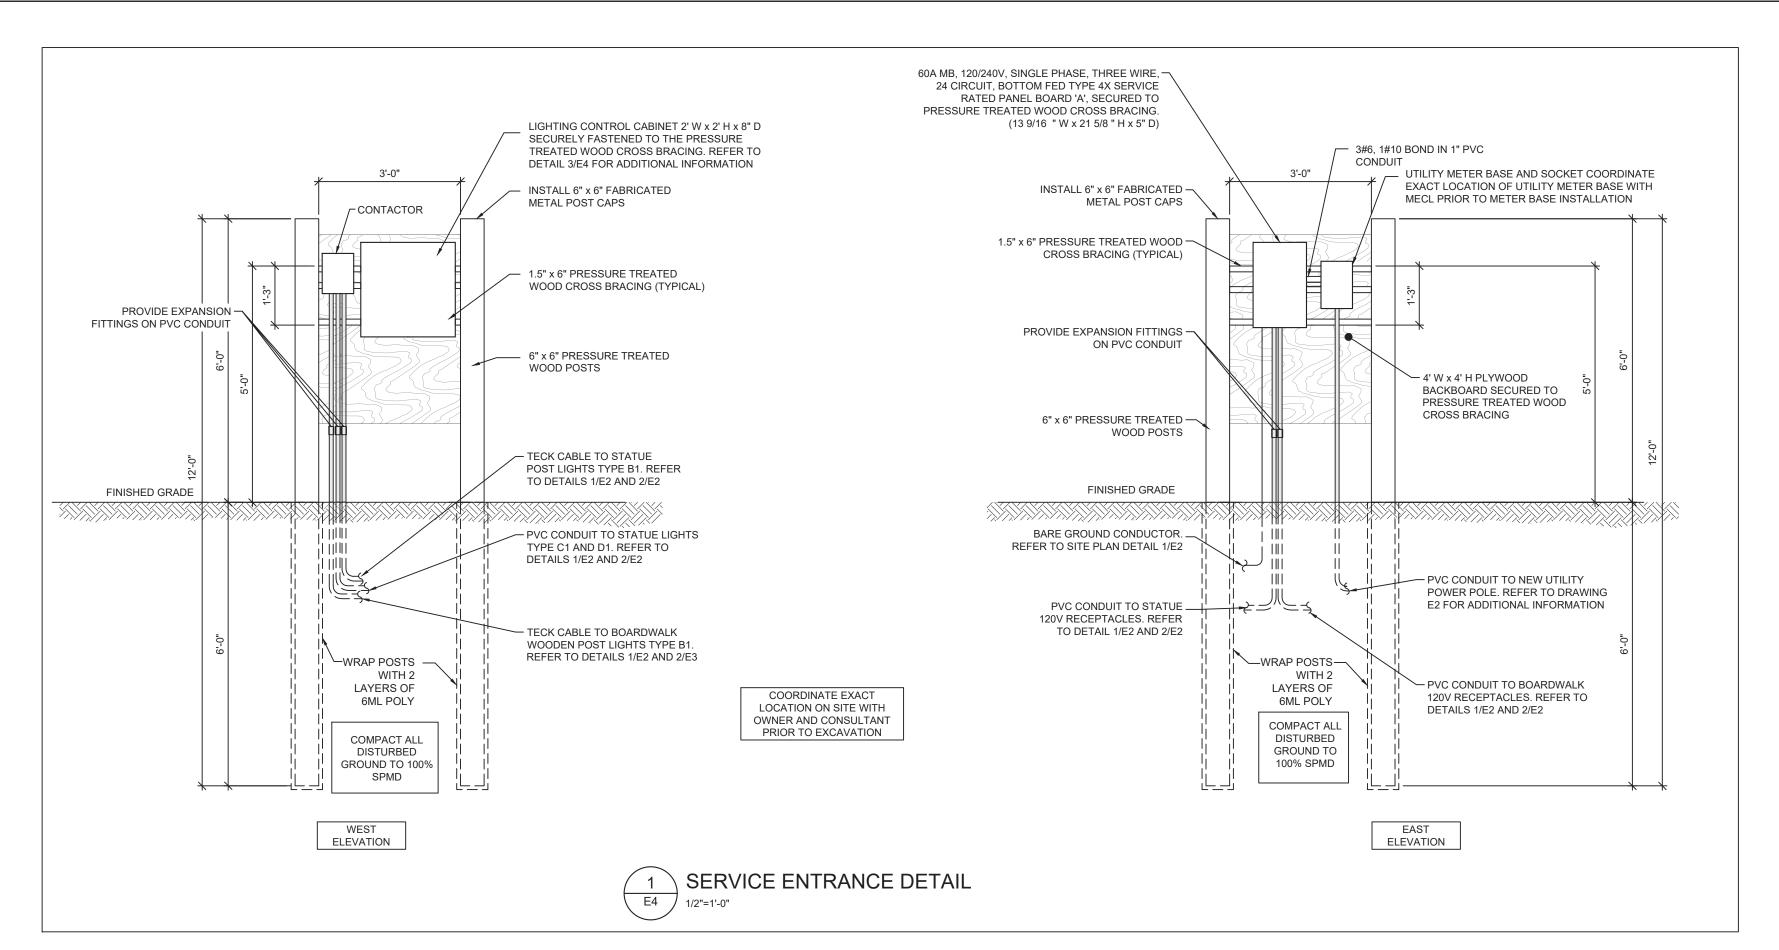

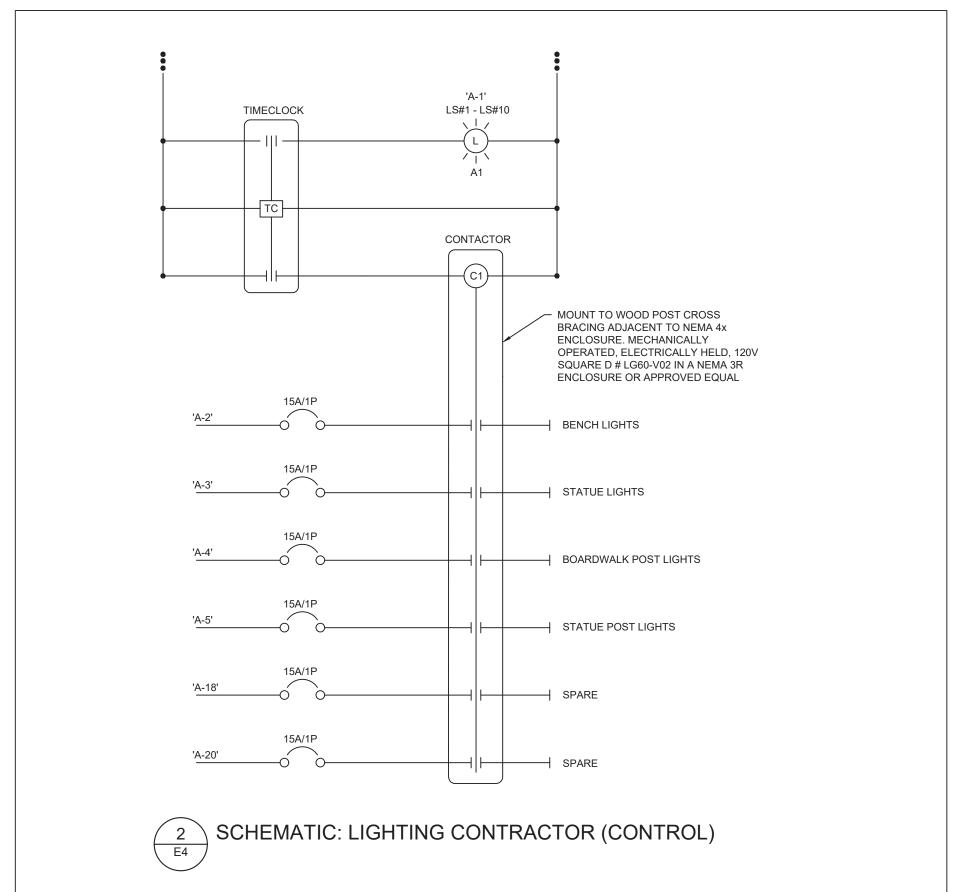

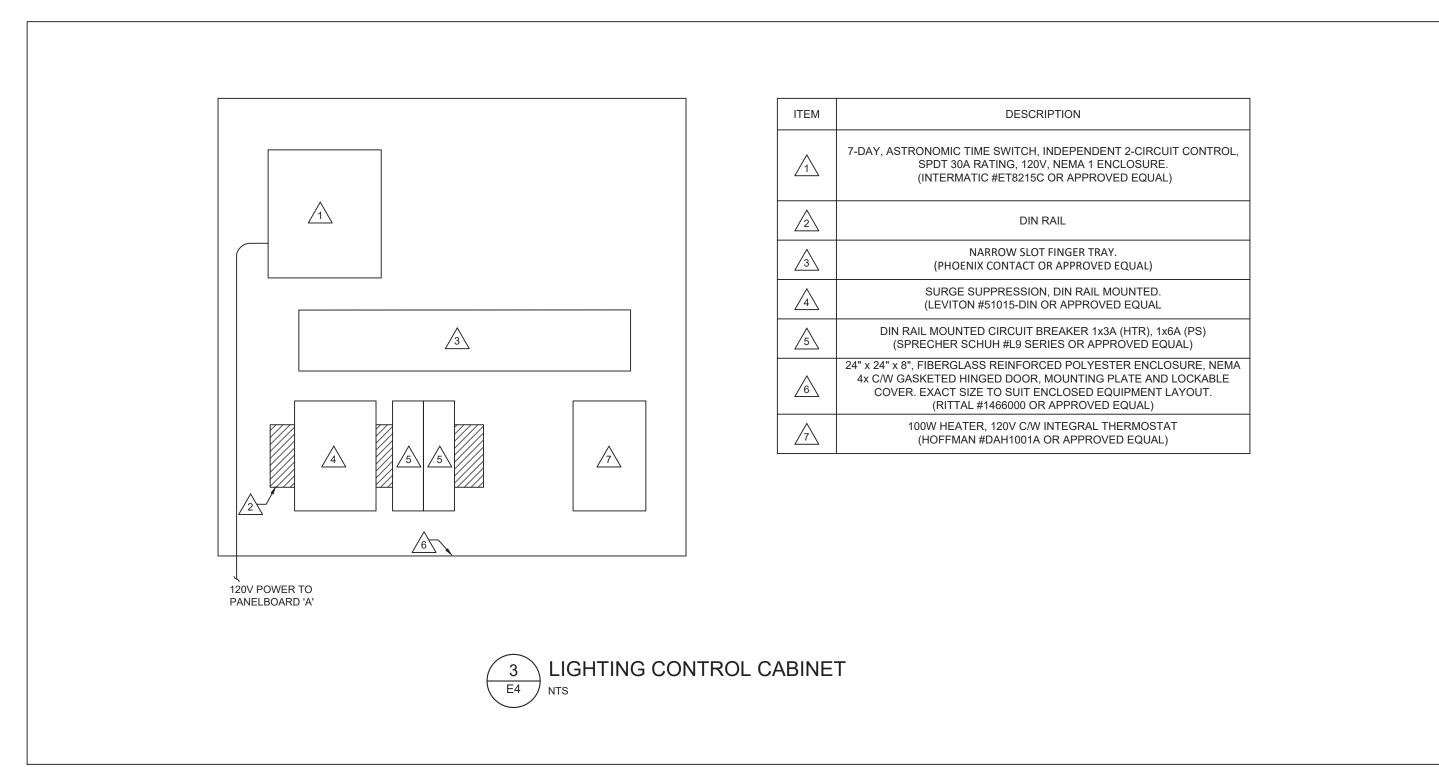


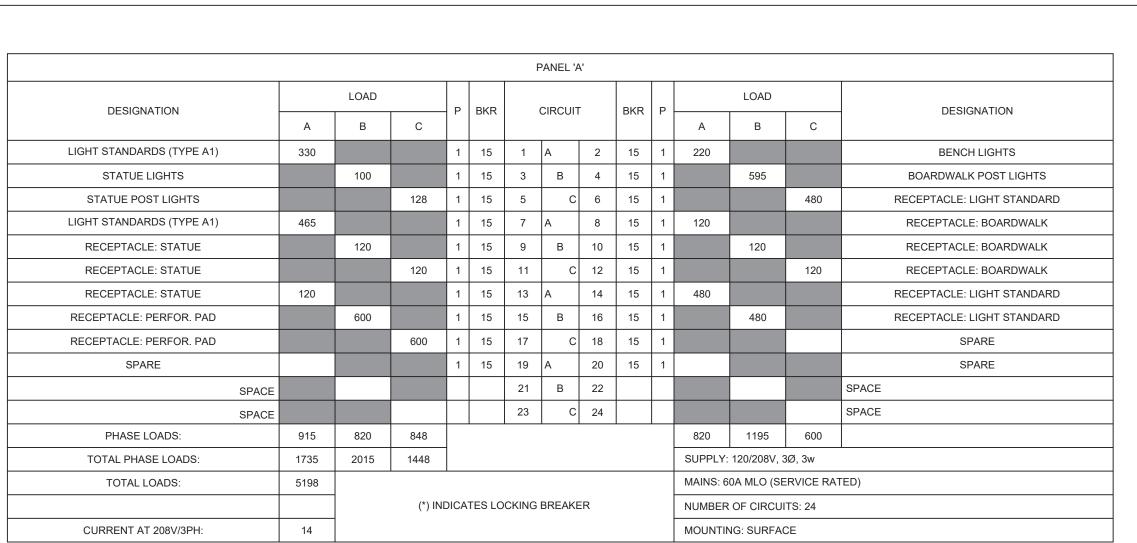

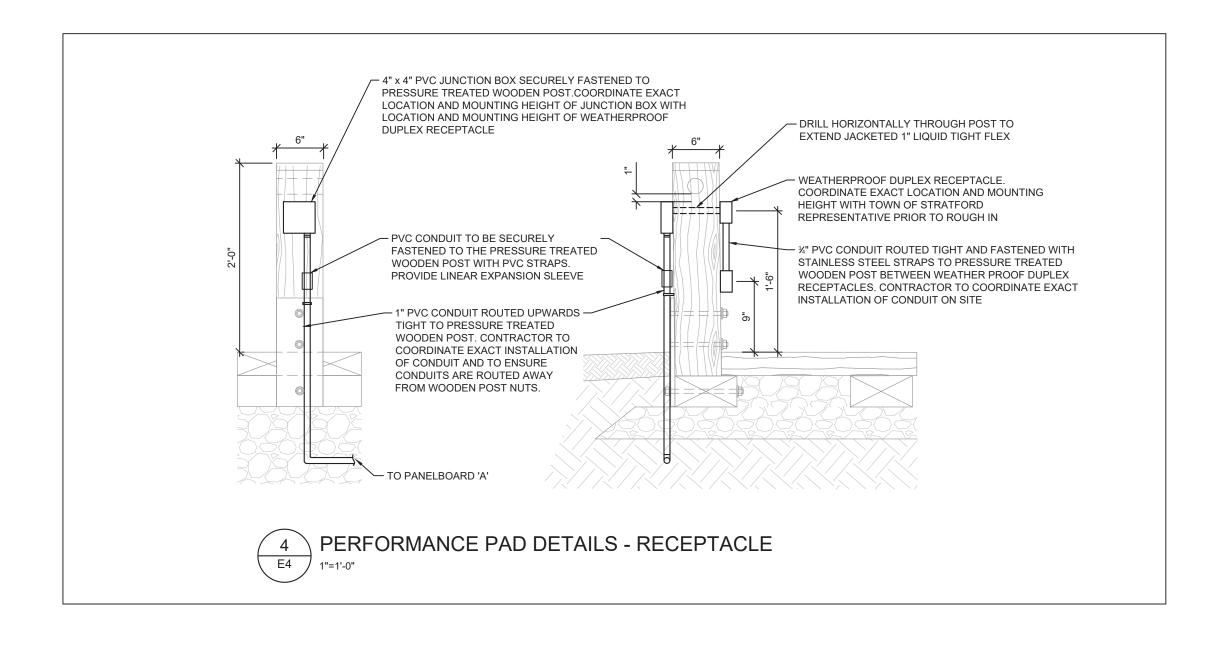

	LUMINAIRE SCHEDULE		
TYPE	DESCRIPTION	SOURCE	MOUNTING
A1	31-3/4" HIGH X 18-1/4" WIDE, DECORATIVE SPUN ALUMINUM LED MOUNTED ON A CAST ALUMINUM COLLAR, ROUND IN SHAPE UV RESISTANT ACRYLIC RIBBED GLOBE, ROUND SHAPE ALUMINUM BASE C/W FOUR ARMS AND A DECORATIVE RING ALL WELDED TOGETHER AND INSTALLED ON THE BASE MODULE, MARINE GRADE PRE-FINISH, BLACK FINISH, IP66 RATED, TYPE 3 DISTRIBUTION, 120V DRIVER. POLE TO BE ROUND, 4" DIAMETER ALUMINUM, 12'-0" IN HEIGHT, BLACK POLYESTER POWDER COAT FINISH AND MINIMUM EPA RATING OF 7.67 AT 90MPH. POLE BASE TO BE ROUND EXTRUDED ALUMINUM TUBING. CYCLONE #CY11T4B-VS3AR-T3-P40-40K-120-10KV-PT-PND508-BK-TX-MG C/W CYCLONE #PAL42-12-GFIC1-BHS-BK-TX-MG	LED 6400 LUMENS 58W L70 AT 100,000h 70 CRI 4000K	POLE TO BE MOUNTE CONCRETE BASE W ANCHOR BOLTS AN BOLT PLATE.
B1	5.5" (w) x 5.75" (h) x 2" (d), EXTERIOR LED WALL PACK MOUNTED AT BOARDWALK/STATUE PRESSURE TREATED WOODEN POSTS C/W FULL CUT-OFF, GASKETTED HEAVY-DUTY DIE CAST ALUMINUM HOUSING, DARK BRONZE POWDER COAT FINISH, IP66 RATED, 120V DRIVER. LITHONIA #WPX0 LED AL0 SWW2 MVOLT PE DDBXD GARDCO #GBS-A01-840-T4M-UNV-NONE-BK	LED 850 LUMENS 7W L86 AT 100,000h 80 CRI 4000K	TO BE MOUNTED A PRESSURE TREATI WOODEN POST. COORDINATE EXAGE LOCATION AND MOUNTING HEIGHT SITE PRIOR TO ROUGE
C1	WET LOCATION LISTED, 65' LONG, FLEXIBLE LED TAPE LIGHT HOUSED IN A DURABLE UV RESISTANT SILICONE SLEEVE C/W FACTORY-INSTALLED LEAD WIRES, WET LOCATION LISTED, IP65 RATED, 24VDC. PROVIDE ALL REQUIRED FASTENERS AND CLIPS TO SECURELY FASTEN LED TAPE TO STATUE BENCHES. 120V DRIVER TO BE PROVIDED WITH LED TAPES. DIODE LED #DI-24V-NBL4-40-65-CHN-WH-O/O- FACTORY + FIELD C/W #DI-SE-NB-FLCH-WH, #DI-SE-NB-JPR, #DT-SE-NB-STWC-EC C/W TWO (2) DI-ODX-24V96W-J	LED 120 LUMENS/FT 2.4W/FT 80 CRI 4000K	TO BE MOUNTED UNDERNEATH STAT BENCHES. TAPE LIG AND DRIVER TO B CONCEALED UNDERNEATH TH BENCH.
D1	3.25" DIAMETER, WET LOCATION LISTED, LED PROJECTOR C/W ALUMINUM HOUSING, WATER SHED GLASS LENS, 45 DEGREE DISTRIBUTION, IP66 RATED, BLACK POWDER COAT FINISH, 120V DRIVER. LUMINAIRE TO BE MOUNTED TO A 24" GROUND MOUNTING ALUMINUM POST C/W BLACK FINISH. HYDREL #PALM A P1 80CRI 40K 120 45DEG WSL 350R PM60C S24 S24 C1 BL C/W PM60C S24 BL	LED 2100 LUMENS 18W L86 AT 100,000h 80 CRI 4000K	TO BE MOUNTED TO BE MOUNTED TO BE MOUNT MOUNTIN POST STUBBED THROUGH GROUND C/W 24" STEM. COORDINATE EXAMILIATION AND AND AND AND ADJUSTMENT ON SPRIOR TO ROUGH-



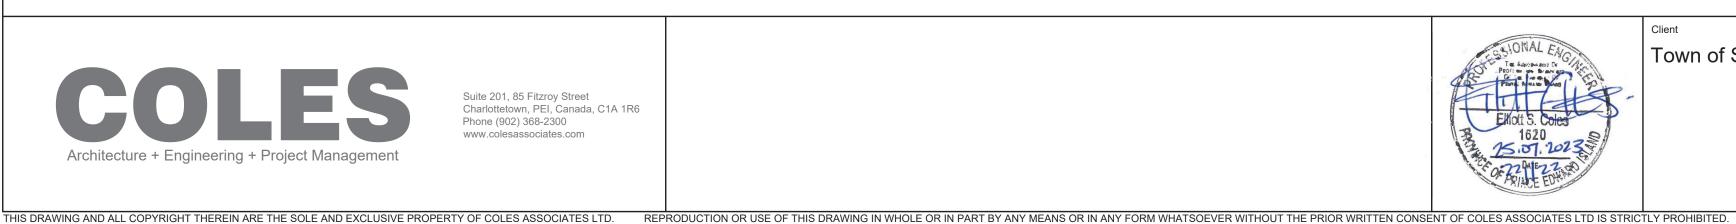

Town of Stratford

Stratford Waterfront Gathering & Event Space

Service Entrance Detail, Schematics & Schedules

No.	Description	Date	Date:	2023-07-25	Revision
0	Issued for Tender	2023-07-25	Drn By:	A.Y. EIT / E.A. EIT	
			Chk By:	E.S.C., P.Eng	7 0
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