



BUILDING SECTION - LIFE SAFETY

1/16" = 1'-0"

1 FLOOR PLAN - LIFE SAFETY

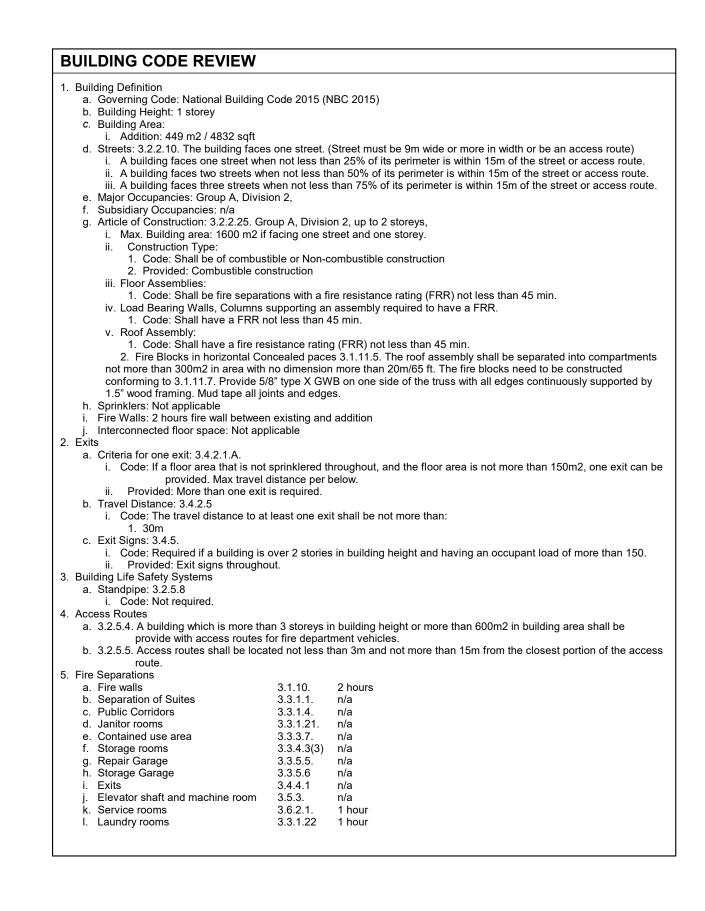


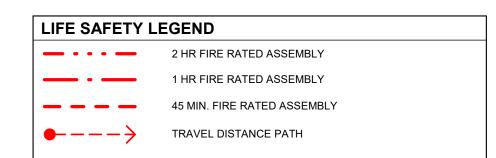






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Rural Municipality of Kinkora

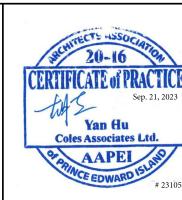Kinkora Community Hall Expansion

Building Code and Life Safety Notes



EXTERIOR WALL TYPES										
TYPE	DESCRIPTION	REMARKS								
EW1	- VINYL SIDING - 1" RIGID INSULATION (R5) - CONTINUOUS AIR BARRIER - 1/2" EXTERIOR OSB SHEATHING - 2"X6" WOOD STUD FRAMING @ 16" O.C. C/W BATT INSULATION (R24) - 6mil POLY VAPOUR BARRIER - 1 LAYER. 1/2" GYPSUM WALL BOARD									

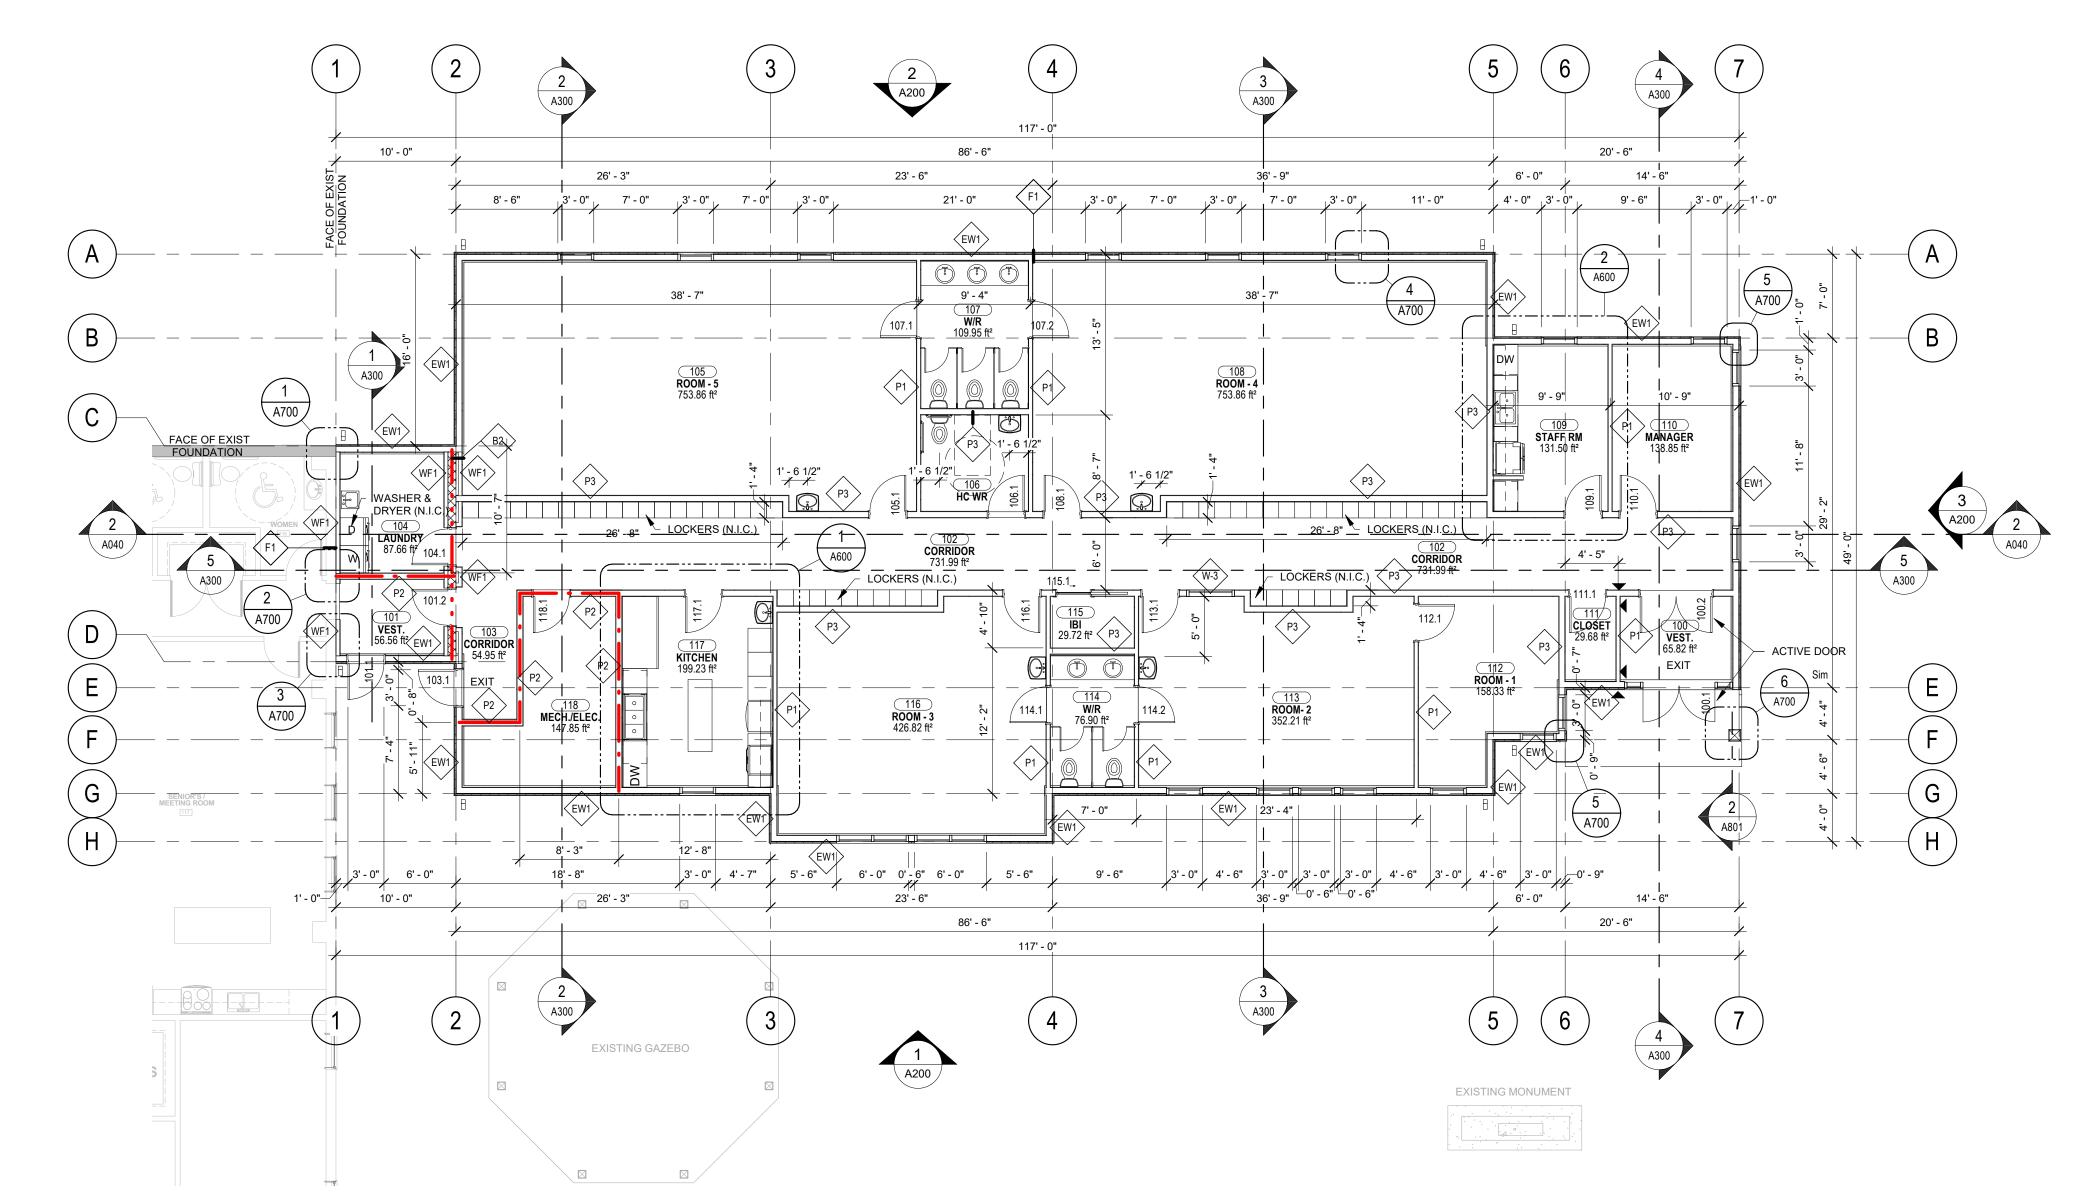TYPE	DESCRIPTION	REMARKS	NBCC	STC
B2	- 7.5" / 190MM CONCRETE BLOCK	2 HR.	NBC 2015, B2g	48
P1	- 1/2" GYPSUM WALL BOARD - 1-1/2" x 3-1/2" / 38MM x 89MM WOOD STUD FRAMING @ 16" / 400MM O.C. C/W FIBERGLASS ACOUSTIC BATT INSULATION (FILL CAVITY) - 1/2" GYPSUM WALL BOARD	N/A	NBC 2015, W1c	32
P2	-5/8" / 16MM GYPSUM WALL BOARD TYPE X - 1-1/2" X 5-1/2" / 38MM x 140MM WOOD STUD FRAMING @ 16" / 400MM O.C. C/W MINERAL WOOL INSULATION (FILL CAVITY) - 5/8" / 16MM GYPSUM WALL BOARD TYPE X	1 HR.	N/A	N/A
P3	- 1/2" GYPSUM WALL BOARD - 1-1/2" X 5-1/2" / 38MM x 140MM WOOD STUD FRAMING @ 16" / 400MM O.C. C/W FIBERGLASS ACOUSTIC BATT INSULATION (FILL CAVITY) - 1/2" GYPSUM WALL BOARD	N/A	N/A	N/A

FURRING WALL TYPES										
TYPE	DESCRIPTION	REMARKS	NBCC	STC						
	- 1/2" GYPSUM WALL BOARD - 3 1/2" WOOD STUD FRAMING @ 16" O.C. - ADJACENT WALL	N/A	N/A	N/A						

TYPE	DESCRIPTION	REMARKS
F1	- FINISH FLOOR AS SCHEDULED - CONCRETE FLOOR (REFER TO STRUCTURAL FOR THICKNESS) - 10mil POLY VAPOUR BARRIER - 48" HORIZONTAL STRIP OF 2" RIGID INSULATION (R10) AROUND PERIMETER ONLY - COMPACTED MATERIAL (REFER TO STRUCTURAL AND GEOTECHNICAL)	

ROOF TYPES									
TYPE	DESCRIPTION	REMARKS							
R1	- ASPHALT SHINGLES - ROOF MEMBRANE - 1/2" OSB SHEATHING - WOOD TRUSS @ 24" O.C. DESIGN BY A TRUSS MANUFACTURER AND SEALED BY AN ENGINEER TO PRACTICE IN PEI. MEET ALL SNOW AND WIND LOADS - R60 BLOWN IN INSULATION, APPROX. 20" - 3/4" WOOD STRAPPING AT 16" O.C 6MIL. POLY VAPOUR BARRIER - 5/8" TYPE X GYPSUM BOARD - T- BAR CEILING (REFER TO RCP)	45 MIN.							

GENERAL SHEET NOTES
ALL FIRE RATED WALLS AND LOAD BEARING WALLS ARE TO EXTEND TO THE UNDERSIDE OF TRUSSES U.N.O.

ZZ PROJECT NORTH

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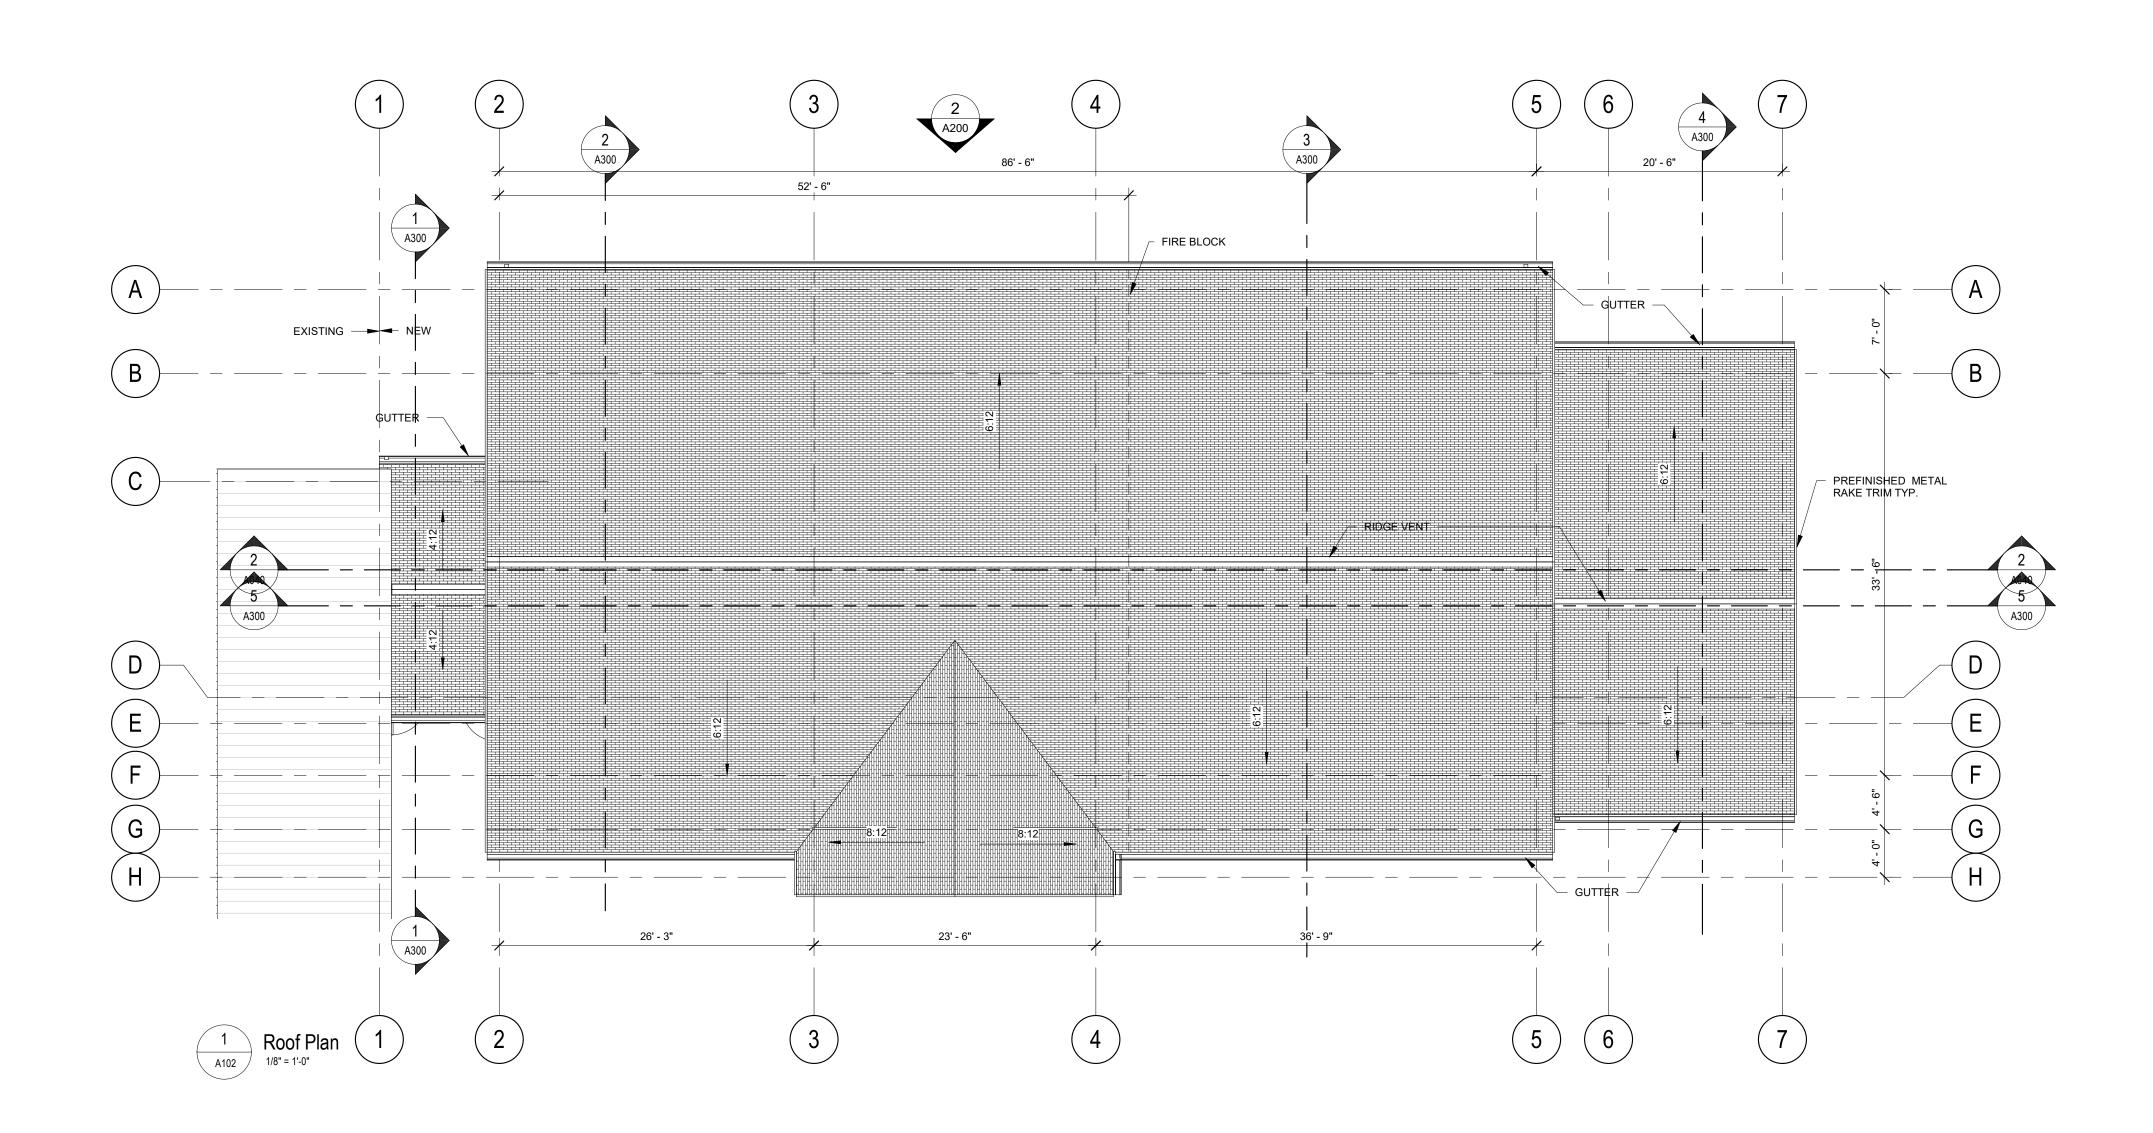


Rural Municipality of Kinkora

Kinkora Community Hall Expansion

Floor Plan

| Date | Date | 2023-09-21 | Revision | Date | 2023-09-21 | Drn By: SH/DC | Drn By: SDM | Project Number: | 231053 | Drawing Number: | A100 |




GENERAL SHEET NOTES

REFER TO EXTERIOR ELEVATIONS FOR DOWNSPOUT LOCATIONS.

• FIRE BLOCK IN HORIZONTAL CONCEALED ROOF SPACE, REFER TO CODE ANALYSIS FOR DETAIL INFORMATION,

Architecture + Engineering + Project Management

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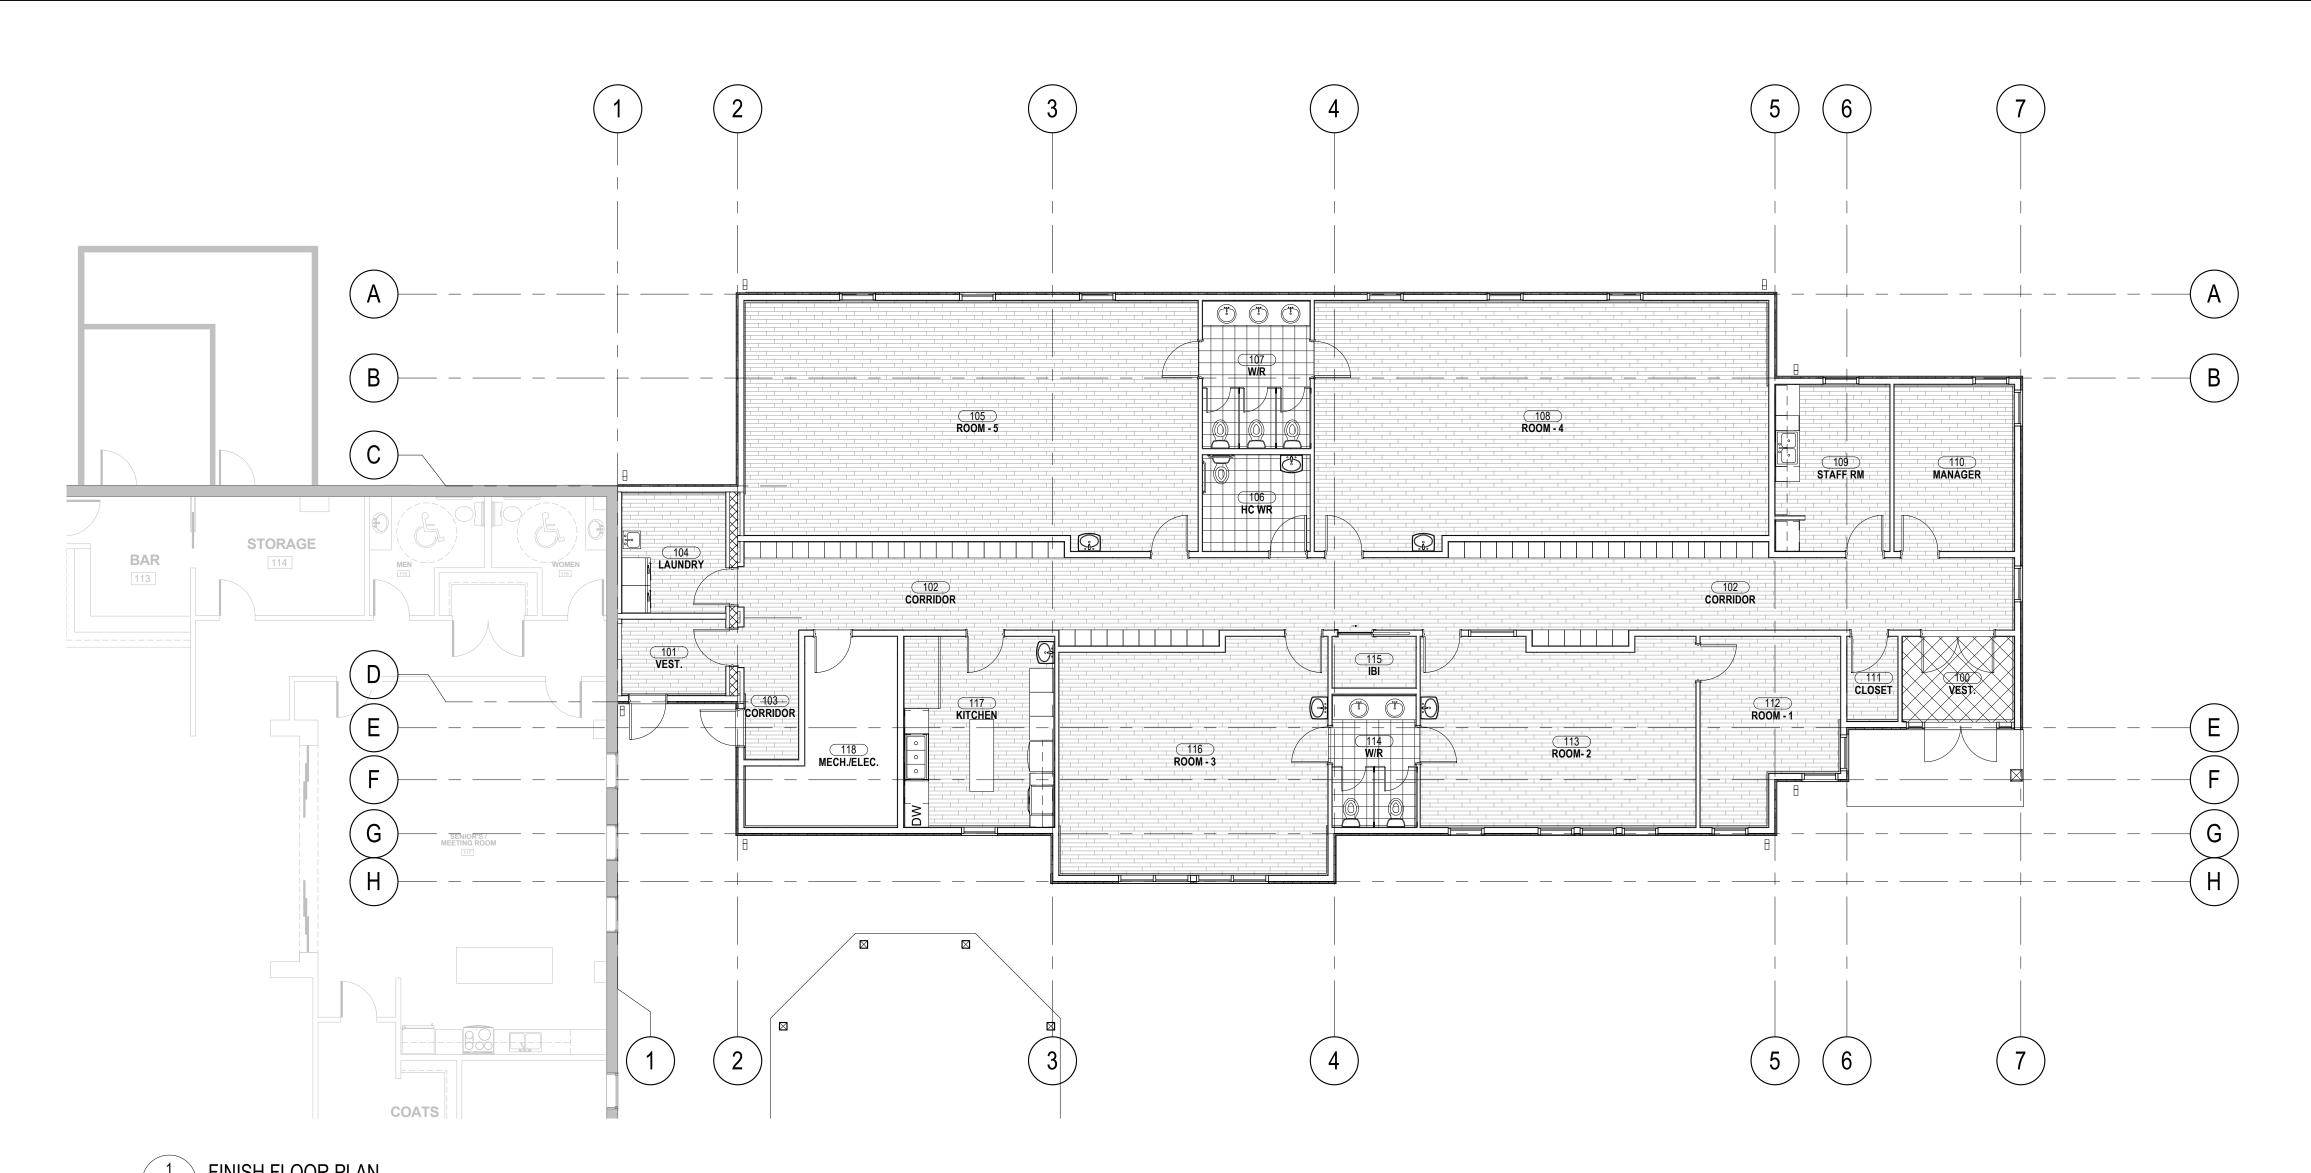
Rural Municipality of Kinkora

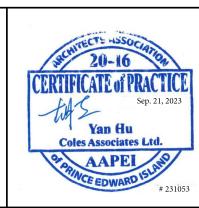Kinkora Community Hall Expansion

Roof Plan

No. Description
Date
Date: 2023-09-21
Drn By: SH
Chk By: SDM
Project Number:

231053
Drawing Number:



ROOM FINISH SCHEDULE NOTES

1. REFER TO MATERIAL/FINISH SCHEDULE FOR INFORMATION ON ALL MATERIAL

2. REFER TO FLOOR FINISH PLANS FOR FLOOR TYPES.

3. REFER TO REFLECTED CEILING PLANS FOR CEILING TYPES.


ROOM FINISH SCHEDULE										
		FLOOR	WALLS							
ROOM NO	ROOM NAME	DACE	NORTH	EAST	SOUTH	WEST				
NO.		BASE	FIN.	FIN.	FIN.	FIN.				
100	VEST.	T-1	P-2	P-2	P-2	P-2				
101	VEST.	RB-1	P-2	P-2	P-2	P-2				
102	CORRIDOR	RB-1	P-2	P-2	P-2	P-2				
103	CORRIDOR	RB-1	P-2	P-2	P-2	P-2				
104	LAUNDRY	RB-1	P-2 P-2		P-2	P-2				
105	ROOM - 5	RB-1	P-2	P-2 P-2		P-2				
106	HC WR	RB-1	P-2	P-2	P-2	P-2				
107	W/R	RB-1	P-2	P-2	P-2	P-2				
108	ROOM - 4	RB-1	P-2	P-2	P-2	P-2				
109	STAFF RM	RB-1	P-2	P-2	P-2	P-2				
110	MANAGER	RB-1	P-2	P-2	P-2	P-2				
111	CLOSET	RB-1	P-2	P-2	P-2	P-2				
112	ROOM - 1	RB-1	P-2	P-2	P-2	P-2				
113	ROOM- 2	RB-1	P-2	P-2	P-2	P-2				
114	W/R	RB-1	P-2	P-2	P-2	P-2				
115	IBI	RB-1	P-2	P-2	P-2	P-2				
116	ROOM - 3	RB-1	P-2	P-2	P-2	P-2				
117	KITCHEN	RB-1	P-2	P-2	P-2	P-2				
118	MECH./ELEC.		WC-1	WC-1	WC-1	WC-1				

GENERAL SHEET NOTES

• ENTRANCE MAT BY OWNER, NI.C. PROVIDE FLOORING AS SCHEDULED

• REFER TO MATERIAL/FINISH SCHEDULE FOR INFORMATION ON ALL MATERIAL TAGS

REFER TO ROOM FINISH SCHEDULE FOR INFORMATION ON ALL FINISHES AND WALL BASE

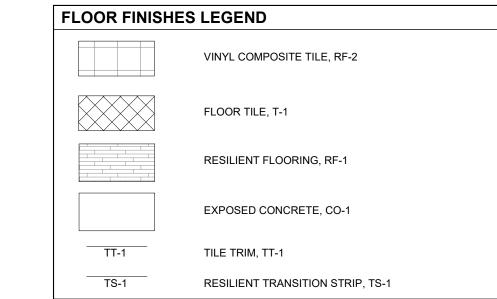

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Rural Municipality of Kinkora

Kinkora Community Hall Expansion

Floor Finish Plan

Description
Date
Date: 2023-09-21

Issued for Tender

Date: 2023-09-21

Drn By: SH


Chk By: SDM


Project Number:

231053

Drawing Number:

A140

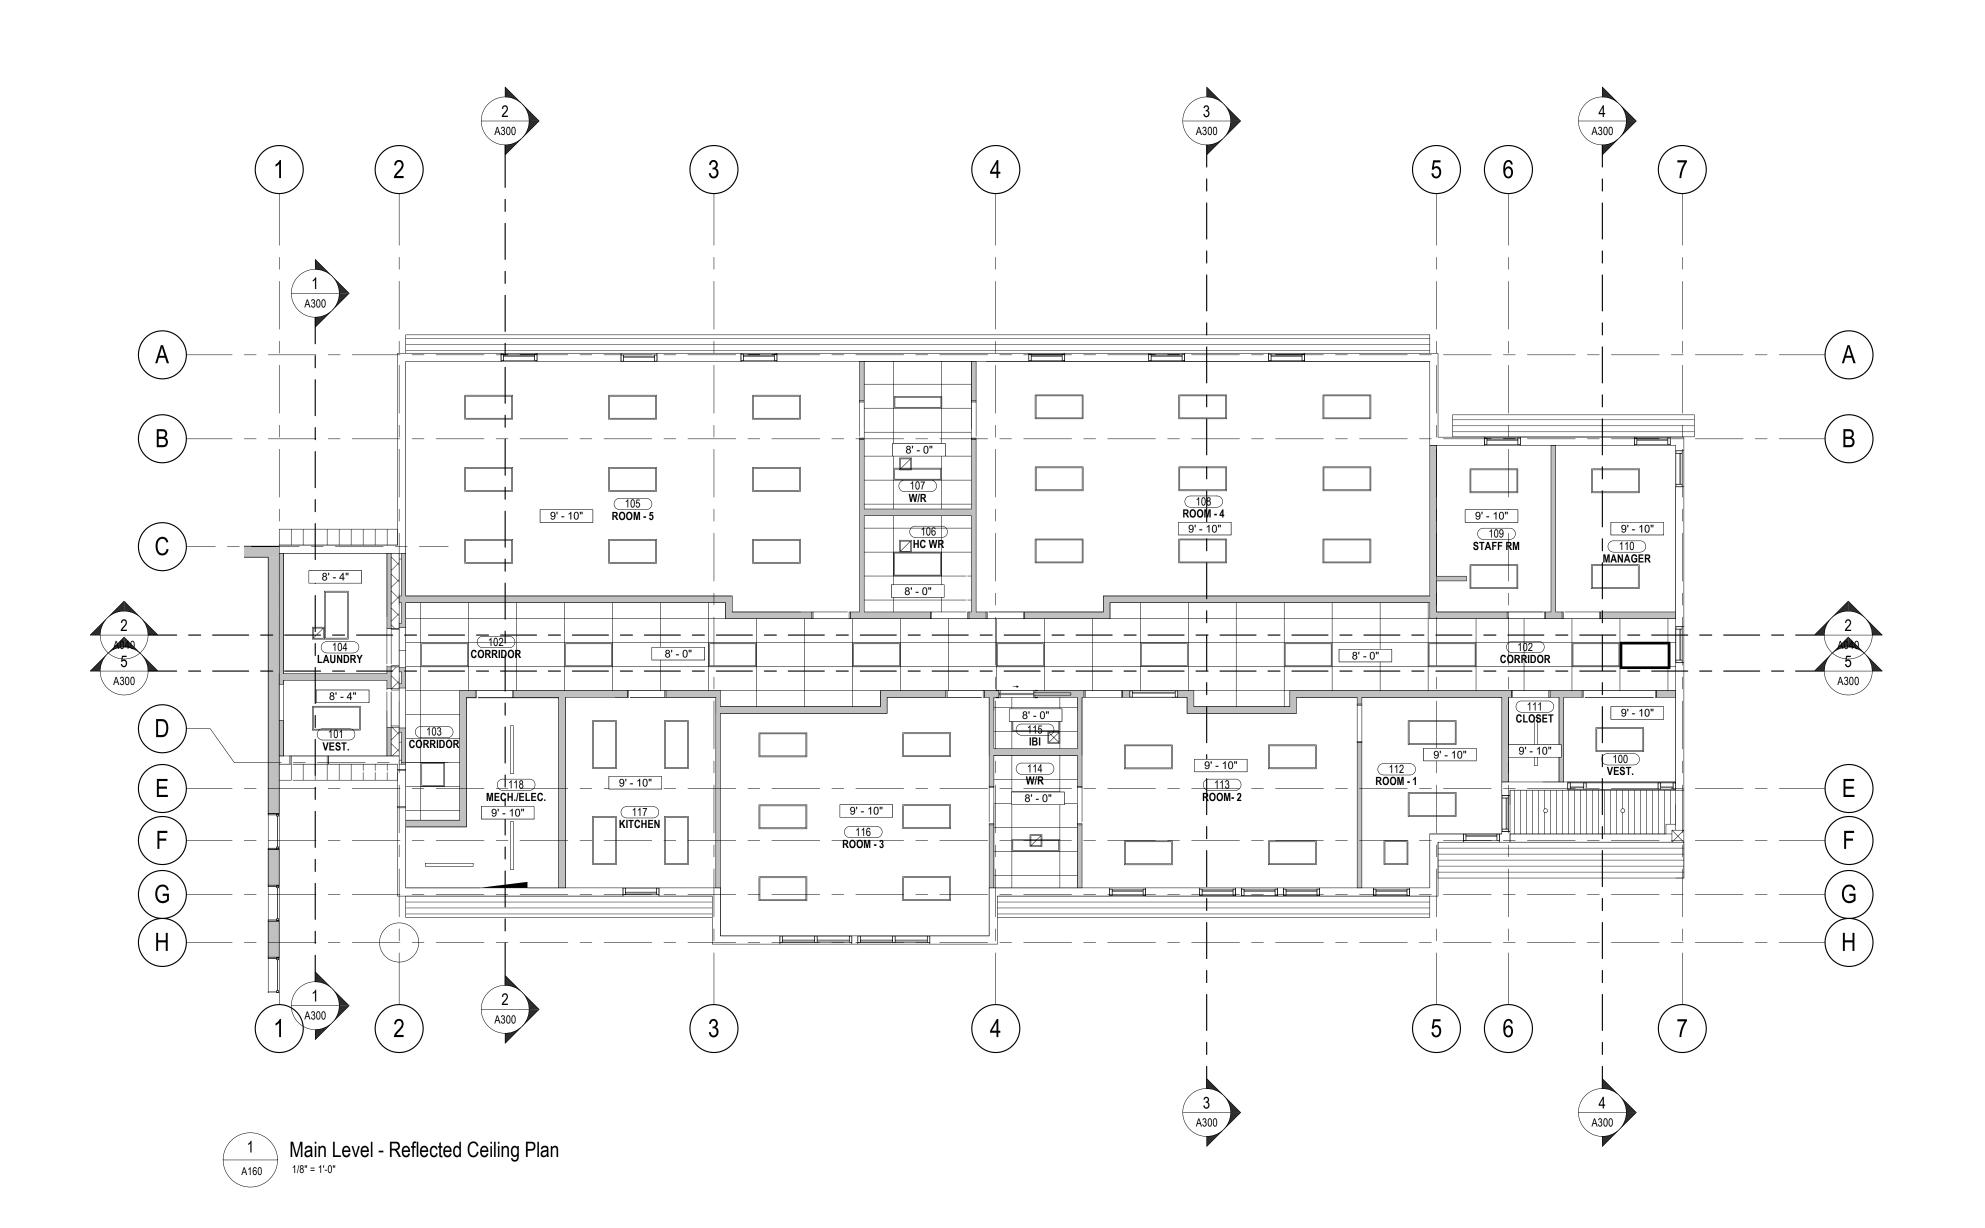

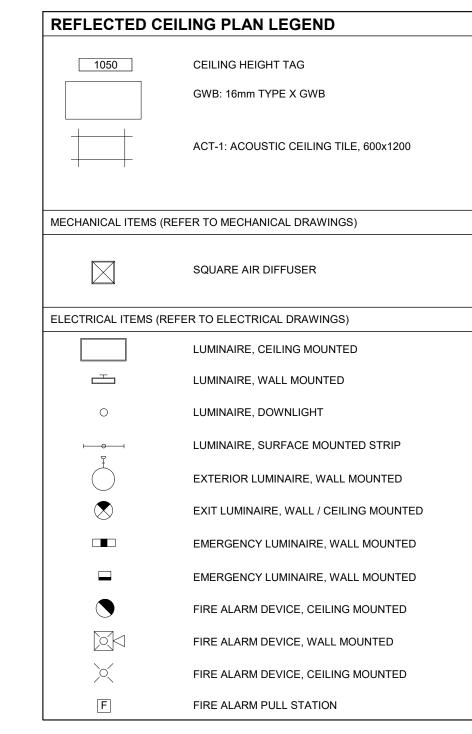

GENERAL SHEET NOTES

ALL T-BAR CEILINGS ARE ACT-1 UNLESS NOTED OTHERWISE

ALL GYPSUM BOARD CEILINGS ARE TO BE PAINTED FLAT WHITE
 REFER TO ELECTRICAL DRAWINGS FOR LIGHTING LAYOUT

• REFER TO MECHANICAL DRAWINGS FOR DIFFUSER LAYOUT

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Rural Municipality of Kinkora

Kinkora Community Hall Expansion


Reflected Ceiling Plan

 No.
 Description
 Date
 Date:
 2023-09-21
 Revision


 Issued for Tender
 2023-09-21
 Drn By: SH
 Chk By: Checker

 Project Number:
 231053


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 A160

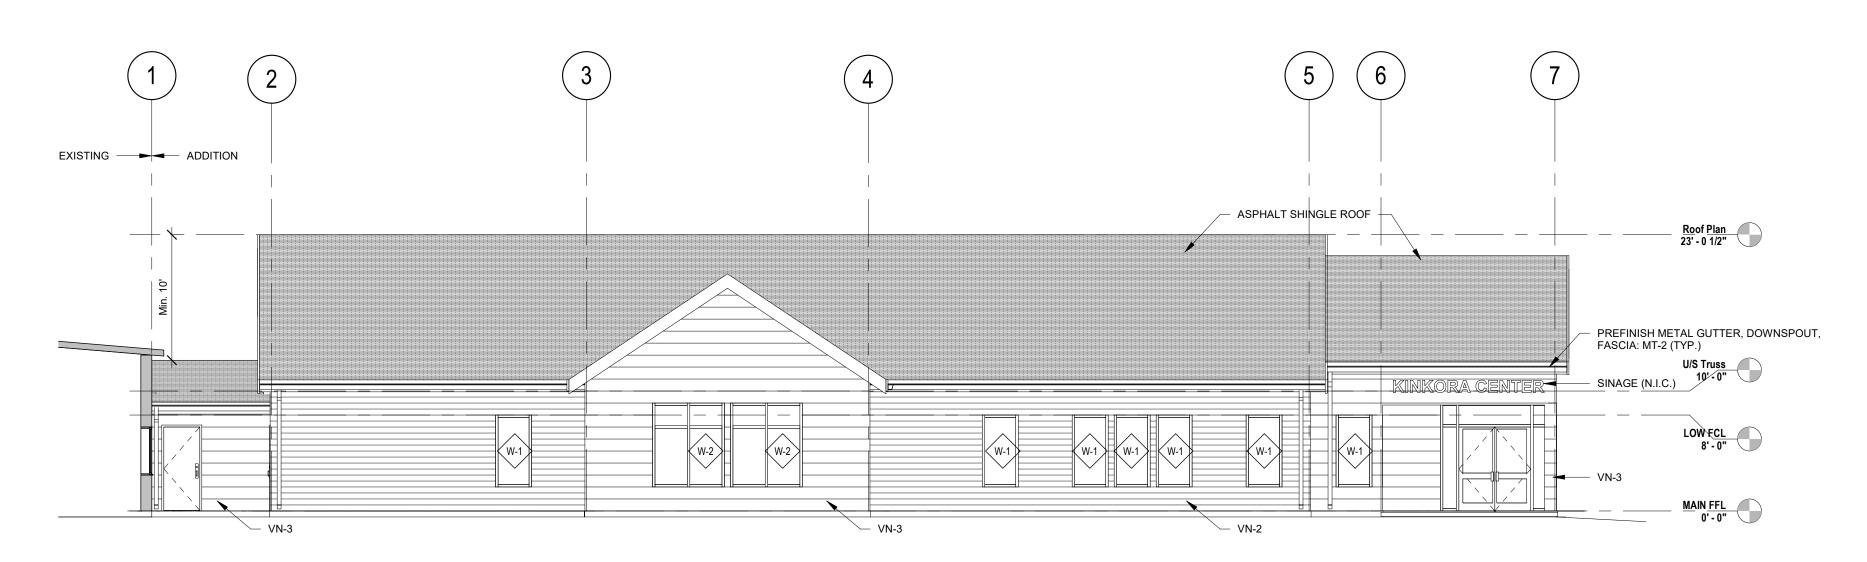




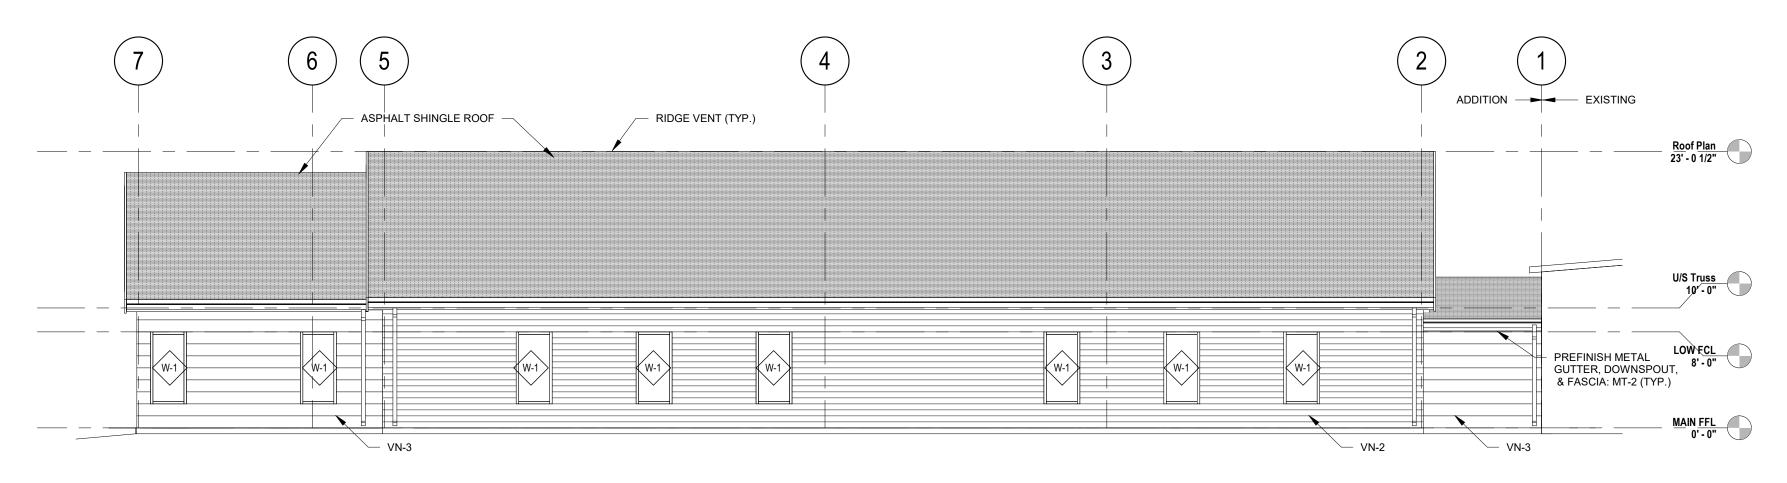

NORTH ELEVATION

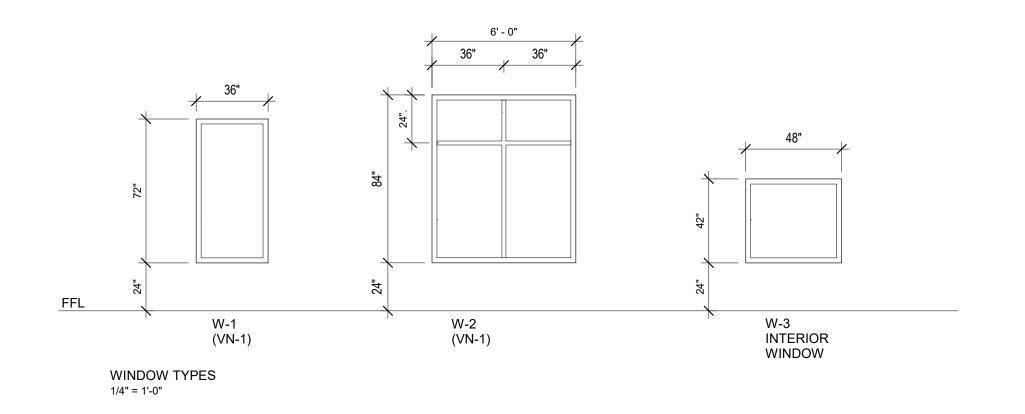

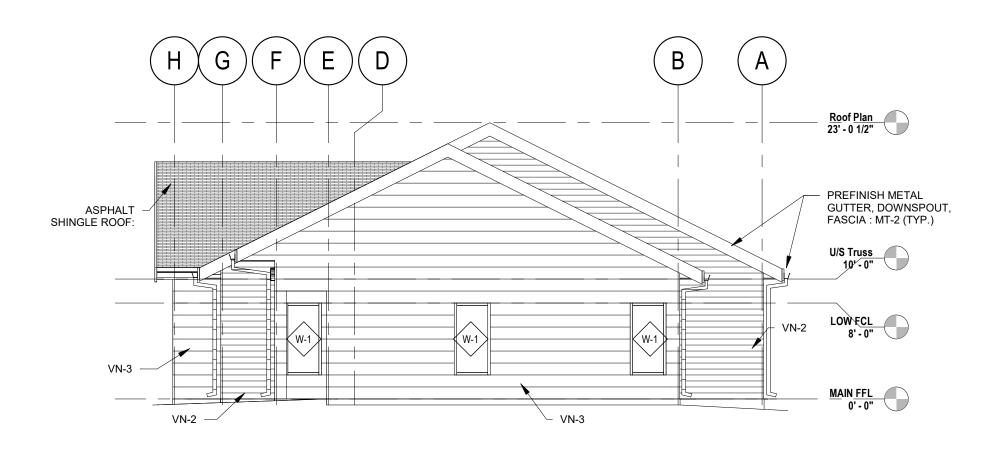


A200 EAST ELEVATION
1/8" = 1'-0"





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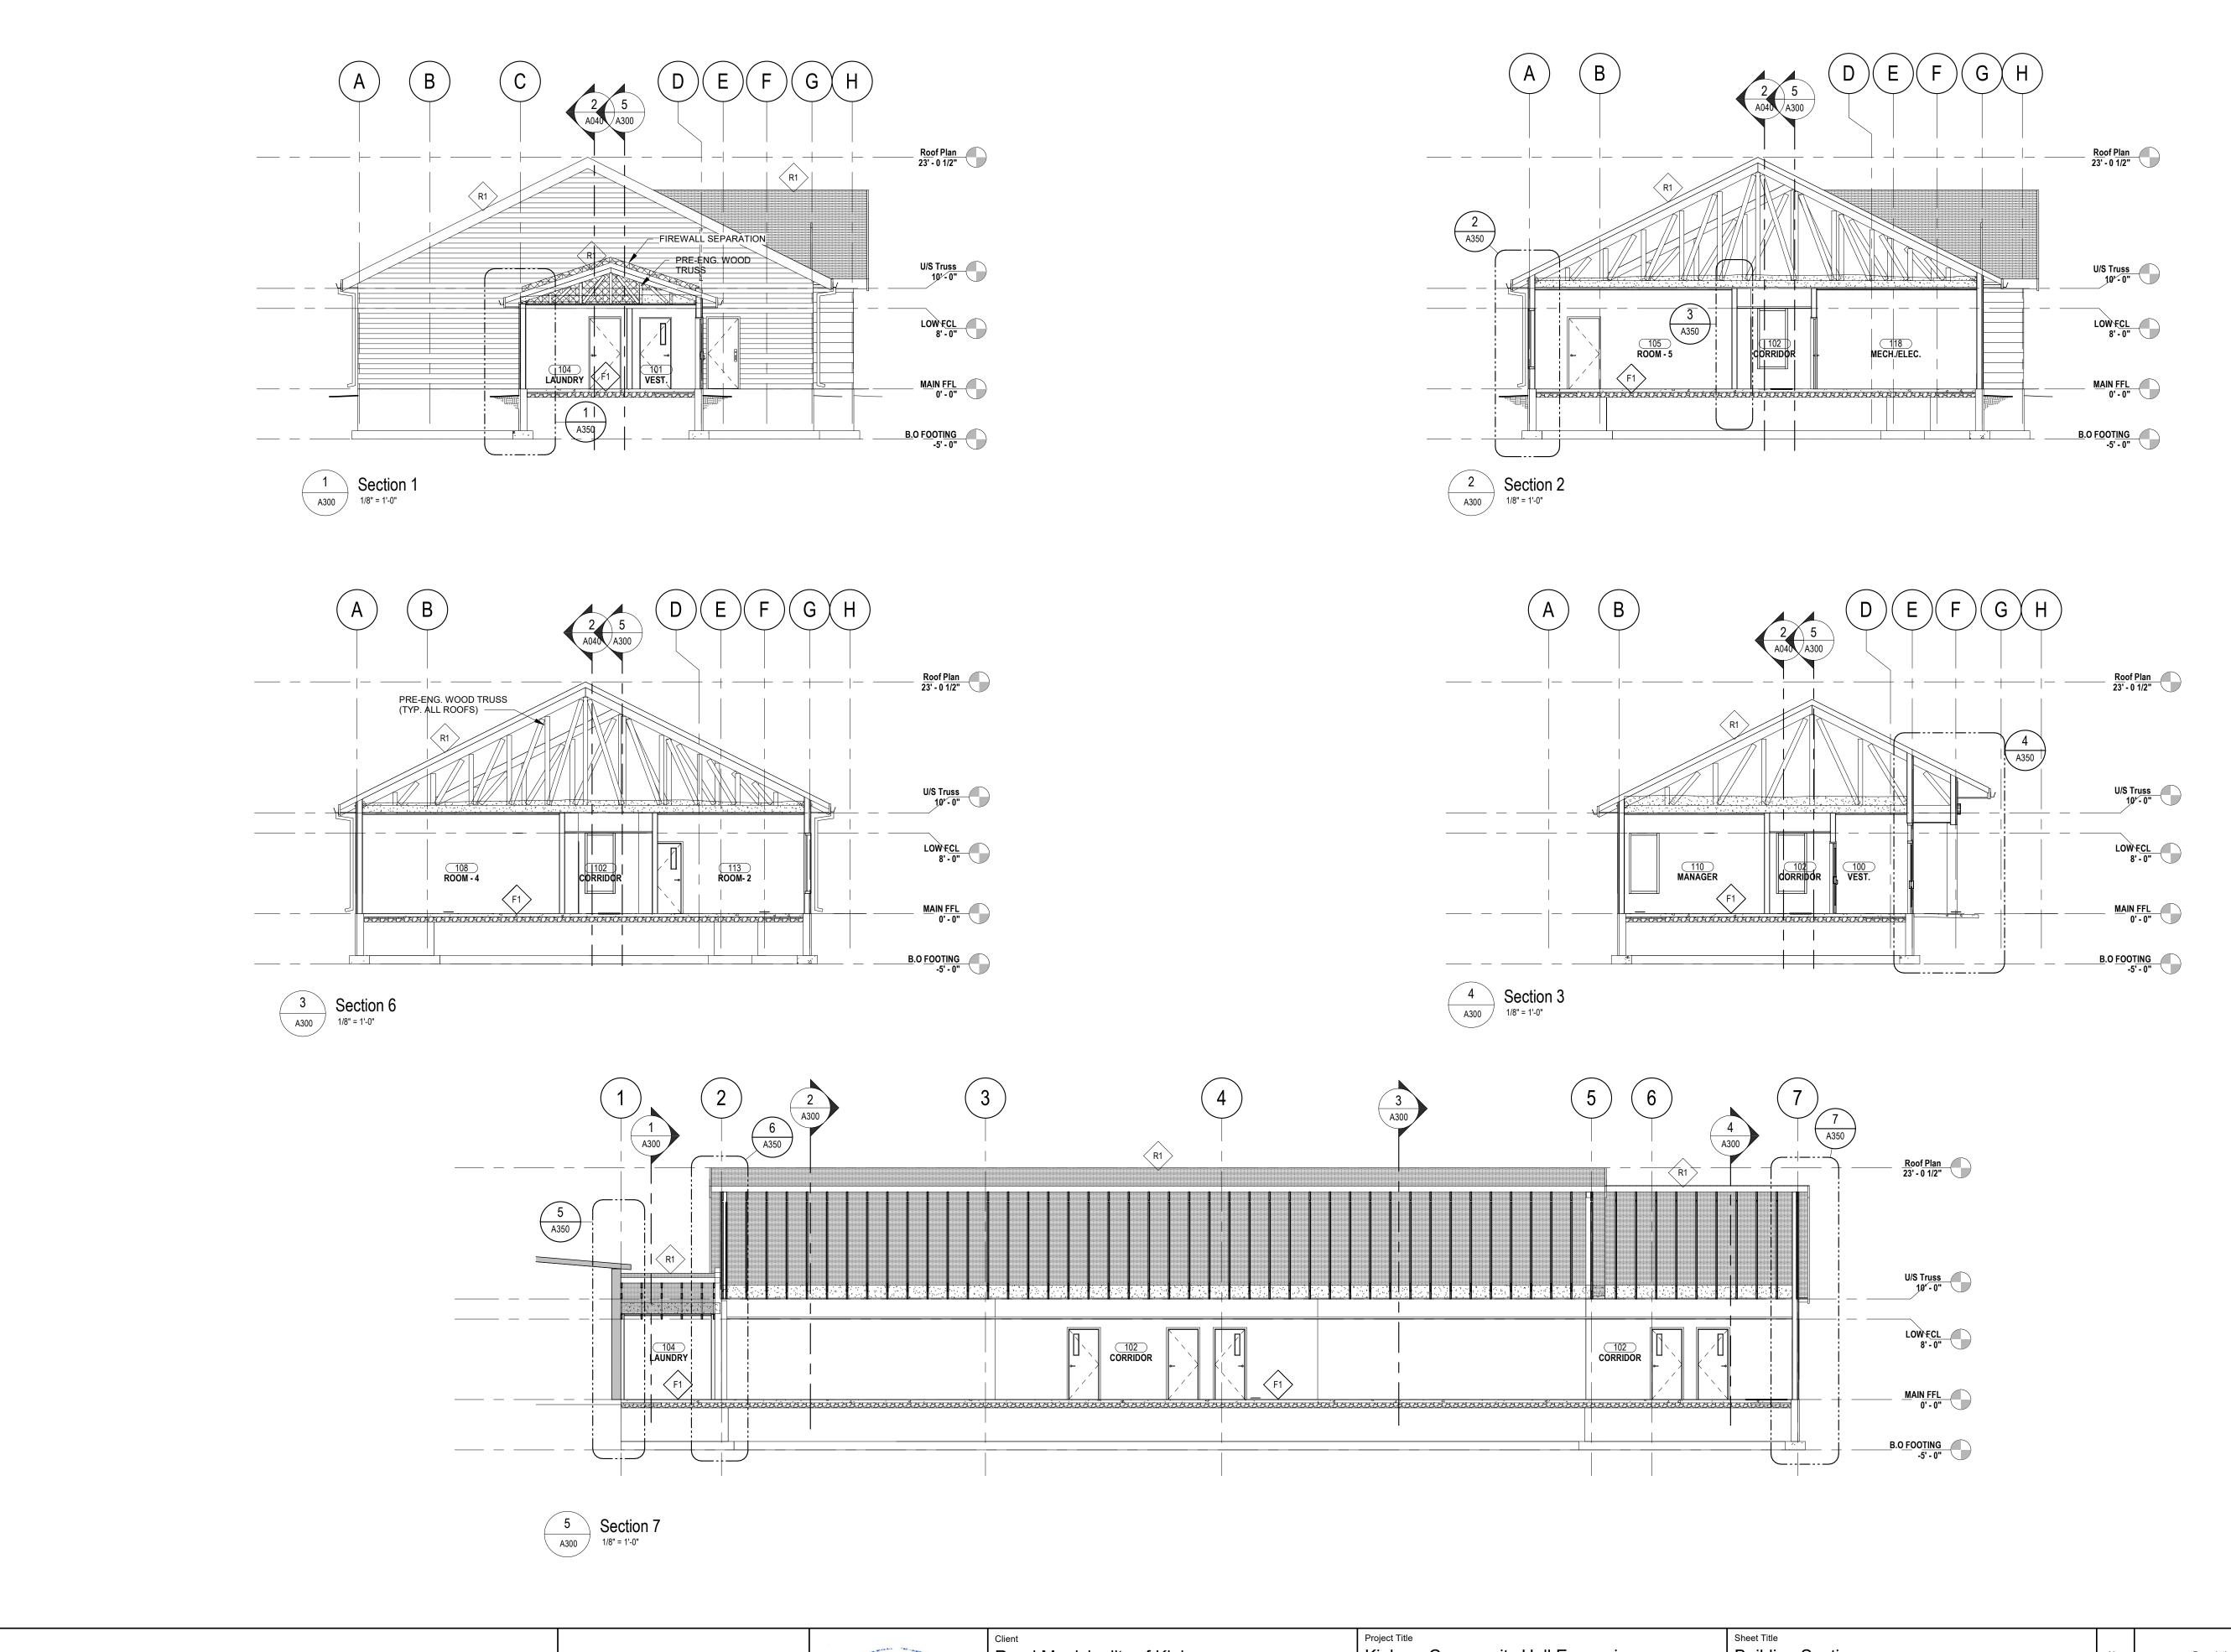
Rural Municipality of Kinkora

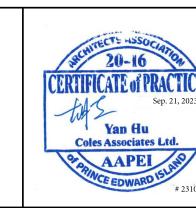Kinkora Community Hall Expansion

Sheet Title

Exterior Elevations


| Date | Date | 2023-09-21 | Revision | Date | 2023-09-21 | Drn By: SH / DC | Drn By: SDM | Project Number: | 231053 | Drawing Number: | A200




Building Sections Date: 2023-09-21 Revision Kinkora Community Hall Expansion Rural Municipality of Kinkora Description 2023-09-21 Dm By: DC Issued for Tender Chk By: SDM Suite 201, 85 Fitzroy Street Charlottetown, P.E.I., Canada, C1A 1R6 Phone: (902) 368-2300 Sep. 21, 2

Yan Hu

Coles Associates Ltd. Project Number: 231053 www.colesassoicates.com 2 AAPEI SLAW A300

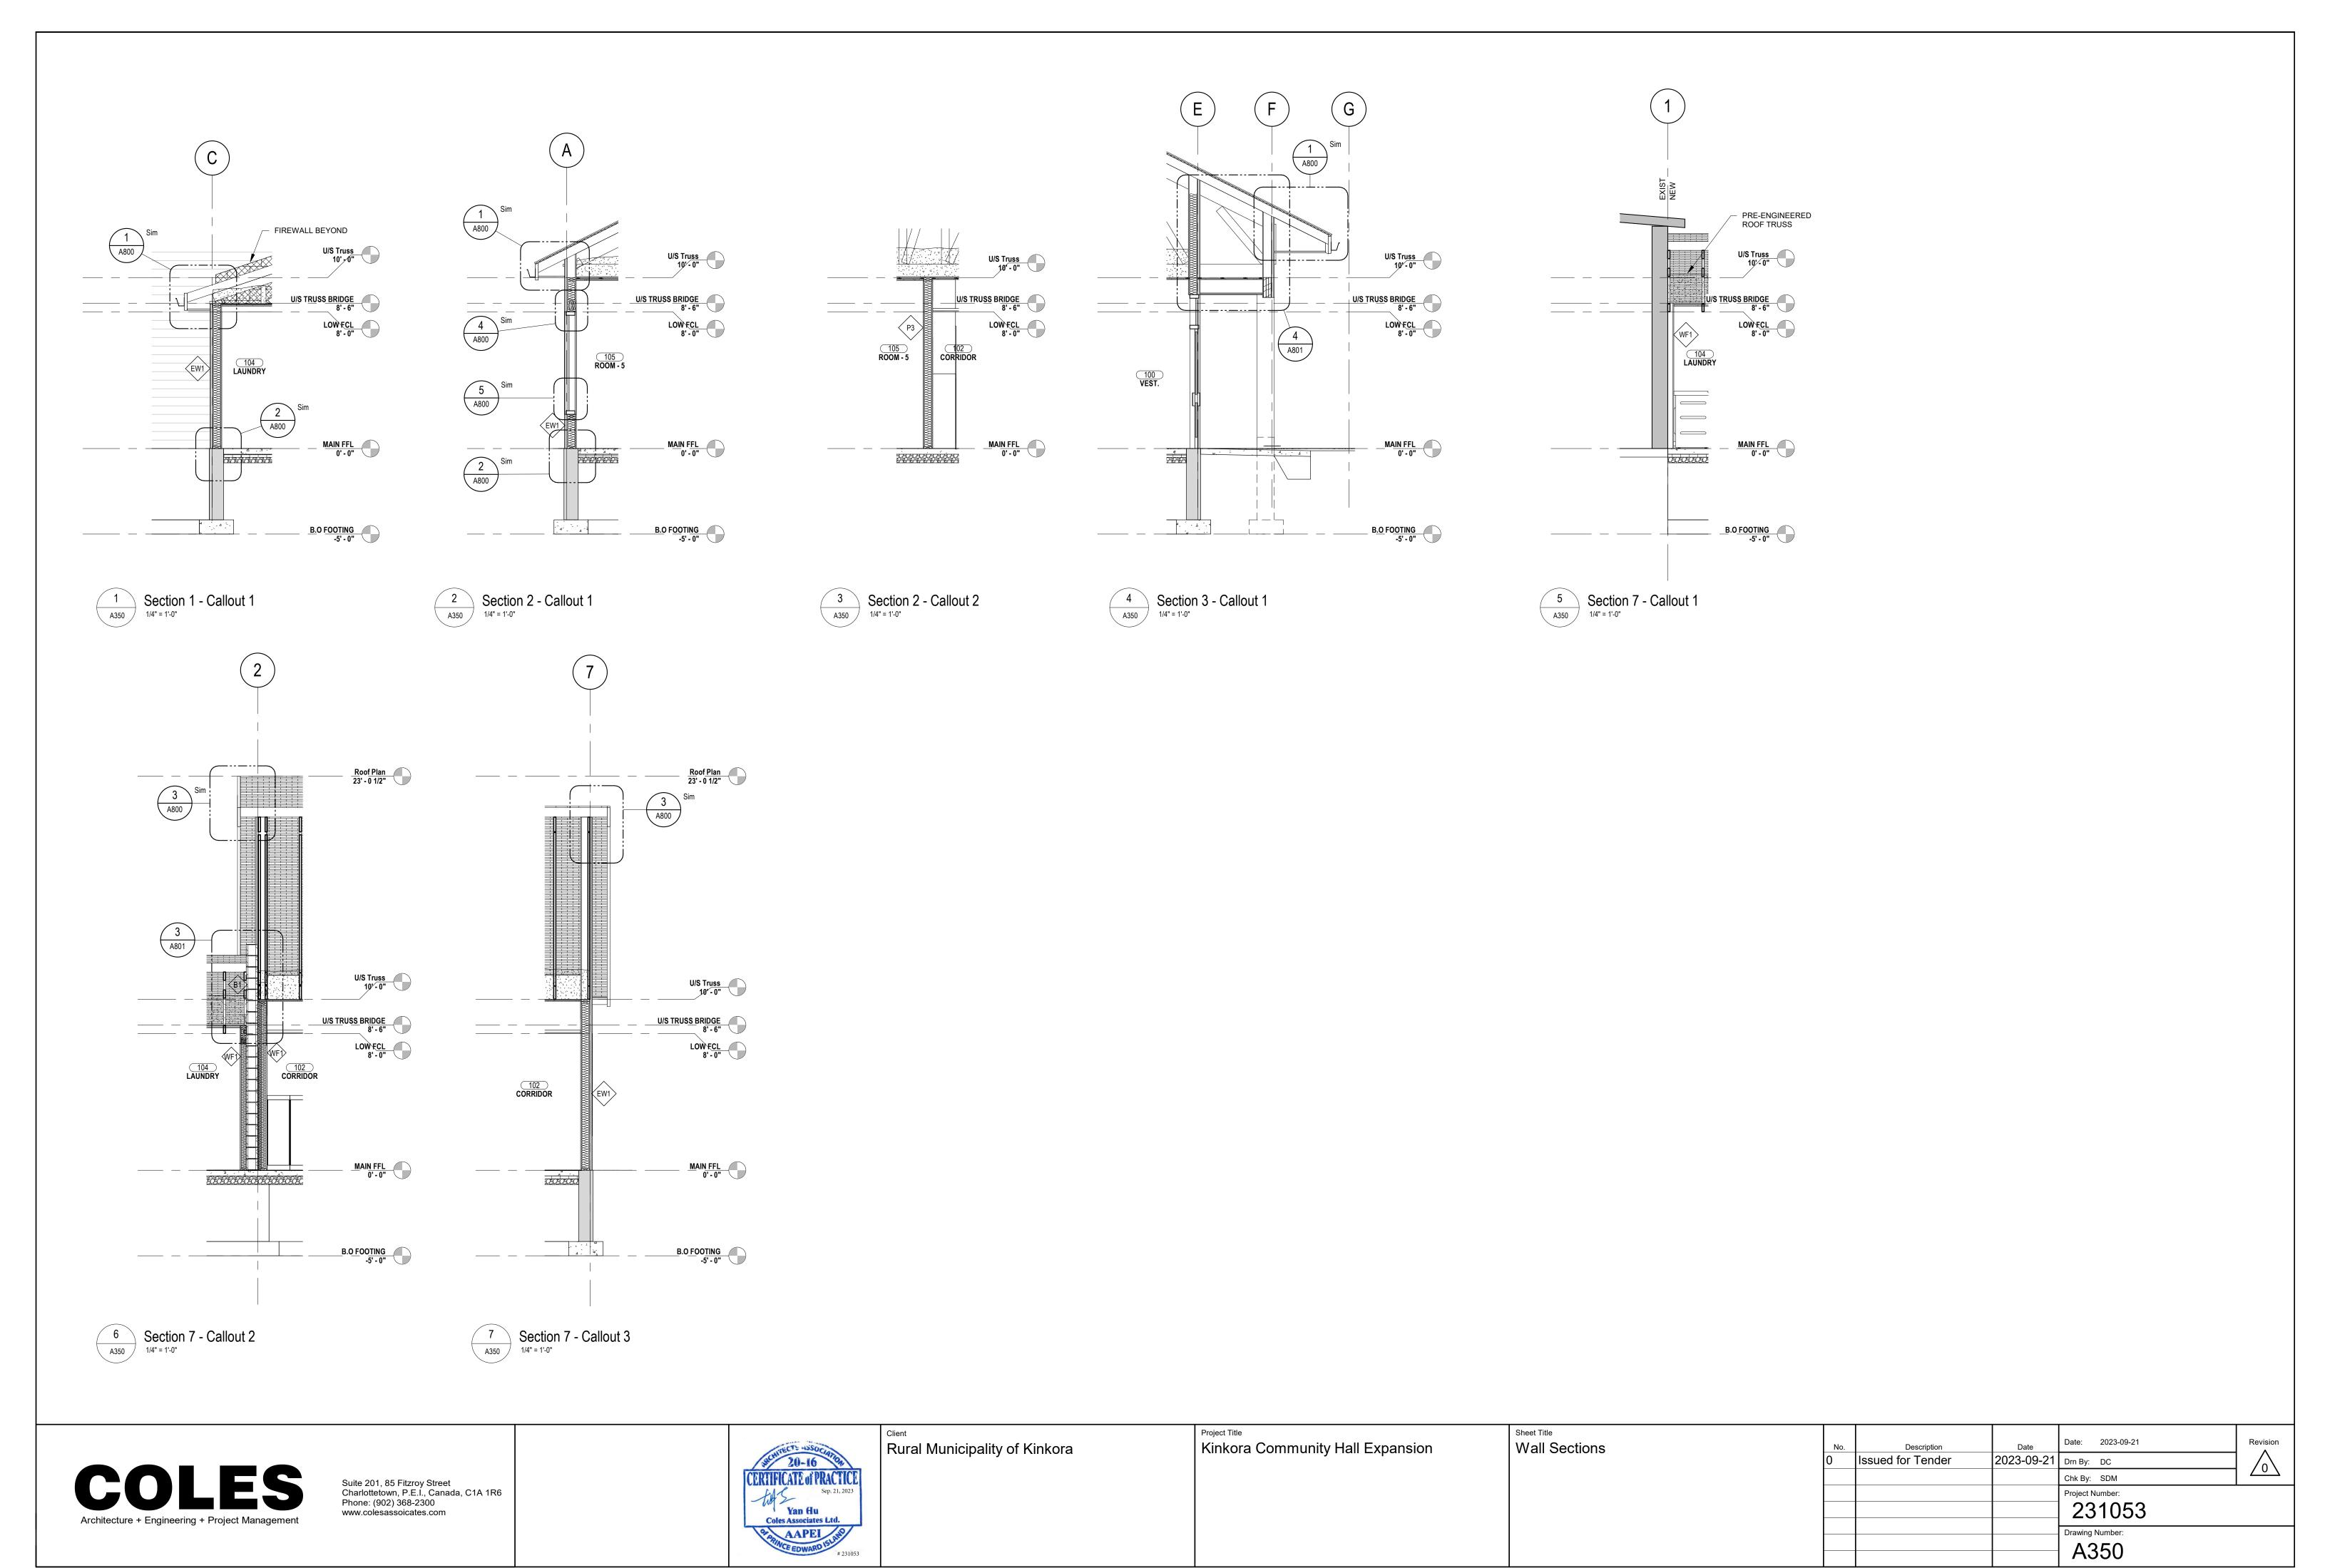

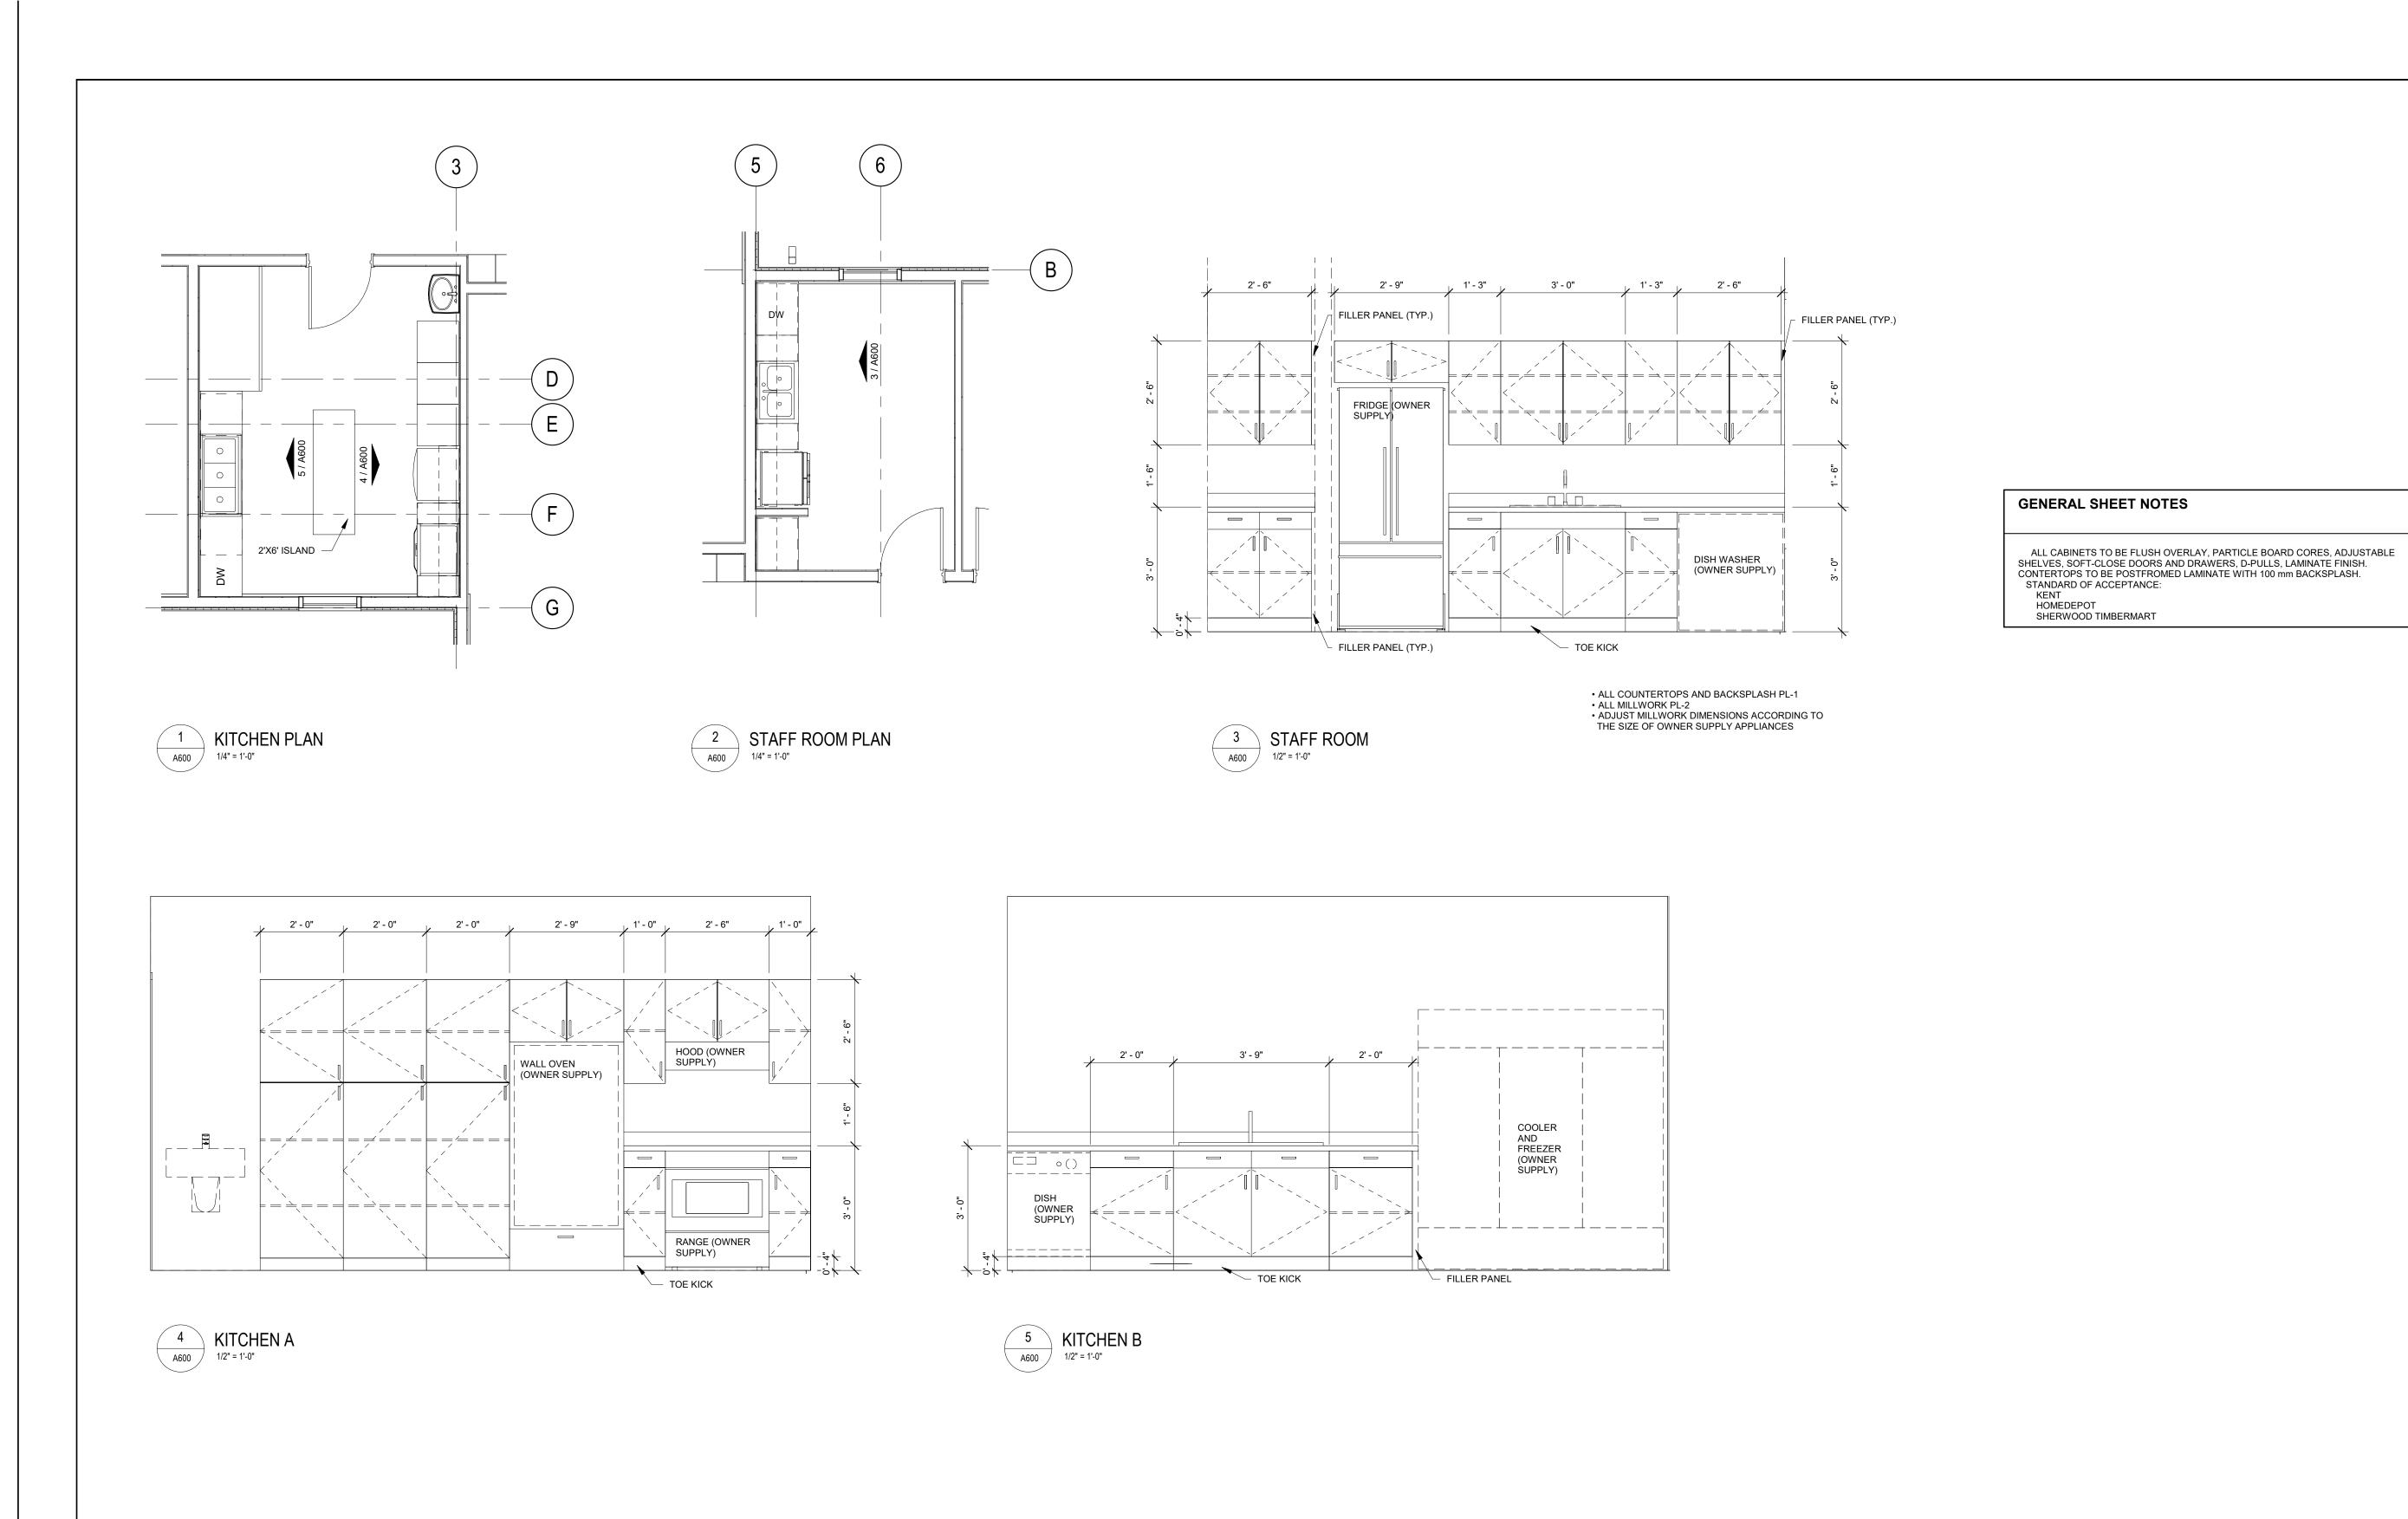

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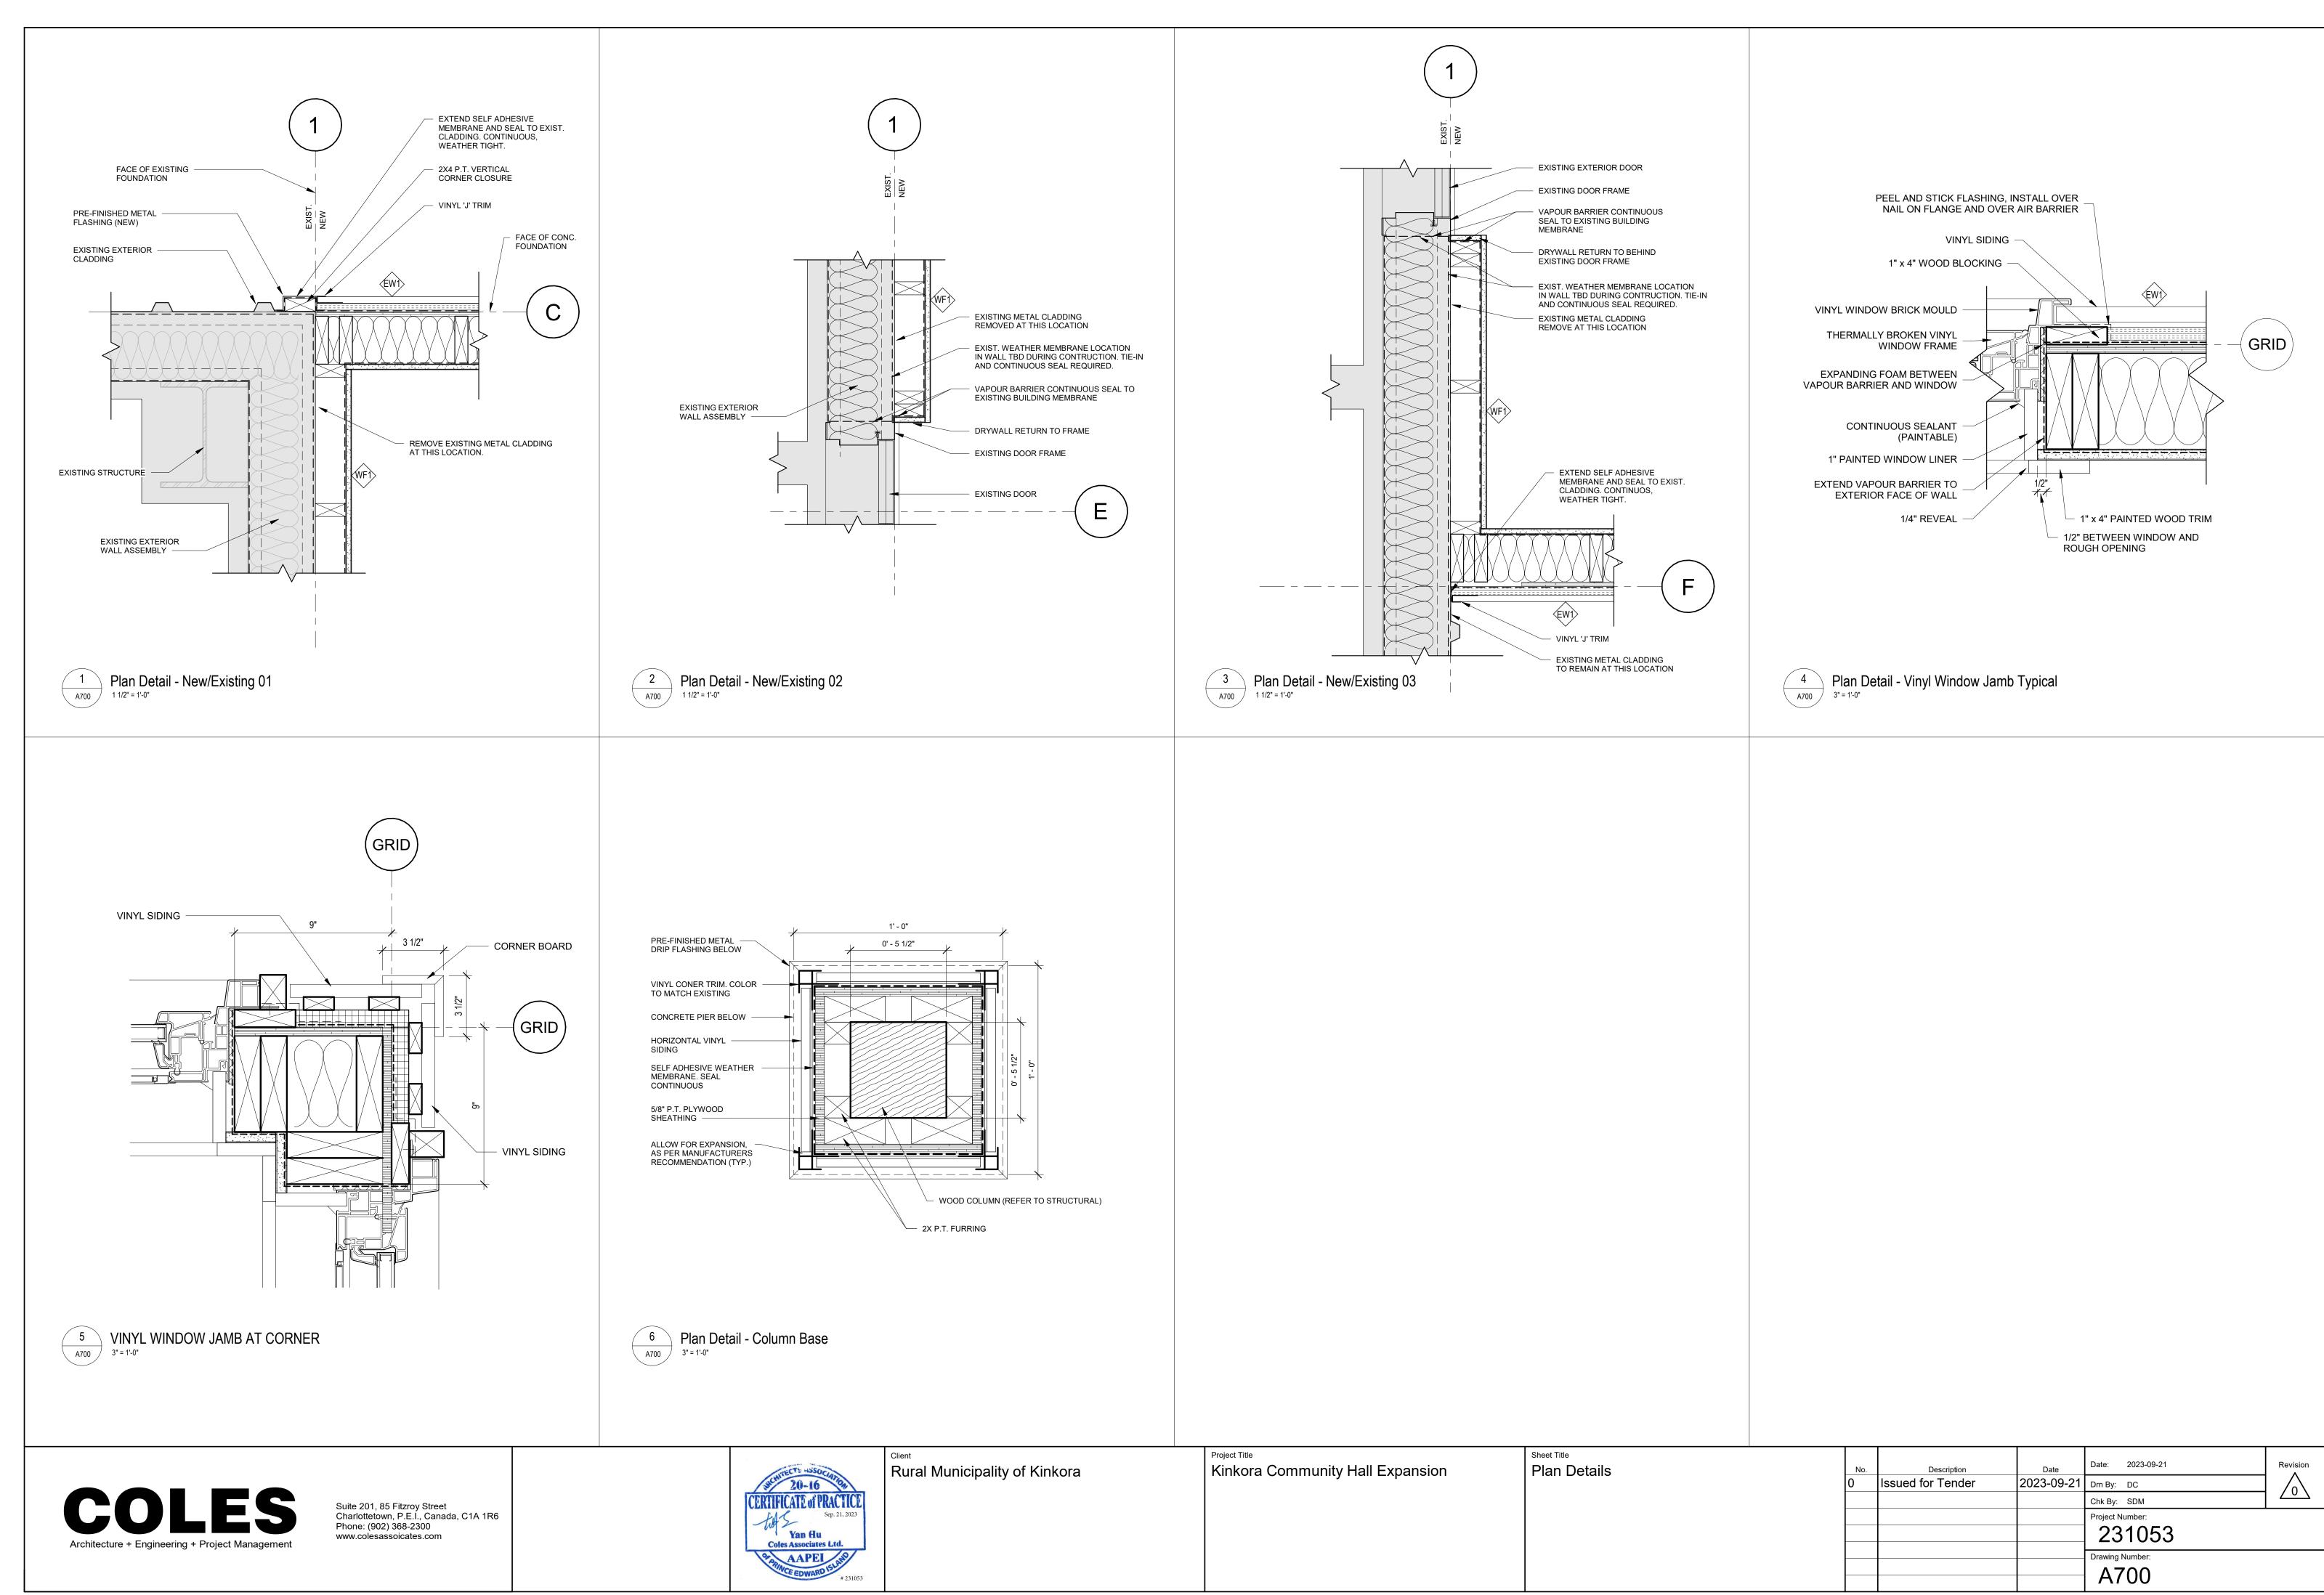
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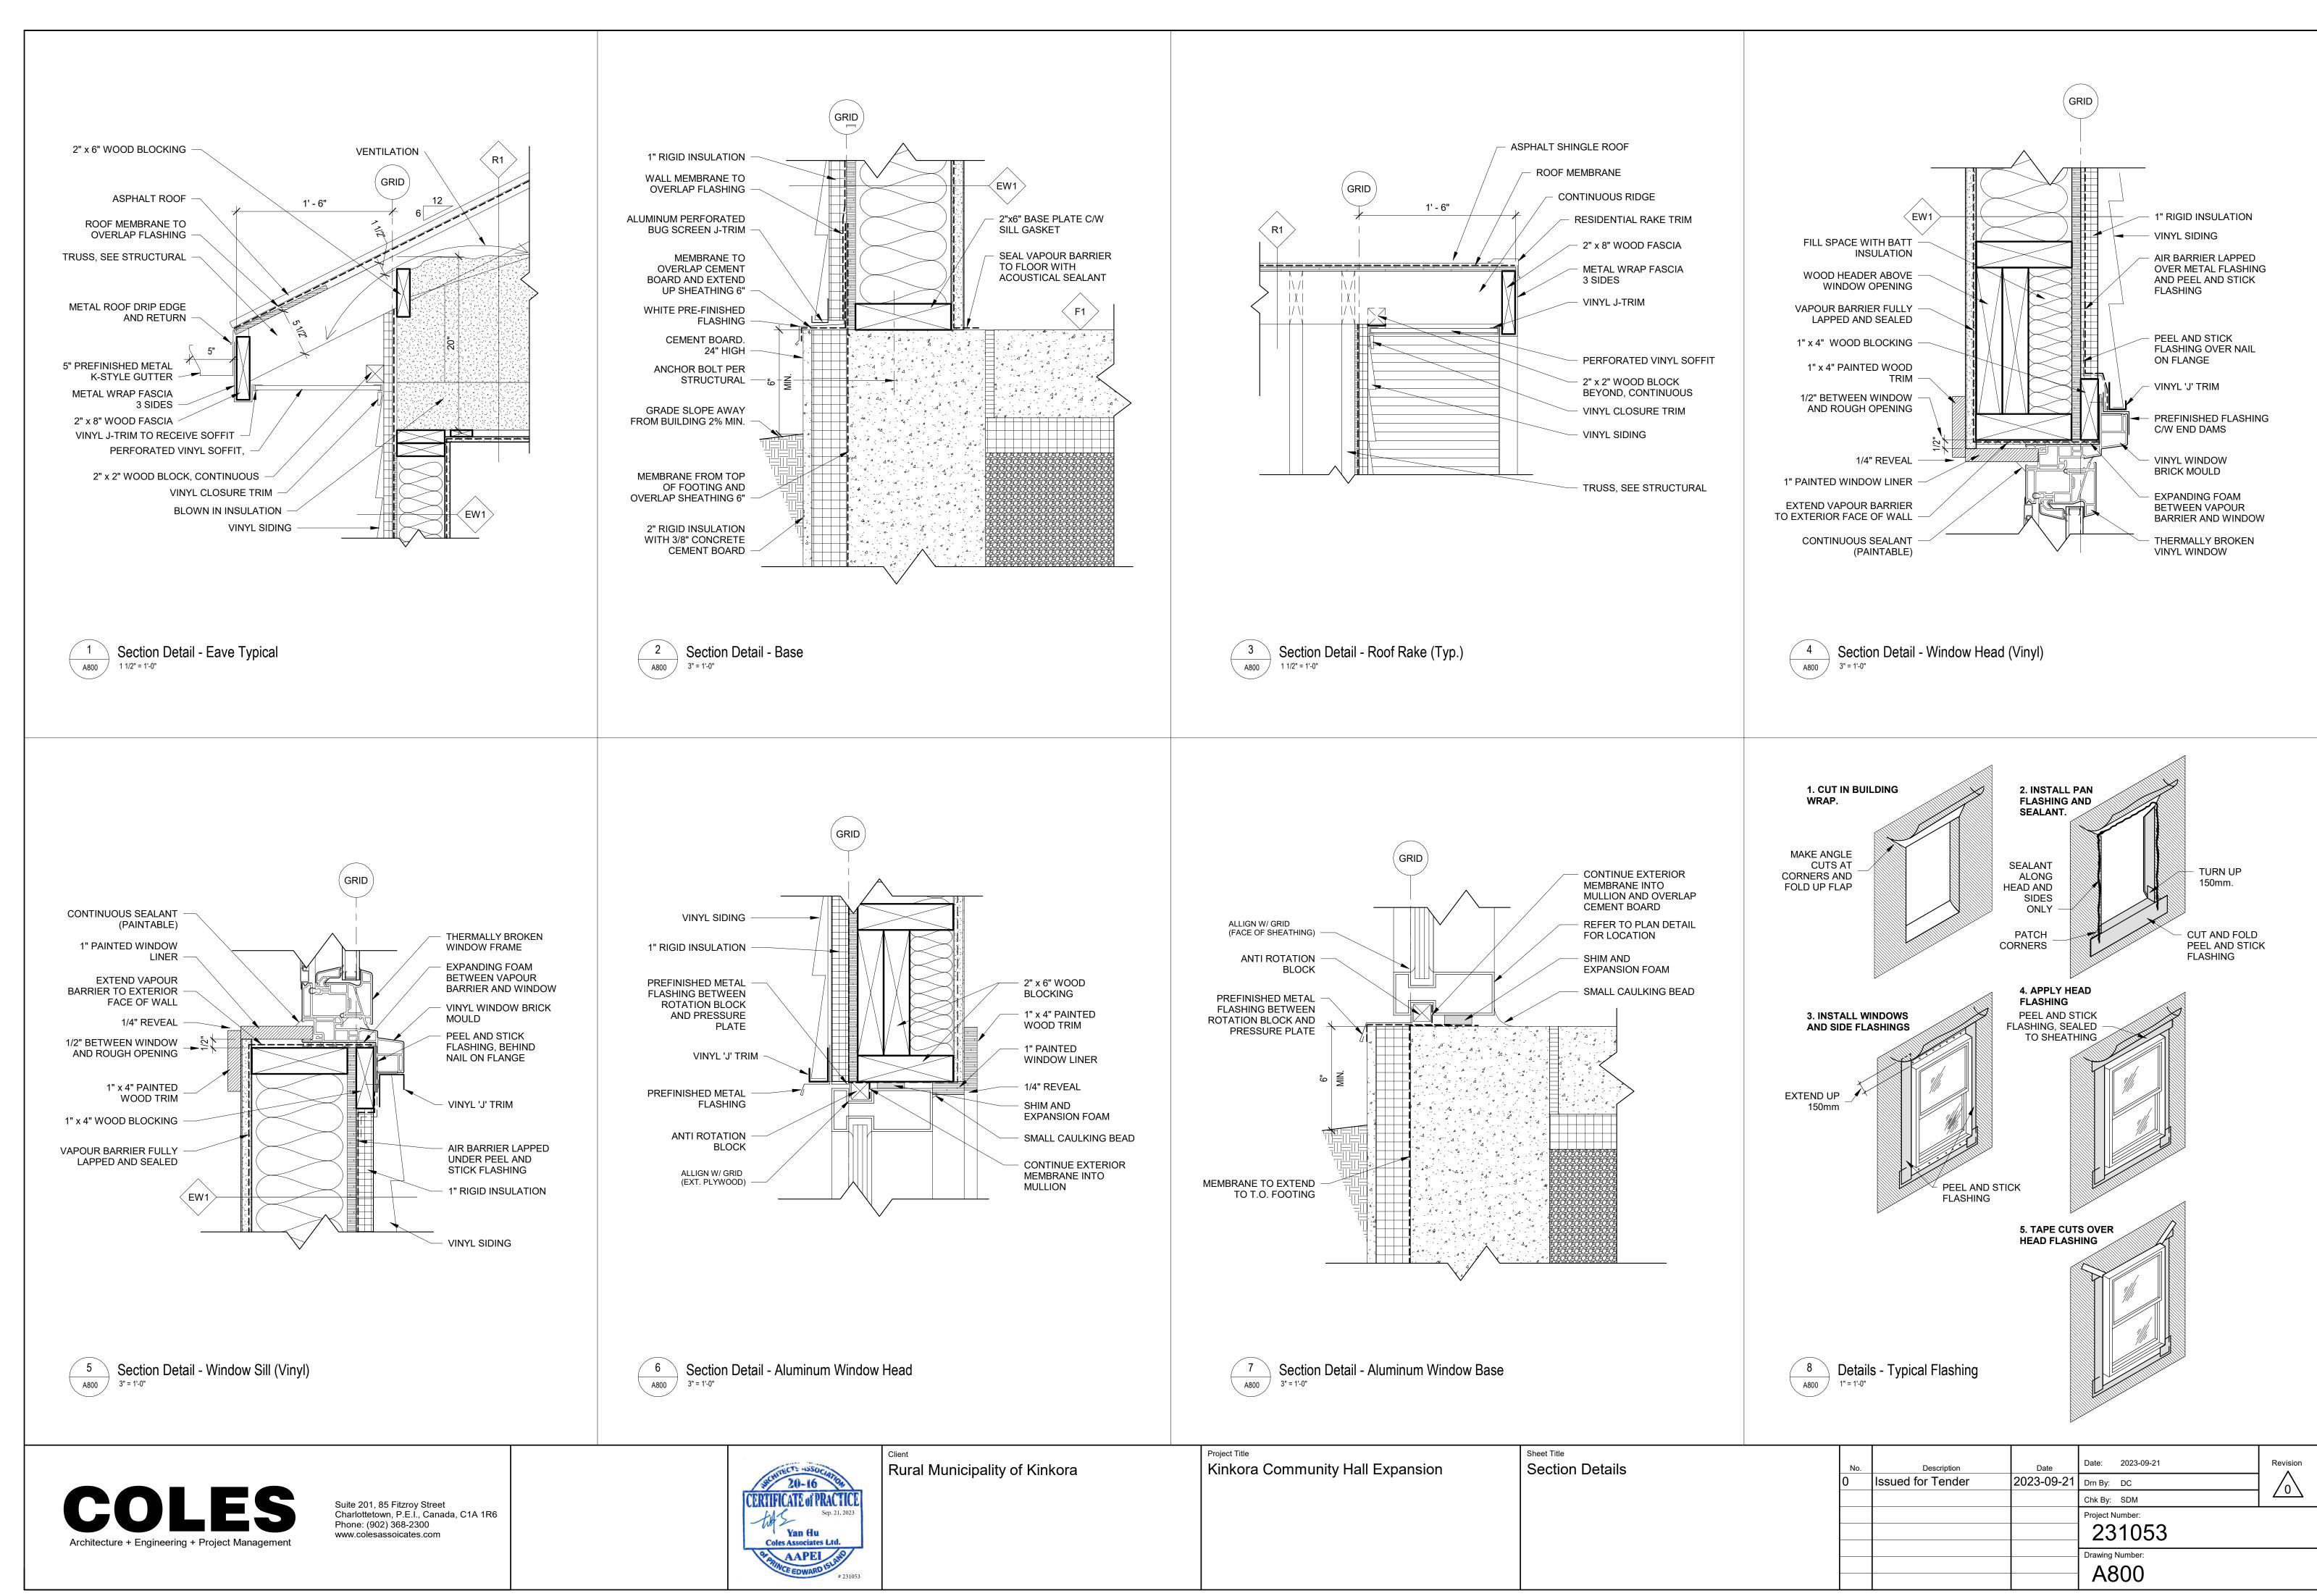
Rural Municipality of Kinkora


Kinkora Community Hall Expansion


Rural Municipality of Kinkora


| No. | Description | Date | 2023-09-21 | Drm By: SH | Chk By: SDM | Project Number: | 231053 | Drawing Number: | A600 |





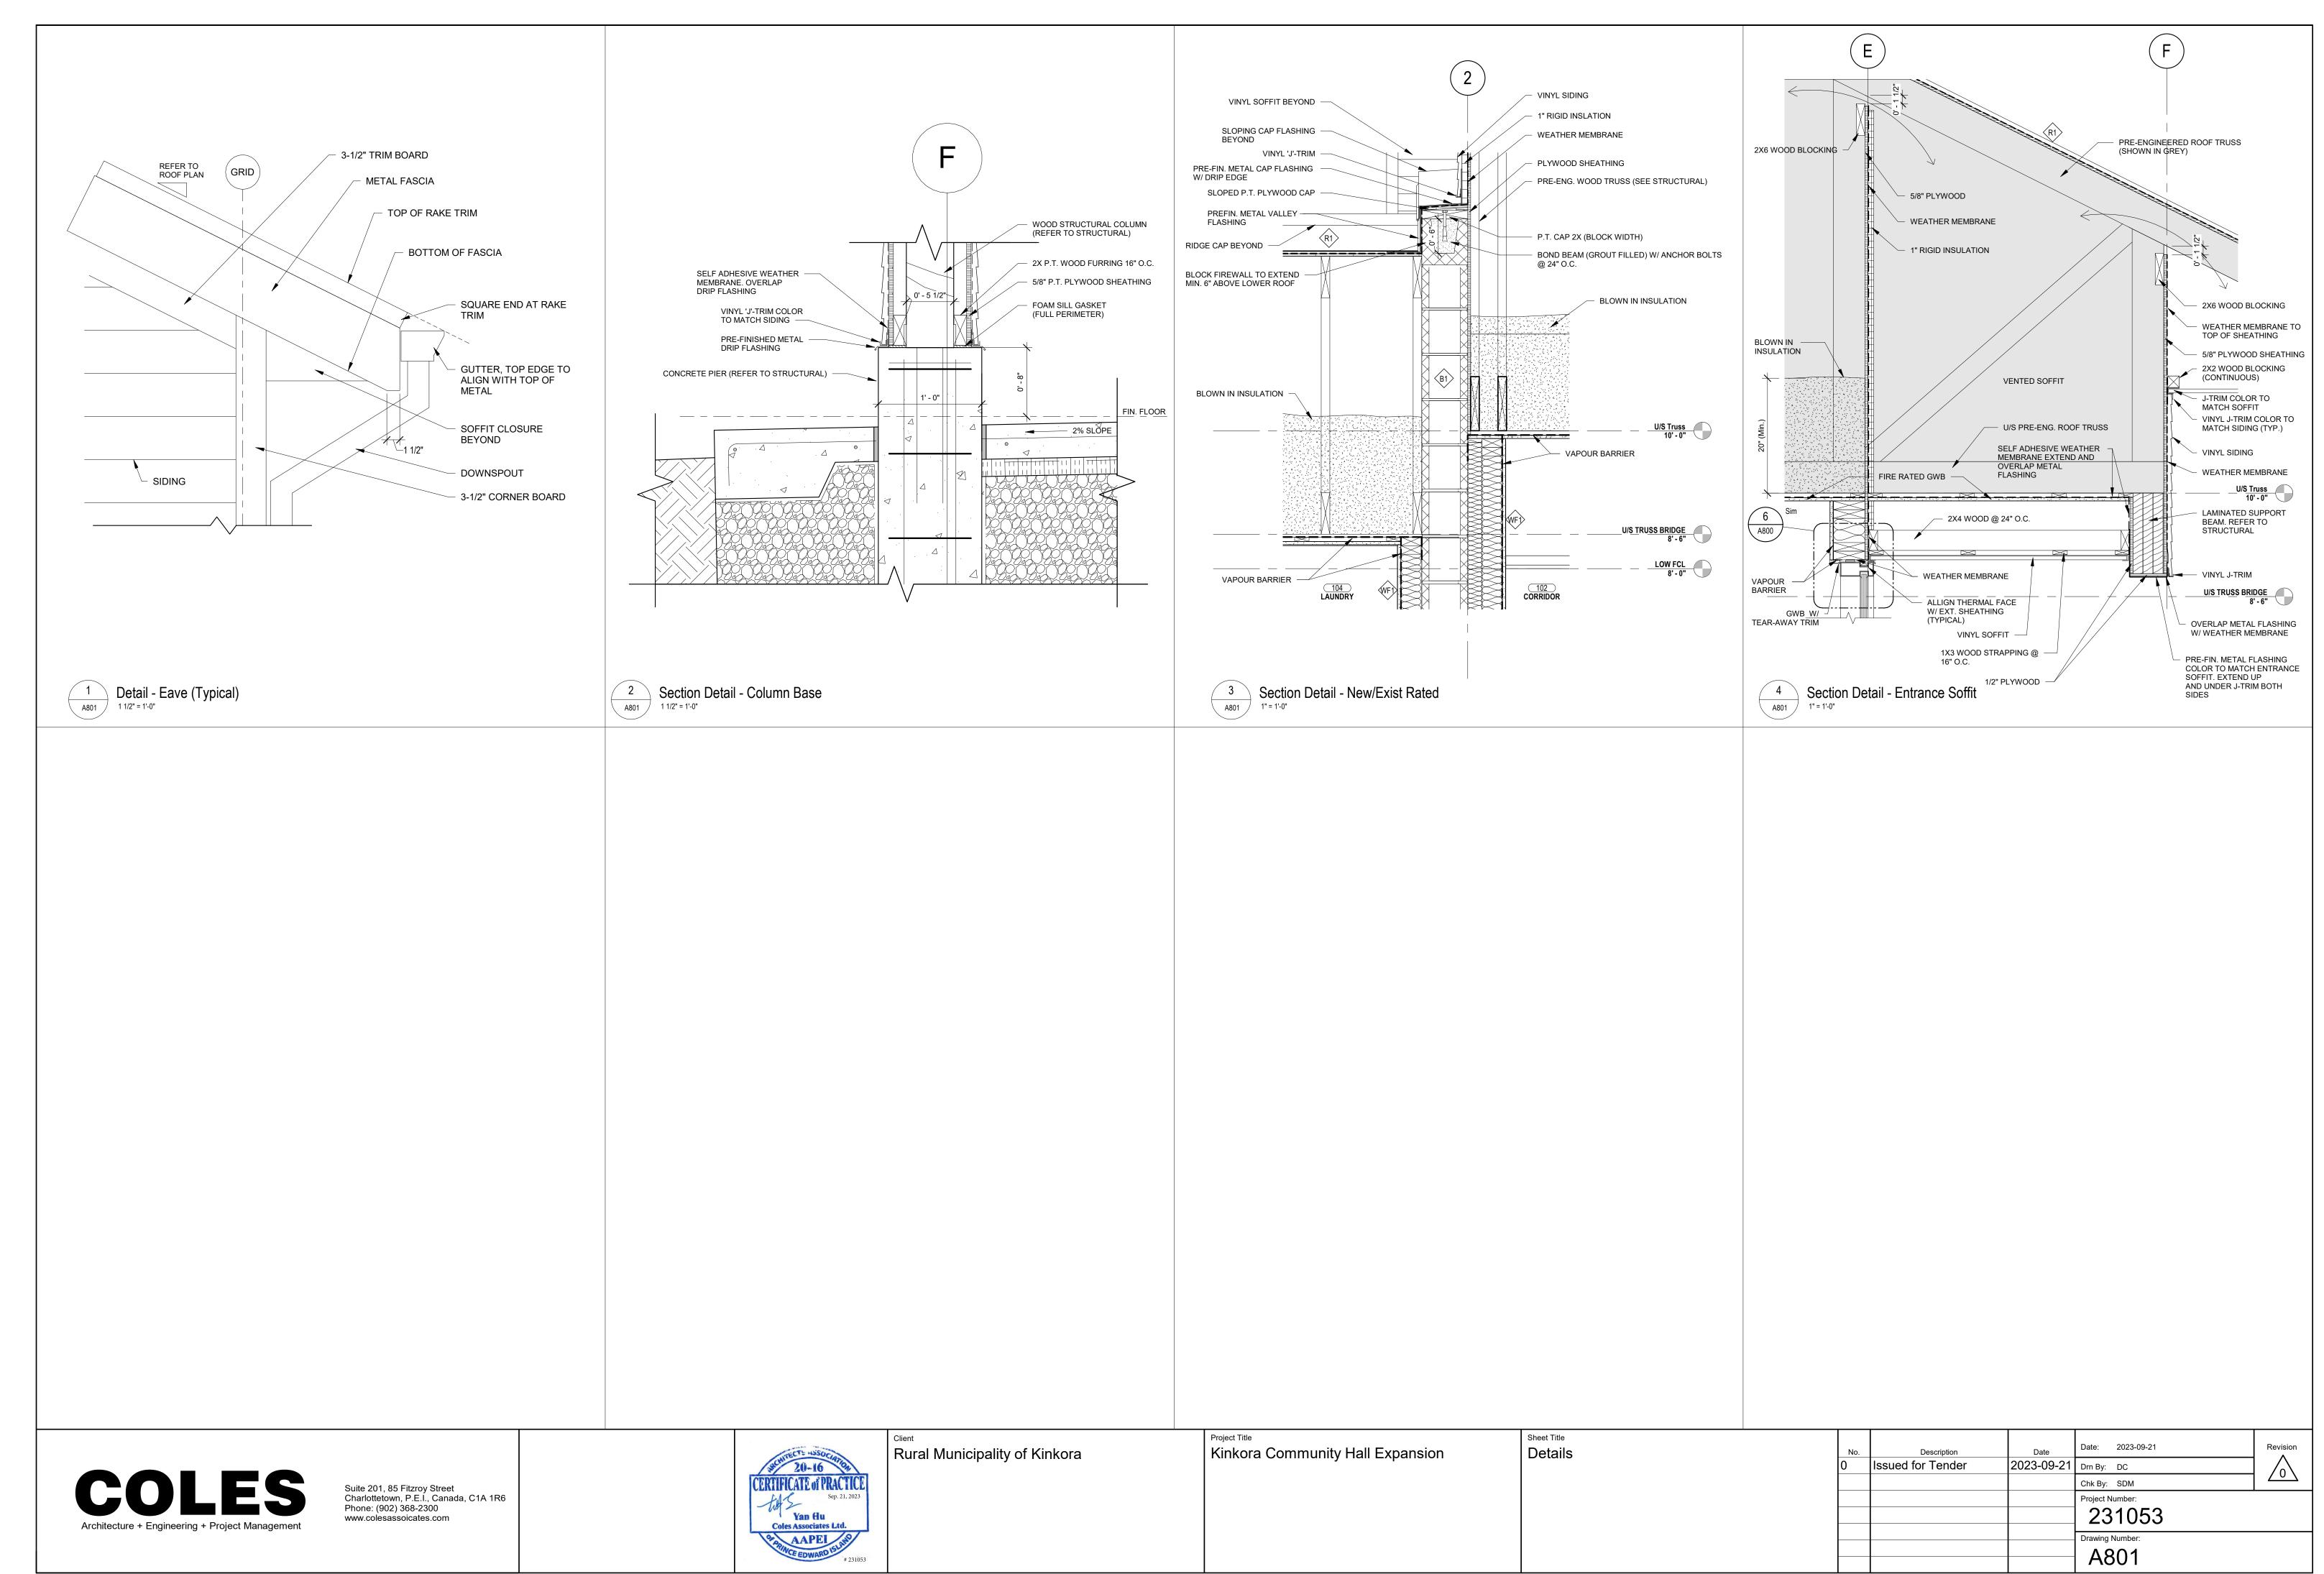

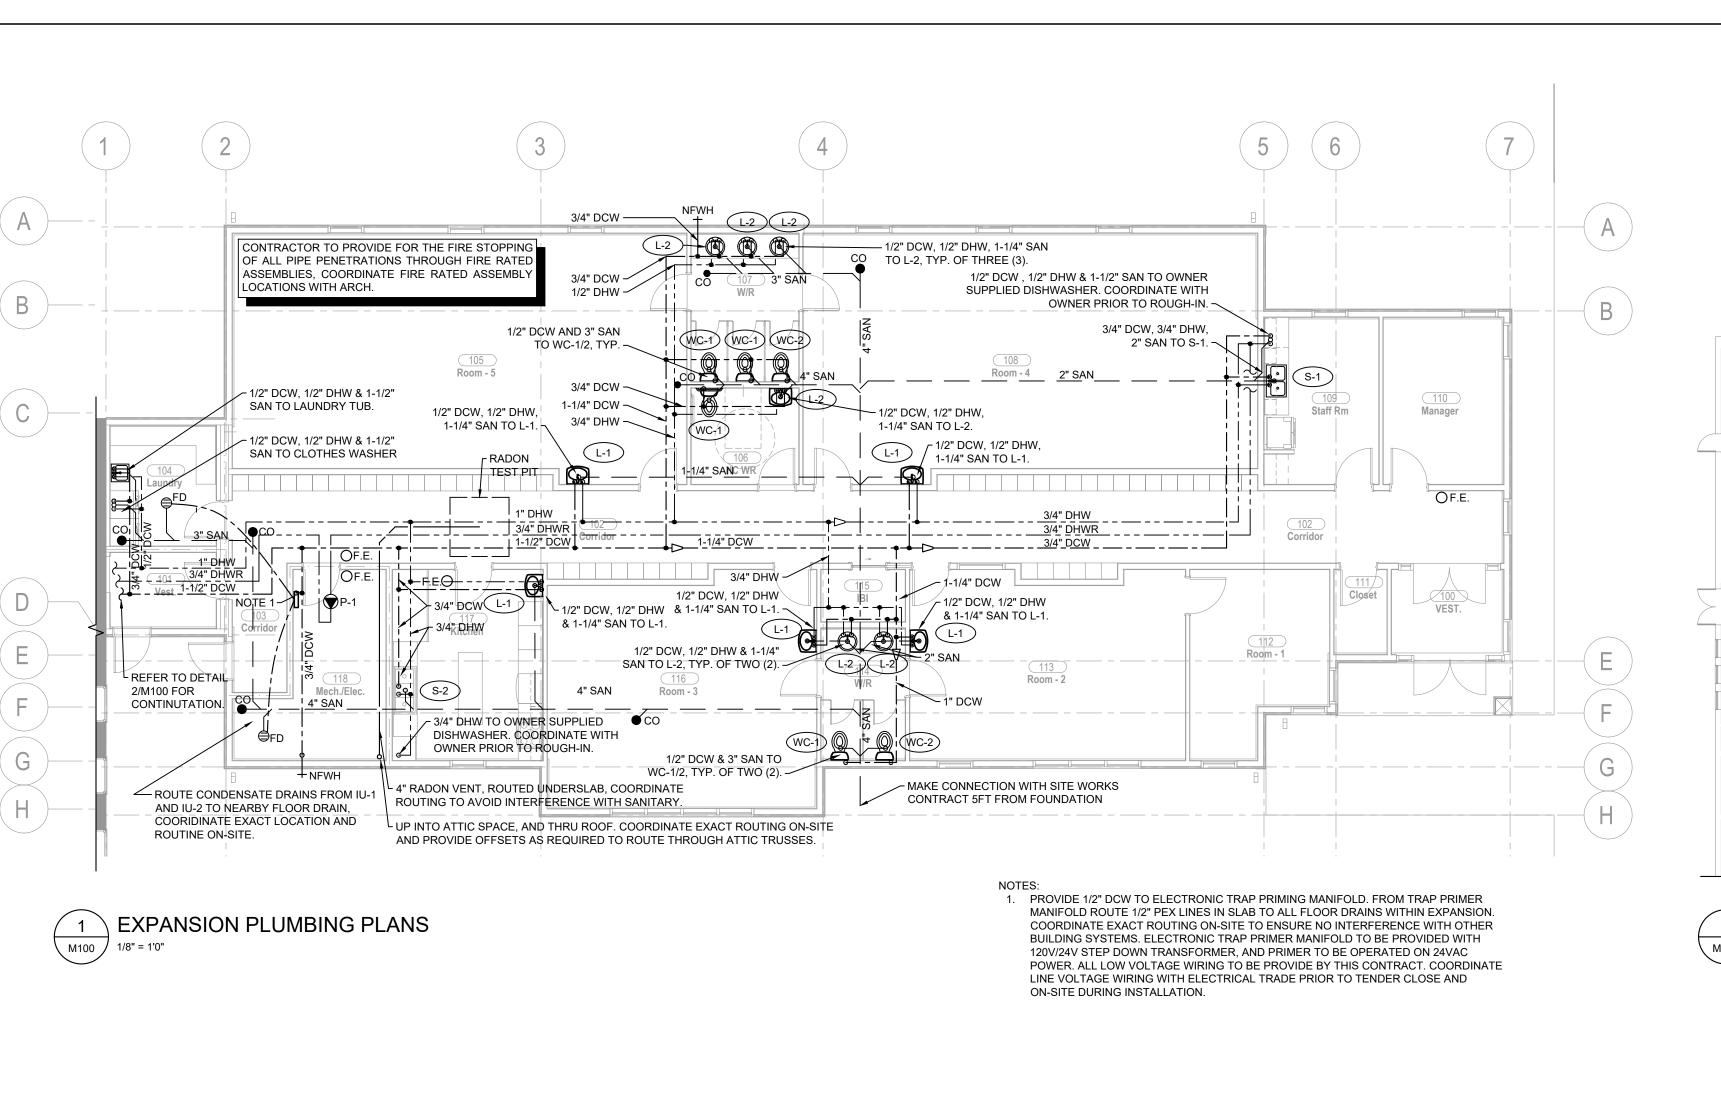

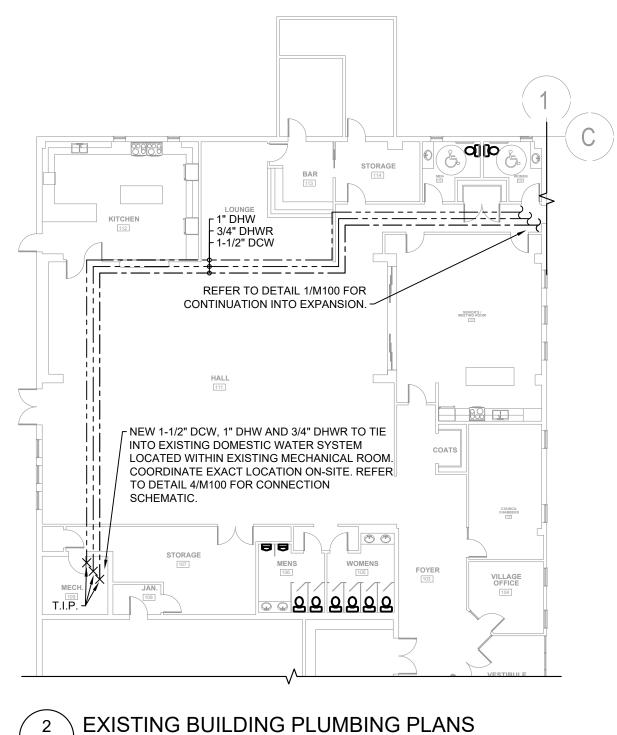

CONNECTIONS

SELF-RIMMING, COUNTER

MOUNTED RECTANGULAR

DOUBLE BASIN SINK

SELF-RIMMING, COUNTER

MOUNTED RECTANGULAR

TRIPLE BASIN SINK

SELF-RIMMING OVAL COUNTER

TOP SINK

BARRIER-FREE WALL-HUNG

OVERFLOW

L-2 | 1-1/4" | 1/2" | 1/2" | BASIN, FAUCET LEDGE, WITHOUT | VIT. CHINA |

STAINLESS

STEEL

STEEL

AMERICAN

STANDARD

FRANKE


AMERICAN

STANDARD

AMERICAN

STANDARD

| DWV | DCW | DH\

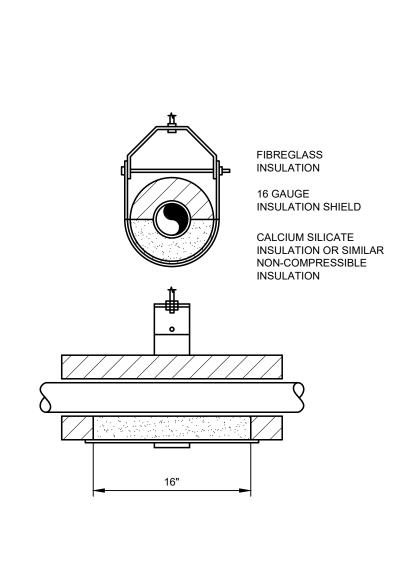

3 PIPE INSULATION SHIELDS


LOCATION / APPLICATION


BURIED (U/G) DWV PIPING

A/G DWV PIPING WITHIN COMBUSTION CONSTRUCTION

A/G DWV WITHIN PLENUM SPACES OR EXPOSED OCCUPIABLE SPACES


DRAIN, WASTE AND VENT PIPING MATERIAL SCHEDULE

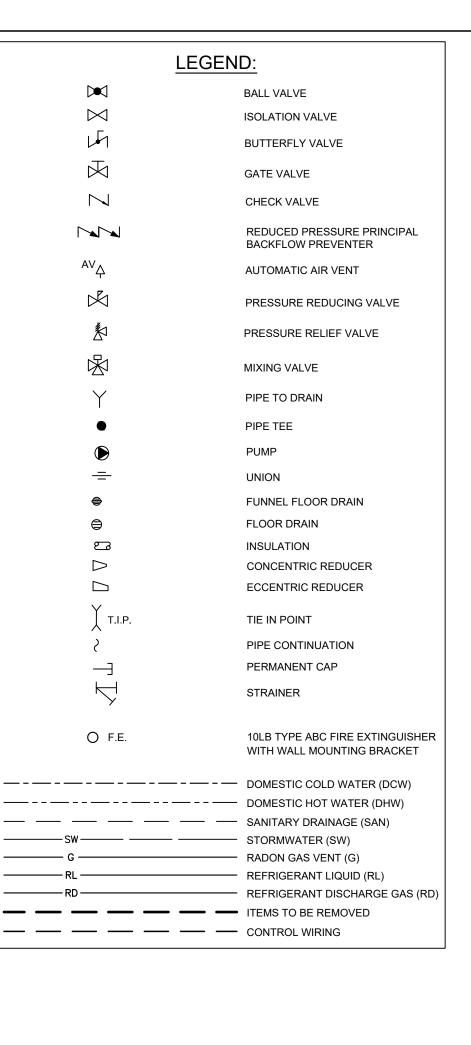

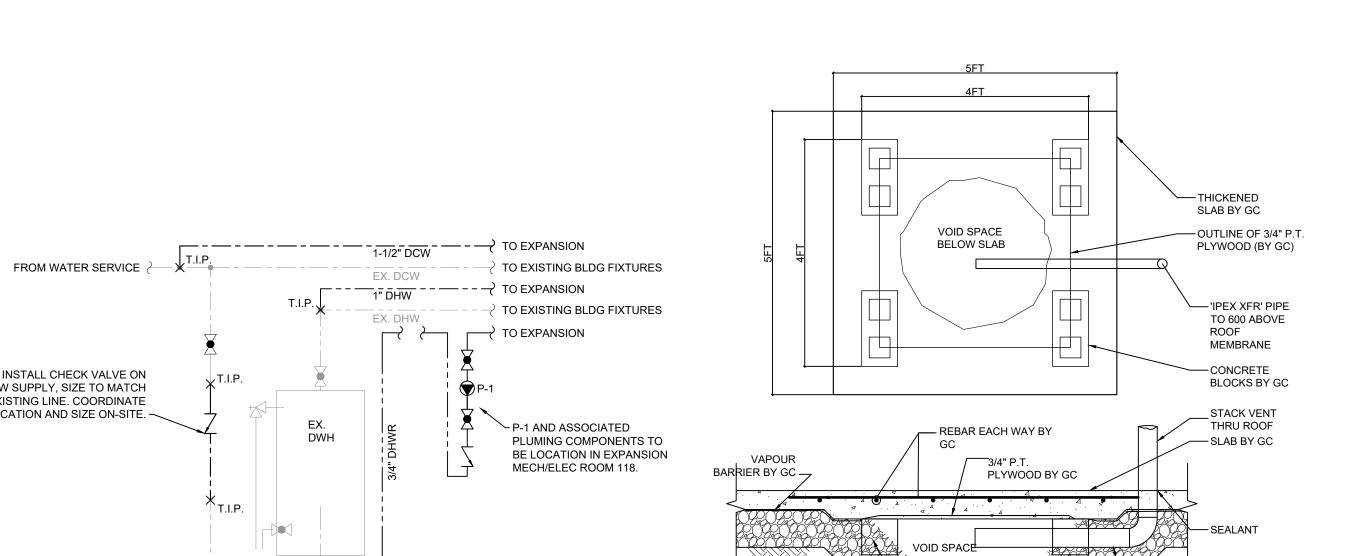


GRANULAR BASE TO MEET RADON-TRANSMISSION QUALITIES.

CONFIRM W/ CONSULTANT

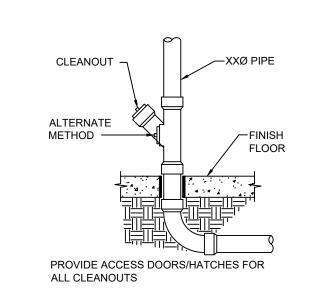

1/16" = 1'0"



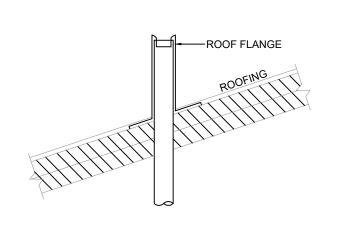



			F	PLUMBING FIXTURE SC	HEDULE			
FIXT	URE SPECIFIC	CATIONS			TRIM SPECIF	ICATIONS		
TYPE	MATERIAL	BASIS OF DESIGN		TYPE	ACTUATION	BASIS OF DESIGN		ADDITIONAL NOTES
TIPE	WATERIAL	MANUFACTURER	MODEL	ITPE	ACTUATION -	MANUFACTURER	MODEL	
LOOR MOUNTED, BARRIER FREE, ELONGATED BOWL ATER CLOSET, WITH FLUSH TANK	VIT. CHINA	AMERICAN STANDARD	CADET PRO, RIGHT-HEIGHT ELONGATED	-	-	-	-	FLOW LIMITED TO 4.8 LITRES PER FLUSH; OPEN FRONT SEAT; PROVIDE ANGLE SHUTOFF WITH ESCUTCHEON AND FLEX HOSE. FLUSH VALVE TO BE LOCATED ON TRANSFER SIDE AS NOTED.
FLOOR MOUNTED, 10" HIGH ELONGATED BOWL WATER CLOSET, C/W FLUSH TANK	VIT. CHINA	AMERICAN STANDARD	BABY DEVORO FLO-WISE	-	-	-	-	FLOW LIMITED TO 4.8 LITRES PER FLUSH; OPEN FRONT SEAT; PROVIDE ANGLE SHUTOFF WITH ESCUTCHEON, FLEX HOSE AND TOILET SEAT. FLUSH VALVE TO BE LOCATED ON TRANSFER SIDE AS NOTED.

MANUAL

MANUAL

AUTOMATIC

HARDWIRED

AUTOMATIC

ACCEPTABLE MATERIALS

CAST IRON, COPPER, ABS, PVC (IPEX SYSTEM 15 OR EQUAL)

CAST IRON, COPPER, PVC WITH 25/50 FLAME/SMOKE RATING (IPEX

AMERICAN

STANDARD

ADVANCE TABCO

DELTA

DELTA

7074.551

591T

SYSTEM XFR OR EQUAL)

•				·	•		•	•	
PUMP SCHEDULE									
TAG	LOCATION	SERVES	TYPE	FLOW (GPM)	HEAD (FT H2O)	POWER TYPE	MOTOR POWER	BASIS OF DESIGN	NOTES
P-1	MECH / ELEC ROOM	DOMESTIC HOT WATER RECIRC.	CENTRIFUGAL CIRCULATOR, BRASS WETTED COMPONENTS	4	10	120/1/60	1/12	BELL AND GOSSETT NBF-10S/LW	UNIT STARTED FROM PIPE-STRAP TYPE LINE VOLTAGE AQUASTAT, SET TO STOP AT 130F WITH A 20F DIFFERENTIAL

TWO HANDLES

W/ SIDE-SPRAY

DUAL FAUCETS,

TWO-HANDLE. 8"

GOOSENECK

HARDWARED,

ELECTRONIC

SENSOR.

HARDWARED

ELECTRONIC

SENSOR.

FAUCET WITH IR HARDWIRED

FAUCET WITH IR

22DB.6332284S.0 | GOOSENECK SPOUT |

75

LBT8607

AQUALYN

0476028.020

DECLYN

5 RADON VENT PIT DETAIL

Architecture + Engineering + Project Management

TIE-IN RECIRCULATION PUMP TO

THE DCW SUPPLY -/

4 \ DOMESTIC WATER TIE-IN DETAIL


INSTALL CHECK VALVE ON

DCW SUPPLY, SIZE TO MATCH

EXISTING LINE. COORDINATE

LOCATION AND SIZE ON-SITE.

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'IPEX XFR' PIPE OR EQUAL

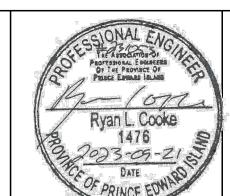— CONCRETE BLOCKS BY GC

Rural Municipality of Kinkora

Kinkora Community Hall Expansion

Plumbing Plans, Details and Schedules

ate: 2023-09-21 Issued for Tender 2023-09-21 Drn By: N.L.V., E.I.T. Chk By: R.L.C., P.Eng. Project Number: 231053 rawing Number

M100

COUNTER MOUNT DROP-IN SINK, P-TRAP, UNDER-COUNTER

SHUTOFFS WITH ESCUTCHEONS, 2 GPM FLOW LIMITING

CARTRIDGE.

COUNTER MOUNT DROP-IN SINK, P-TRAP, UNDER-COUNTER

SHUTOFFS WITH ESCUTCHEONS, 2 GPM FLOW LIMITING

CARTRIDGE. PROVIDE TWO (2) FAUCET TRIMS, CENTERED

BETWEEN TWO BASINS.

PROVIDE OFFSET DWV PLUMBING WITH INSULATION KIT AND


SHROUD, PROVIDE DHW TEMPERING TO 105F WITHIN WALL

CONCEALED ACCESS HATCH, 0.5 GPM LIMIT CARTRIDGE, SHUT-OFFS, ESCUTCHEONS, CONCEALED WALL CARRIER.

AUTOMATIC FAUCET WITH HARDWIRED TRANSFORMER, PROVIDE

CONCEALED CONTROL VALVE

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EA GOOSENECK /

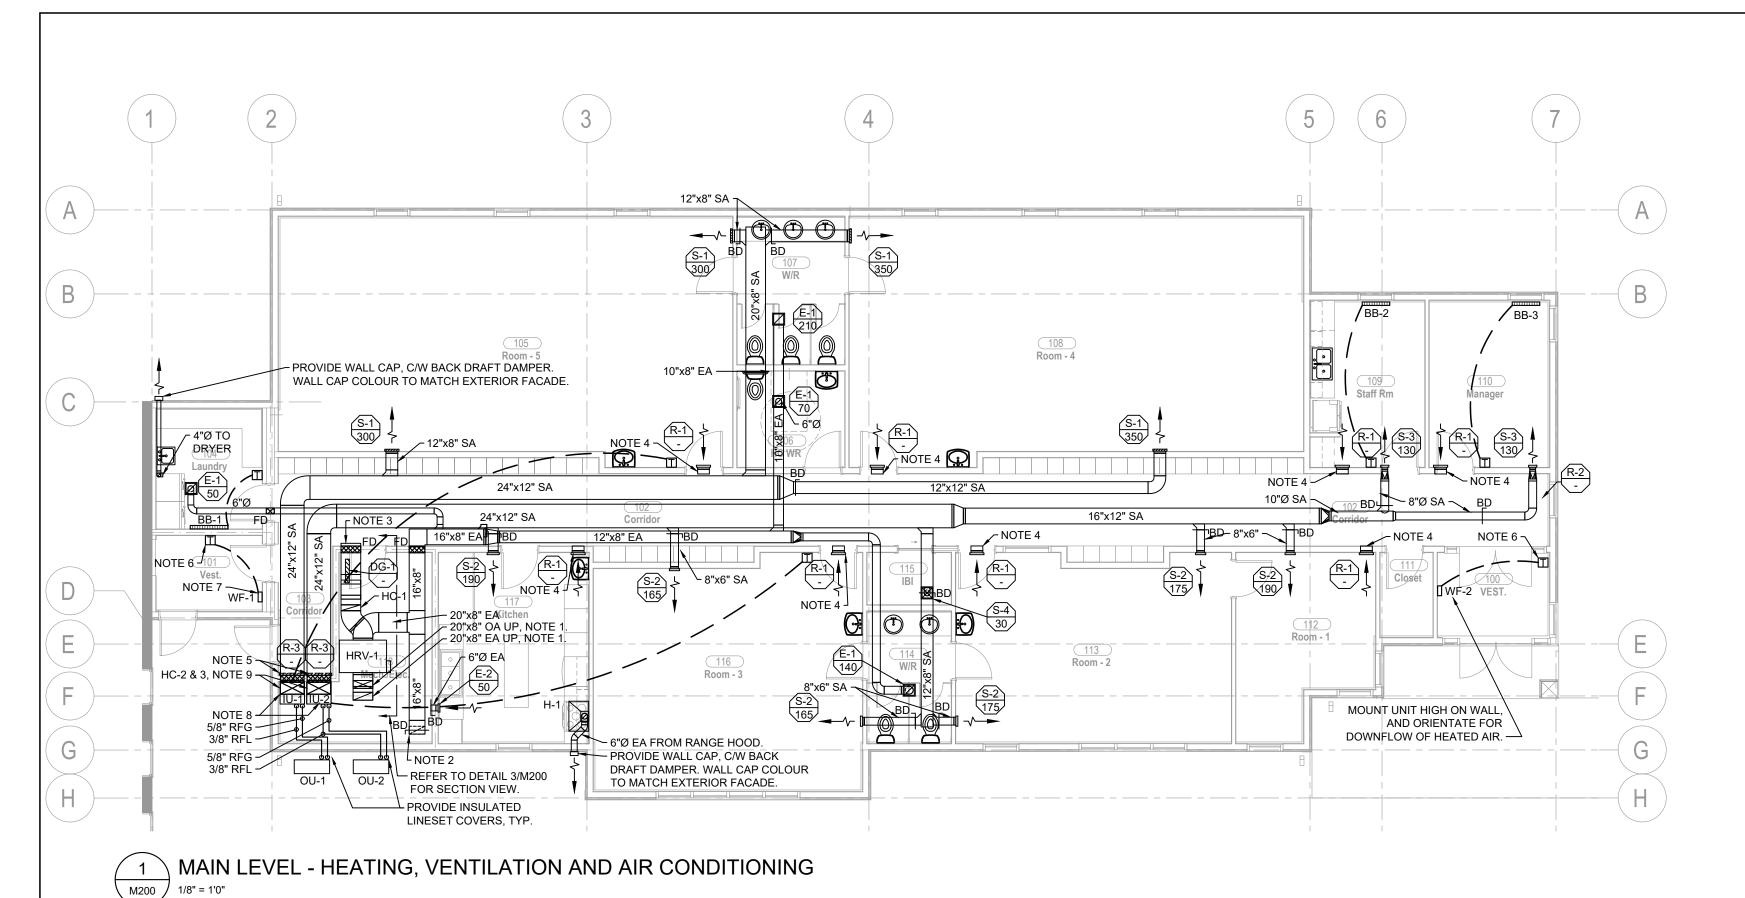20"x8" EA

20"x8" OA

LHRV-1 TO BE SUPPORTED BY THREADED ROD, AND UNISTRUT HANGERS (OR EQUAL) SUITABLE TO SUPPORT WEIGHT

OF UNIT. FASTEN SUPPORT RODS TO

ROOF TRUSS STRUCTURE, PROVIDING ADDITIONAL WOOD FRAMING MEMBERS WITHIN ATTIC SPACE AS NEEDED TO FACILITATE THE INSTALLATION.

LINE OF CEILING.

HRV-1

-24"x24" RA PLENUM FROM

FIRE DAMPER AT LINE OF WALL.

-R-3, LOW WALL RETURN GRILLE, LOCATED ON

R-3 GRILLE, INTO IU-2.

CORRIDOR.

20"x8" EA, UP INTO ATTIC SPACE.

ATTIC SPACE.

HC-3-

20"x8" OA, UP INTO-

24"x12" SA THROUGH WALL, PROVIDE FIRE DAMPER AT LINE OF

IU-1 AND HC-2 ARE TO-√ BE INSTALLED IN

SIMILAR FASHION AS

IU-2/HC-3. UNITS ARE

TO BE SUPPORTED IN

MECH / ELEC ROOM 118 SECTION VIEW

ACCORDANCE WITH

MANUFACTURER RECOMMENDATIONS.

UP THRU ROOF TO GOOSENECK. ∠ 20"x10" EA (TOP) AND 20"x10" OA (BФTTOM) ROUTE THROUGH TRUSS SPACE, PROVIDÉ OFFSETS AS REQUIRED. D 20"x10" EA AND 20"x10" OA UP FROM MECH ROOM BELOW.

HVAC NOTES

- 1. DUCT UP THROUGH CEILING INTO ATTIC SPACE ABOVE, REFER TO DETAIL 2/M300 FOR CONTINUATION. PROVIDE STATIC FIRE DAMPER AT LINE OF CEILING.
- 2. PROVIDE 8"X24" OPEN EA INLET OFF OF VERTICAL SECTION OF 20"x10" EA DUCT. PROVIDE OPPOSED BLADE BALANCE DAMPER, TRIM TO PROVIDE DUCTED EXHAUST FLOWS AS
- INDICATED. PROVIDE HARDWARE CLOTH OVER OPENING. 3. 20"x10" FRESH AIR DUCT FROM HRV-1 TO DISCHARGE IN

CEILING SPACE.

- 4. PROVIDE SIDEWALL GRILLE AND OPENING INTO CEILING
- 5. 24" x 24" LOW WALL RETURN GRILLE TO INDOOR UNIT RETURN CONNECTION. PROVIDE STATIC 1.5HR FIRE DAMPER AT LINE OF WALL.
- 6. BASEBOARD HEATER TO BE PROVIDED WITH RELAY CONTROL, THERMOSTAT TO BE SUPPLIED WITH RANGE-STOP ACCESSORY LIMITING THE HEATING SETPOINT TO 15°C.
- 7. HEATER TO BE RECESSED WITHIN DRYWALL SURROUNDING FRAME TO PRESERVE FIRE RATING OF WALL. MOUNT WALL FAN HEATER HIGH ON WALL AND ORIENTATE HEATER FOR DOWNFLOW OF HEATED AIR.
- 8. THERMOSTAT FIRST STAGING HEATING TO ENABLE HEAT PUMP, SECOND STAGE HEATING CALL TO ENABLE DUCTED HEATING COIL. ALLOW DUCTED HEATING COIL OPERATION DURING HEAT PUMP DEFROST SEQUENCE TO ALLOW FOR CONTINUOUS HEATING.
- 9. DUCTED HEATING COILS, HC-2 & HC-3, ARE TO BE INSTALLED IN VERTICAL 24"X12" SUPPLY AIR DUCT ABOVE IU-1 & 2, RESPECTIVELY. REFER TO DETAIL 3/M200 FOR

VENTILATION SYMBOL LEGEND

SUPPLY AIR DIFFUSER

RETURN AIR GRILLE

90-DEGREE CORNER WITH

FIRE DAMPER (DAMPER WITH SHUTTER AND FUSIBLE LINK)

> SQUARE TO ROUND TRANSITION ADAPTOR

TURNING VANES

BALANCE DAMPER


DIFFUSER ID TAG. S-2: SUPPLY DIFFUSER TYPE 2 BALANCED TO 50 CFM

ACRONYMS: EA - EXHAUST OA - OUTDOOR AIR RA - RETURN AIR SA - SUPPLY AIR - BALANCE DAMPER FD - FIRE DAMPER HRV - HEAT RECOVERY VENTILATOR


IU - INDOOR UNIT

OU - OUTDOOR UNIT


2 ATTIC SPACE - VENTILATION

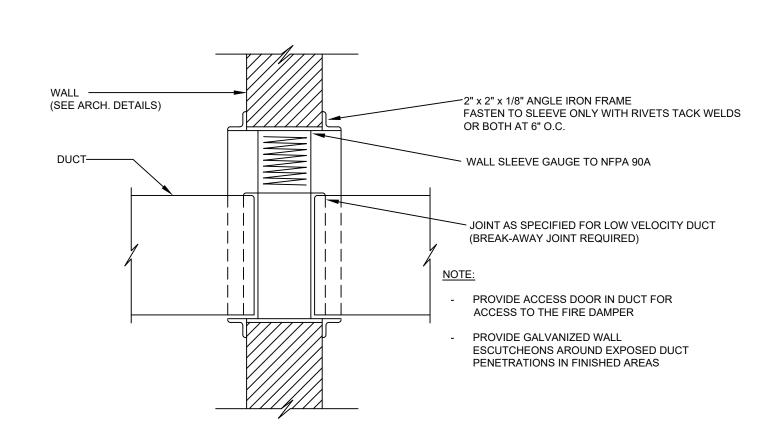



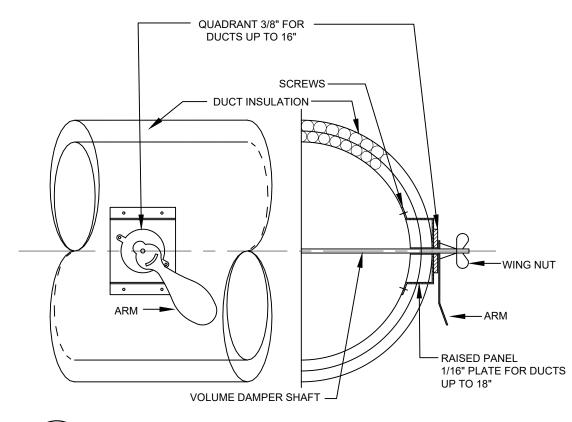


6 BRANCH DUCT BALANCE DAMPER

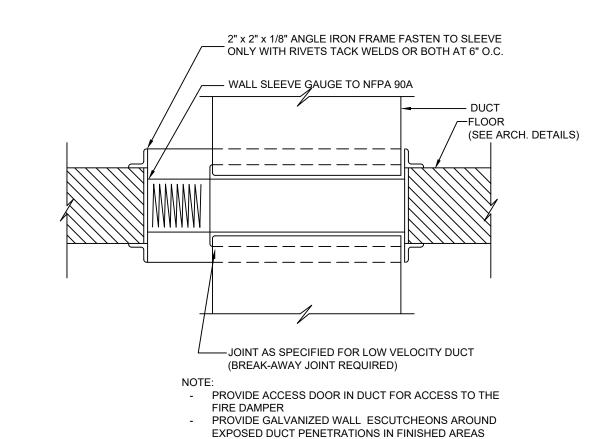

 $^{\prime}$ $^{\circ}$ $^{\circ}$ FIRE DAMPER IN RATED FLOOR/CEILING

M200 NTS

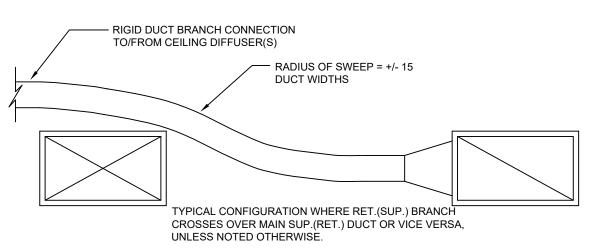


\ DUCT BRANCHES AT CROSSOVERS M200 NTS

Architecture + Engineering + Project Management

3 MECH 1/2" = 1'0"

Suite 201, 85 Fitzroy Street Charlottetown, PEI, Canada, C1A 1R6 Phone (902) 368-2300 www.colesassociates.com

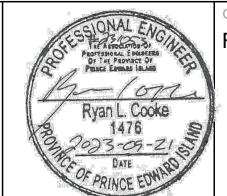

OA INTAKE GOOSENECK

REFER TO DETAIL 1/M201 FOR CONSTRUCTION DETAILS OF GOOSENECK INTAKES/EXHAUSTS AND REQUIRED CLEARANCES TO ROOF SURFACE.

-APPROXIMATE OUTLINE OF TRUSS AND

FIRE DAMPER

20"x8" SA

ATTIC SPACE. COORDINATE ON-SITE WITH


Rural Municipality of Kinkora

Kinkora Community Hall Expansion


Heating, Ventilation and Air Conditioning Plans

No.	Description	Date	Date: 2023-09-21	Revision
1	Issued for Tender	2023-09-21	Drn By: N.L.V., E.I.T.	
			Chk By: R.L.C., P.Eng.	
			Project Number:	
			231053	
			Drawing Number:	
			M200	


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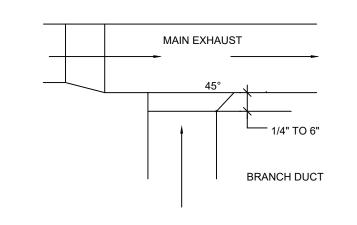


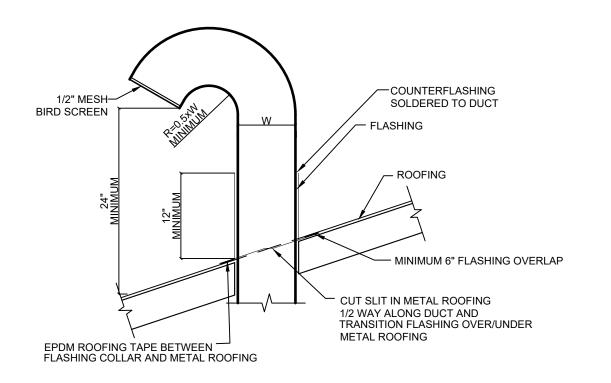

BRANCH DUCT TAKEOFF CONFIGURATIONS
NTS

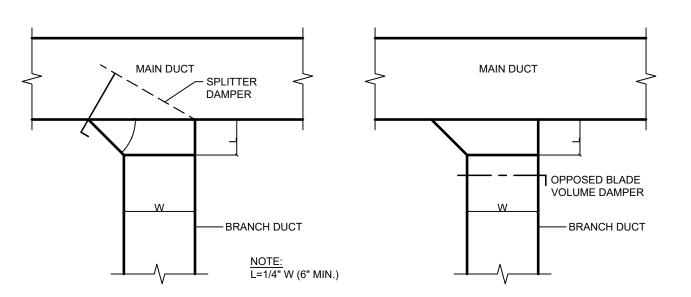




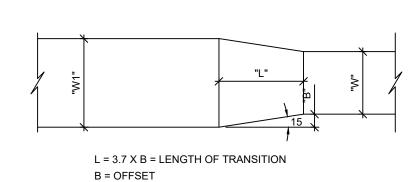


CONVERGENT DUCTING


NTS

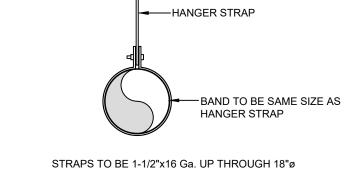



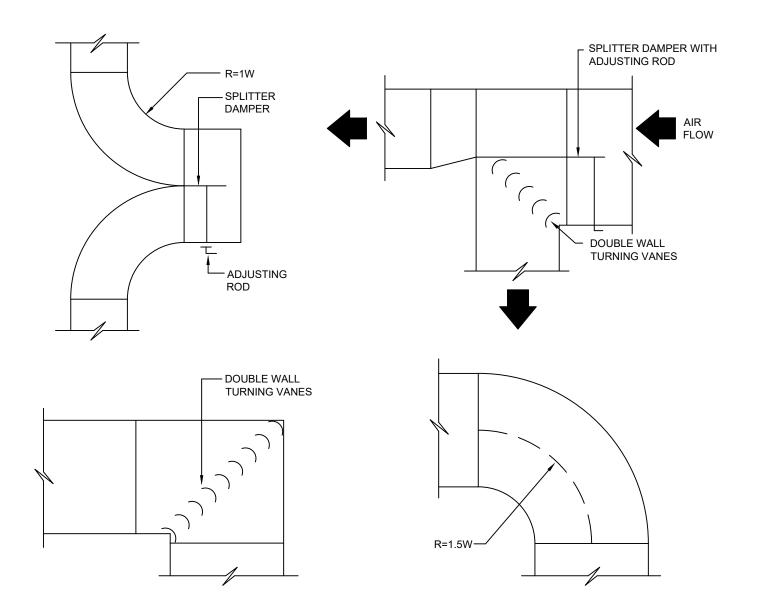



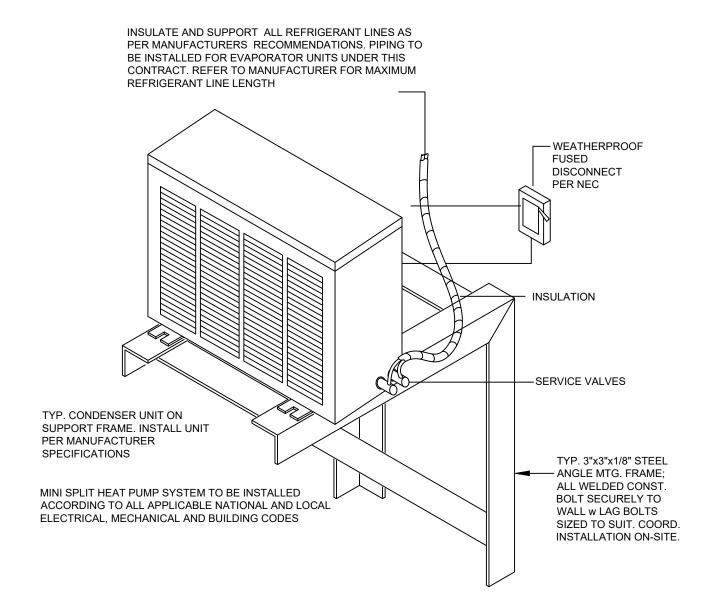


7 HEAT PUMP OUTDOOR UNIT INSTALLATION DETAIL NTS

									5			–					
Ι				Т			E.S.P.	1		: HOOI) SCHED	JLE 					
TAG		LOCATIO	ON AIRFLOW			(CFM)	(IN.WG.)						BASIS OF DESIGN				
H-1		KITCHEN	1		250	250 1.0 120/1/60 2.6 BROAN BWP1364SS								AN BWP1364SS			
									GRILLE AND	D DIFF	USER SC	HEDULE					
TAG		TYPE			MANUFAC	CTURER MODEL SIZE (IN THROW MATERIAL OF									NOTES		
S-1	SIDEWALL DOL	IRI E DEFI	ECTION G				GSA2	x IN) 12" x 8"	19' - 21' STEEL			DN			0° DEELECTI	ION, DRYWALL MOUNT.	
S-2				ECTION GRILLE AIRVECT ECTION GRILLE AIRVECT			GSA2	8" x 6"	14' - 18'		STEEL					ION, DRYWALL MOUNT.	
S-3	SIDEWALL DOL	JBLE DEFL	LECTION GRILLE AIRVEC			TOR				:	STEEL				0° DEFLECTI	ON, DRYWALL MOUNT.	
S-4	4-WAY	CEILING DIFFUSER			AIRVEC	TOR	DF3I	12" x 12"	N/A	;	STEEL					CEILING TILE MOUNT.	
E-1	EGG	CRATE G	RILLE		AIRVEC	TOR	ER	12" x 12"	N/A	AL	UMINUM	ACC	DUSTIC CE			EGRATED PLENUM AND OPPOSED BLADE BALANC PERATED DAMPER ACTUATION.	
E-2	EGG	CRATE G	RILLE		AIRVEC	TOR	ER	6" x 6"	N/A	AL	UMINUM	SI	DEWALL D		,	GRATED PLENUM AND OPPOSED BLADE BALANCE PERATED DAMPER ACTUATION.	
R-1	EGG	CRATE G	RILLE		AIRVEC	TOR	ER	12" x 12"	N/A	AL	UMINUM				SIDEWAL	L DRYWALL MOUNT.	
R-2		CRATE G			AIRVEC	_	ER	48" x 24"	N/A		UMINUM					CEILING TILE MOUNT.	
R-3			RN GRILLE	ICIDI E	AIRVEC	TOR	GSA40	24" x 24"	N/A	;	STEEL					GRILLE, FIXED 45° BLADES HORIZONTAL BLADES. R DOOR THICKNESS, PARALLEL BLADE DAMPER TY	
DG-1	FIRE RATED DO	LINK	E WITH FU	JSIBLE	NAIL)R	61DG-FR	24" x 24"	N/A	;	STEEL					FUSIBLE LINK, FIRE RATED STEEL CONSTRUCTION	
						. 1			GY RECOVI		ENTILATO					1	
TAG	LOCATION	AIRFLOV	SIDE V ESP	UNIT	UNIT I	POWER			FFECTIVEN	NESS % EFF	LENG		ENSIONS 'H HEIGH'	TWEIGHT	BASIS OF	NOTES	
		(CFM)	(IN.WG.		MOCP	TYPE	OA (°F)	RA (°F)		(TOTAI				(KG)	DESIGN		
HRV-1	MECH/ELEC. ROOM	1100	0.75	14.25	15	20/1/60	-7.6	71.6	34.4	53%	36	52	22	109	FANTECH SHR1200	GRAVITY BACKDRAFT DAMPERS ON BOTH AIRSTREAMS, TIMER DEFROST CONTROL, FACTO MOUNTED DISCONNECT SWITCH, MERV 8 FILTER BOTH AIRSTREAMS.	
			l						LECTRIC H	EATING	G COIL SO	CHEDULE					
l lie						TING		AIRSIDE		_	JCT DIME		POWER				
TAG	LOCATIO	N	MAKE /	MODEL		CITY (kW)					WIDTH (IN) HEIG					NOTES	
HC-1	HRV-1 SUPPLY	AIR DUCT	STELPR	O SDHF	10.7		1100	34.4	65.0	:	20"	10"	240/1/60			ROLLER MAINTAINING 60°F SUPPLY TEMPERATURI MPERATURE SENSOR, AIR-PROVING SWITCH.	
HC-2	IU-1 SUPPLY A	IR DUCT	SUPPLIED	WITH IU-	J-1 15		1300	300 65 10		24"		12"	240/1/60	SINGLE-S	E-STAGE LOW VOLTAGE CONTROL, SCR DISCHARGE AIR TEMPER. ONTROLLER, AIR-PROVING SWITCH. TO BE WIRIED TO SECOND STA HEATING CONTACT FROM IU-1 THERMOSTAT.		
HC-3	IU-2 SUPPLY A	IR DUCT		ED WITH I-2	15 130			65	65 101.3 24" 12"				240/1/60		SINGLE-STAGE LOW VOLTAGE CONTROL, SCR DISCHARGE AIR TEMPERATUR CONTROLLER, AIR-PROVING SWITCH. TO BE WIRIED TO SECOND STAGE HEATING CONTACT FROM IU-1 THERMOSTAT.		
								SPLIT SY	STEM AIR H	IANDLE	ER HEAT	PUMP SCH	HEDULE				
						HEATIN	NG CAP.	COOLING POWER		-R							
TAG	TYPE		LOCATION		REFRIG. (MBH)			CAP. (MBH			FLA	MOCP	BASIS O	F DESIGN		NOTES	
OU-1	HEAT PU CONDENSING		OUTD	OORS	R410A	5	7.5	57.0	230/1/	60	29.1	35		NKIN OTBVJUA	SIDE SNOW	N HEATER, LOW-AMBIENT WIND BAFFLE, KPS063A4 V HOOD, KPS067A42 REAR SNOW HOOD, PROVIDE FUNT STAND AND SNOW/ICE SHROUD OVER TOP OF UNIT, ABLE CANVAS OR EQUAL.	
IU-1	INDOOR AIR H. UNIT	ANDLER	MECH/EL	EC ROOM	1 R410A	6	60	60	230/1/	60	8.6	15.0	15.0 DAIKIN FXTQ60TAVJUA		C/W HARD-WIR	C/W HARD-WIRED THERMOSTAT BRC1E73 OR EQUAL, LOW VOLTAG	
								SPLIT SY	STEM AIR H	IANDLE	R HEAT	PUMP SCH	HEDULE				
TAG	TYPE		LOCA	TION	REFRIG		IG CAP. C	OOLING CA (MBH)	POWE		FLA	MOCP				NOTES	
OU-2	HEAT PU CONDENSING		OUTD	OORS	R410A	57	7.5	57.0	230/1/	60	29.1	35		NKIN OTBVJUA	SIDE SNOW	IN HEATER, LOW-AMBIENT WIND BAFFLE, KPS063A4 V HOOD, KPS067A42 REAR SNOW HOOD, PROVIDE BUNT STAND AND SNOW/ICE SHROUD OVER TOP OF UNIT, ABLE CANVAS OR EQUAL.	
IU-2	INDOOR AIR HANDLER MECH/ELEC ROOM		EC ROOM	R410A	6	0	60	230/1/	60	0.3	15.0		NKIN OTAVJUA	C/W HARD-WIR	ED THERMOSTAT BRC1E73 OR EQUAL, LOW VOLTA RELAY.		
<u>'</u>						-	•		ELECTRIC	C HEAT	TER SCHE	DULE					
TAG	TYPE			LOCATIO	N	OUTP	UT (W)	ENGTH (IN)	HEIGHT (IN)		PTH (IN)	POWER TYPE	BASIS O	F DESIGN		NOTES	
BB-1	ELECTRIC BAS	EBOARD	LAUN	IDRY ROC	OM 104	75	50	38"	6"	2	2-1/2"	240/1/60		O BRAVA	C/W	WALL MOUNT LINE VOLTAGE THERMOSTAT	
BB-2	ELECTRIC BAS	EBOARD	STA	AFF ROOM	И 109	50	00	28"	6"	2	2-1/2"	240/1/60	STELPR	O BRAVA 0502	C/W	WALL MOUNT LINE VOLTAGE THERMOSTAT	
BB-3	ELECTRIC BAS	EBOARD	MANA	GER OFF	ICE 110	50	00	28"	6"	2	2-1/2"	240/1/60	STELPR	O BRAVA	C/W	WALL MOUNT LINE VOLTAGE THERMOSTAT	
				MANAGER OFFICE 110 50 VESTIBULE 101 50								80502 80502 80502 80502 80502		0,000,000,000	TAGE CONTROL RELAY, PROVIDE 15C RANGE STO		

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Rural Municipality of Kinkora

Kinkora Community Hall Expansion

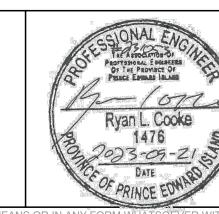WALL FAN HEATER

VESTIBULE 100

500

8-1/2"

Heating, Ventilation and Air Conditioning Details and Equipment Schedules

17"

3-1/4"

Date: 2023-09-21 Issued for Tender 2023-09-21 Drn By: N.L.V., E.I.T. Chk By: R.L.C., P.Eng. Project Number: 231053 Prawing Number


M301


240/1/60 STELPRO PULSAIR C/W LOW-VOLTAGE CONTROL RELAY. PROVIDE 15C RANGE STOP


ON THERMOSTAT. INSTALL FOR DOWN FLOW, HIGH ON WALL.

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	LIGHTING LEGEND
#	LUMINAIRE, CEILING MOUNTED # - INDICATES TYPE IN LUMINAIRE SCHEDULE
#	LUMINAIRE, SURFACE MOUNTED # - INDICATES TYPE IN LUMINAIRE SCHEDULE SHADED - INDICATES CONNECTED TO UNSWITCHED SIDE OF CIRCUIT (NIGHT LIGHTING)
#	LUMINAIRE, CEILING MOUNTED # - INDICATES TYPE IN LUMINAIRE SCHEDULE
#	LUMINAIRE, CEILING MOUNTED # - INDICATES TYPE IN LUMINAIRE SCHEDULE
#	LUMINAIRE, CEILING MOUNTED # - INDICATES TYPE IN LUMINAIRE SCHEDULE
#	LUMINAIRE, WALL MOUNTED # - INDICATES TYPE IN LUMINAIRE SCHEDULE
#	LUMINAIRE, CEILING MOUNTED # - INDICATES TYPE IN LUMINAIRE SCHEDULE
⊗ †	EXIT SIGN; CEILING MOUNTED SHADING - INDICATES NUMBER AND LOCATION OF FACES ARROW - INDICATES DIRECTION OF EXIT
H⊗∱	EXIT SIGN; WALL MOUNTED SHADING - INDICATES NUMBER AND LOCATION OF FACES ARROW - INDICATES DIRECTION OF EXIT
	DUAL HEAD EMERGENCY LIGHTING UNIT
	REMOTE DUAL HEAD EMERGENCY LIGHTING UNIT
	REMOTE SINGLE HEAD EMERGENCY LIGHTING UNIT
\$#	SINGLE POLE SWITCH # - INDICATES SUBSCRIPT
SWITCH SUB	SCRIPTS
3 -	THREE-WAY SWITCH
L -	0-10VDC LINE VOLTAGE DIMMER SWITCH
a -	LUMINAIRE SWITCHING
P	PIR OCCUPANCY SENSOR WALL SWITCH
$\langle \hat{D} \rangle$	DUAL TECHNOLOGY 360° OCCUPANCY SENSOR, CEILING MOUNTED
PC	PHOTOCELL
TC	TIME CLOCK
LC	LIGHTING CONTACTOR

→ SINGLE RECEPTACLE → DUPLEX RECEPTACLE ⊕ QUADRUPLEX RECEPTACLE RECEPTACLE SUB SCRIPTS 20 - CSA TYPE L5-20R (DATA RACK) 30 - TYPE 14-30R 50 - CSA TYPE 14-50R G - GFCI RECEPTACLE WP - RECEPTACLE GFCI C/W WEATHER PROOF WHILE IN-USE COVER SINGLE PHASE MOTOR
QUADRUPLEX RECEPTACLE RECEPTACLE SUB SCRIPTS 20 - CSA TYPE L5-20R (DATA RACK) 30 - TYPE 14-30R 50 - CSA TYPE 14-50R G - GFCI RECEPTACLE WP - RECEPTACLE GFCI C/W WEATHER PROOF WHILE IN-USE COVER
RECEPTACLE SUB SCRIPTS 20 - CSA TYPE L5-20R (DATA RACK) 30 - TYPE 14-30R 50 - CSA TYPE 14-50R G - GFCI RECEPTACLE WP - RECEPTACLE GFCI C/W WEATHER PROOF WHILE IN-USE COVER
20 - CSA TYPE L5-20R (DATA RACK) 30 - TYPE 14-30R 50 - CSA TYPE 14-50R G - GFCI RECEPTACLE WP - RECEPTACLE GFCI C/W WEATHER PROOF WHILE IN-USE COVER
30 - TYPE 14-30R 50 - CSA TYPE 14-50R G - GFCI RECEPTACLE WP - RECEPTACLE GFCI C/W WEATHER PROOF WHILE IN-USE COVER
50 - CSA TYPE 14-50R G - GFCI RECEPTACLE WP - RECEPTACLE GFCI C/W WEATHER PROOF WHILE IN-USE COVER
G - GFCI RECEPTACLE WP - RECEPTACLE GFCI C/W WEATHER PROOF WHILE IN-USE COVER
WP - RECEPTACLE GFCI C/W WEATHER PROOF WHILE IN-USE COVER
WP - WHILE IN-USE COVER
SINGLE PHASE MOTOR
FUSED DISCONNECT SWITCH XX - INDICATES SWITCH RATING F-XX F-XX - INDICATES FUSE SIZE
UNFUSED DISCONNECT SWITCH XX - INDICATES SWITCH RATING
DIRECT CONNECTION
MANUAL MOTOR SWITCH
'DPA' ELECTRICAL PANEL, SURFACE MOUNTED 'DPA' - INDICATES PANEL DESIGNATION
'A1' ELECTRICAL PANEL, RECESSED MOUNTED 'A1' - INDICATES PANEL DESIGNATION
WALL FAN HEATER, SUPPLIED AND INSTALLED BY DIV. 23 AND WIRED BY DIV. 26
BB-1 ELECTRIC BASEBOARD HEATER, SUPPLIED AND INSTALLED BY DIV. 23 AND WIRED BY DIV. 26
(P) UTILITY SERVICE POLE
UTILITY METER
LINE VOLTAGE THERMOSTAT, SUPPLIED AND INSTALLED BY DIV. 23 AND WIRED BY DIV. 26.

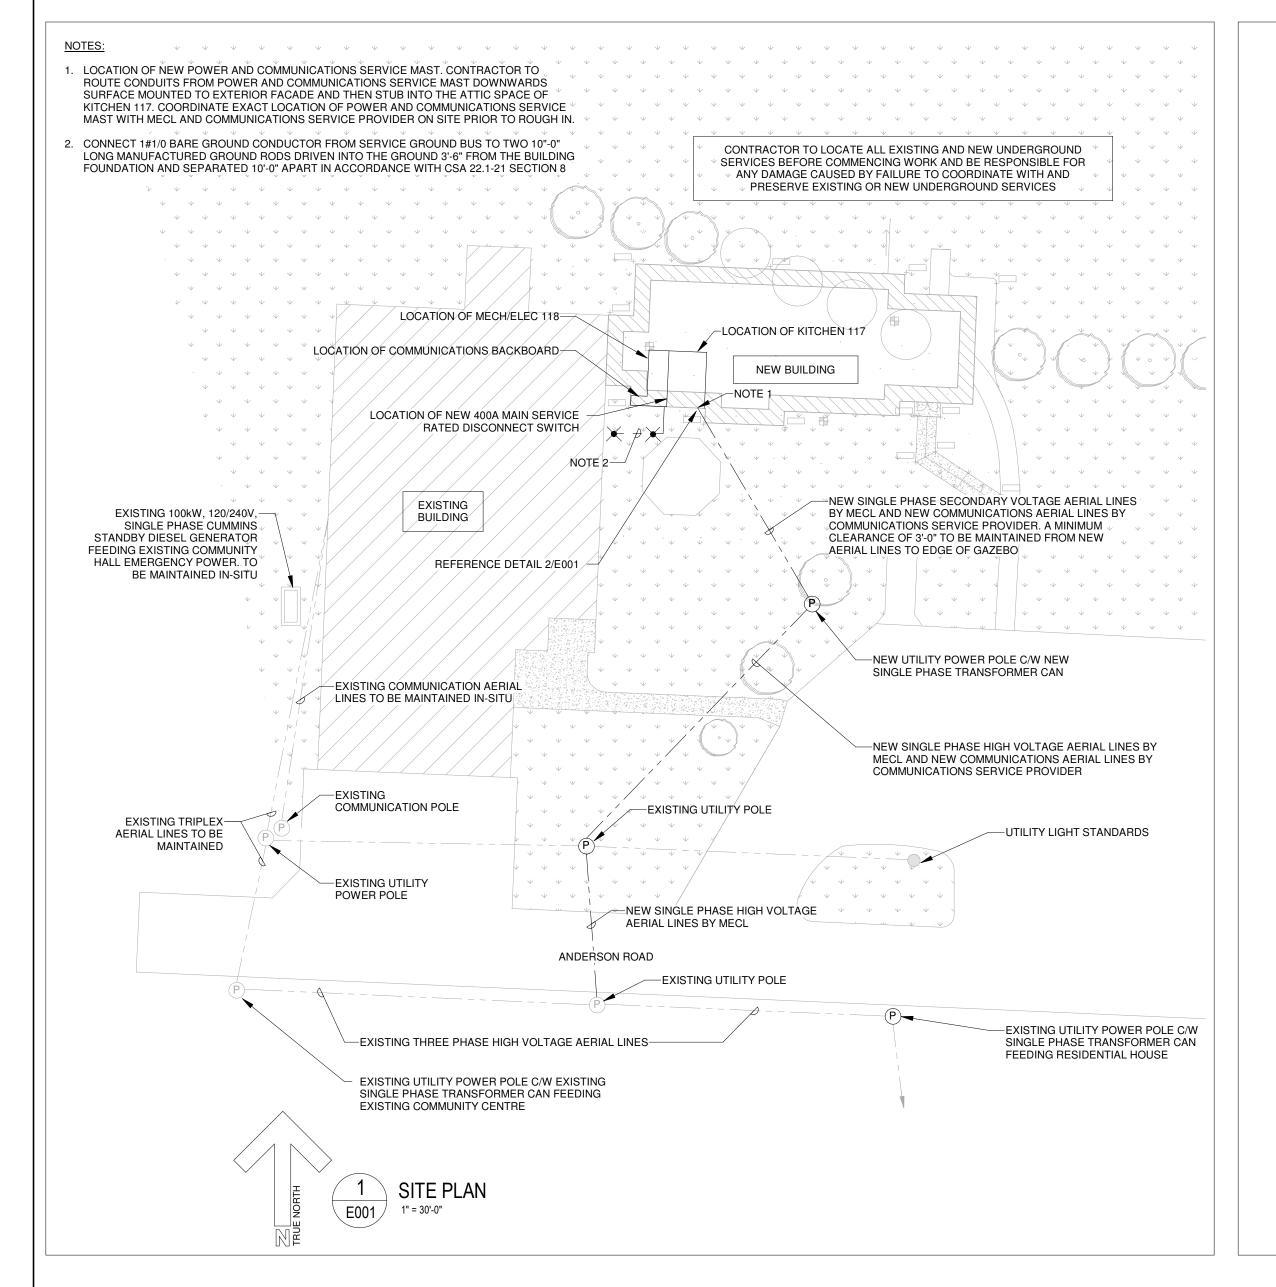▶ _{1,2}	DATA AND TELEPHONE OUTLET FIRST NUMBER INDICATES QUANTITY OF RJ45 MODULE FOR TELEPHONE, SECOND NUMBER INDICATES QUANTITY OF RJ45 MODULES FOR DATA. TELEPHONE AND DATA TO SHARE COMMON FACEPLATE.						
DR	WALL MOUNTED COMMUNICATIONS DATA RACK						
	COMMUNICATIONS BACKBOARD						
INTRUSION & ACCESS CONTROL LEGEND							
•	POWER ASSISTED DOOR PUSH BUTTON, SUPPLIED AND INSTALLED BY DIV. 8, WIRED BY DIV. 28.						
DO	POWER ASSISTED DOOR OPENER,						

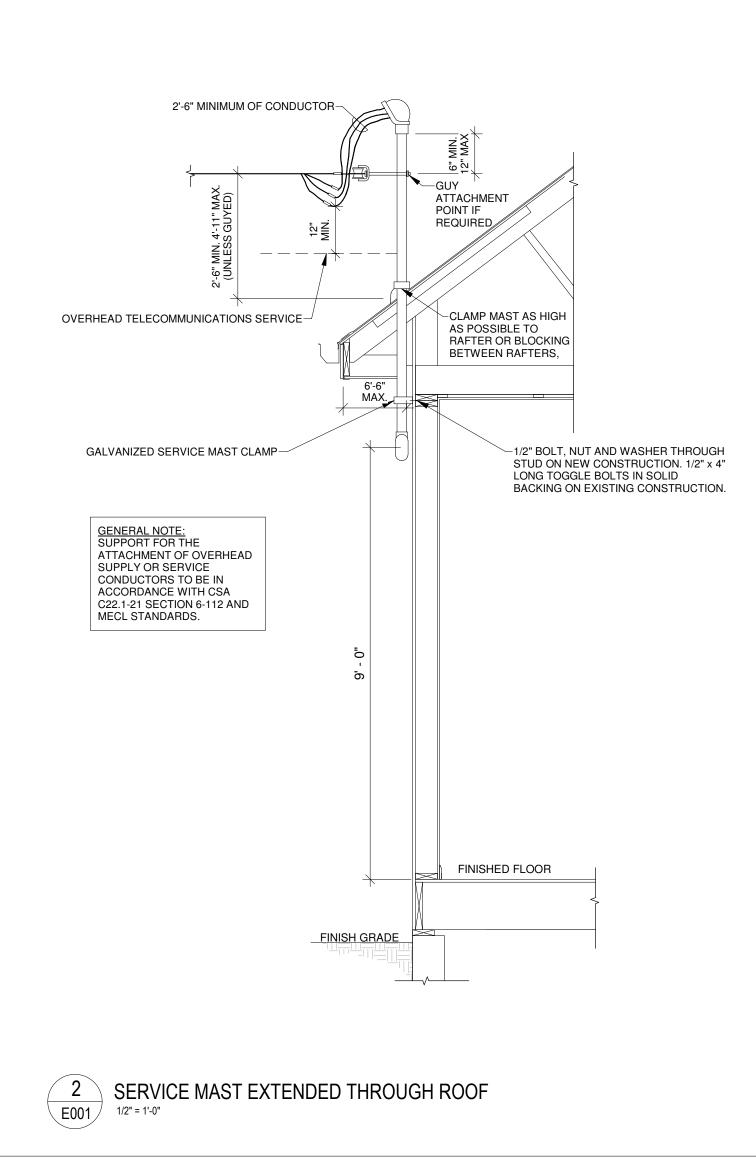SYSTEMS LEGEND

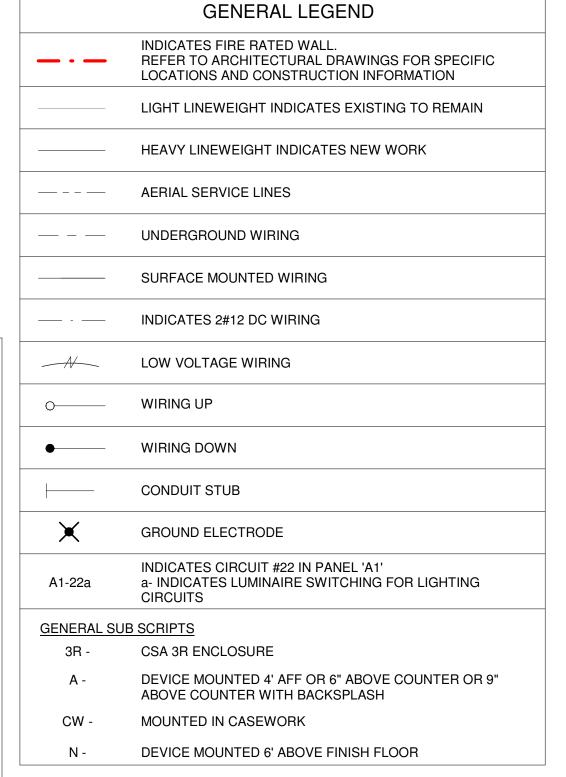SUPPLIED AND INSTALLED BY OWNER.

DATA OUTLET-MOUNTED IN ACCESSIBLE CEILING SPACE

ADJACENT TO WIRELESS ROUTER. WIRELESS ROUTER

		POWER ASSISTED DOOR PUSH BUTTON, SUPPLIED AND INSTALLED BY DIV. 8, WIRED BY DIV. 28.
_	DO	POWER ASSISTED DOOR OPENER, SUPPLIED AND INSTALLED BY DIV. 8, WIRED BY DIV. 28.
_	P	ACCESS CONTROL PROXIMITY CARD READER
	ES	ELECTRIC STRIKE, SUPPLIED AND INSTALLED BY DIV. 8, WIRED BY DIV. 28.
	ACP	ACCESS CONTROL DOOR CONTROL PANEL
		FIRE ALARM LEGEND

	I INC ACANIVI CEGEND								
FAA	FIRE ALARM ANNUNCIATOR PANEL								
FACP	FIRE ALARM CONTROL PANEL								
•	FIRE ALARM SPOT TYPE FIRE DETECTOR # - INDICATES SUBSCRIPT								
DETECTOR SUB SCRIPTS									
M -	MULTISENSOR SMOKE DETECTOR								
RF -	FIXED TYPE THERMAL DETECTOR								
Į	FIRE ALARM COMBINATION HORN STROBE								




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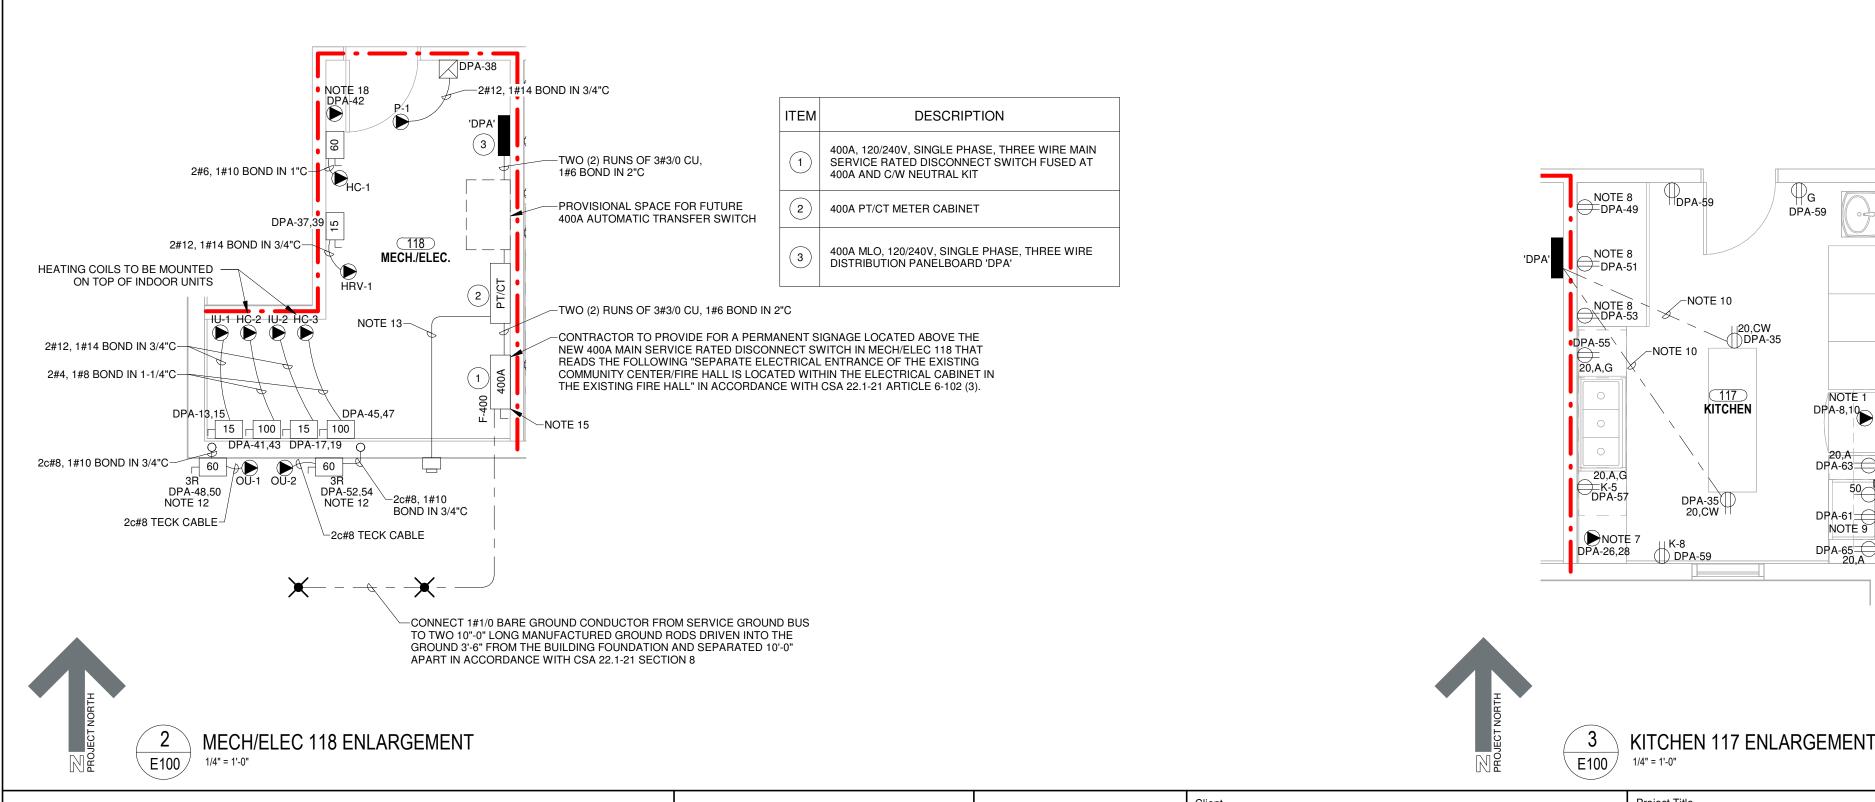



Rural Municipality of Kinkora

Kinkora Community Hall Expansion

Site Plan, Legend & Details



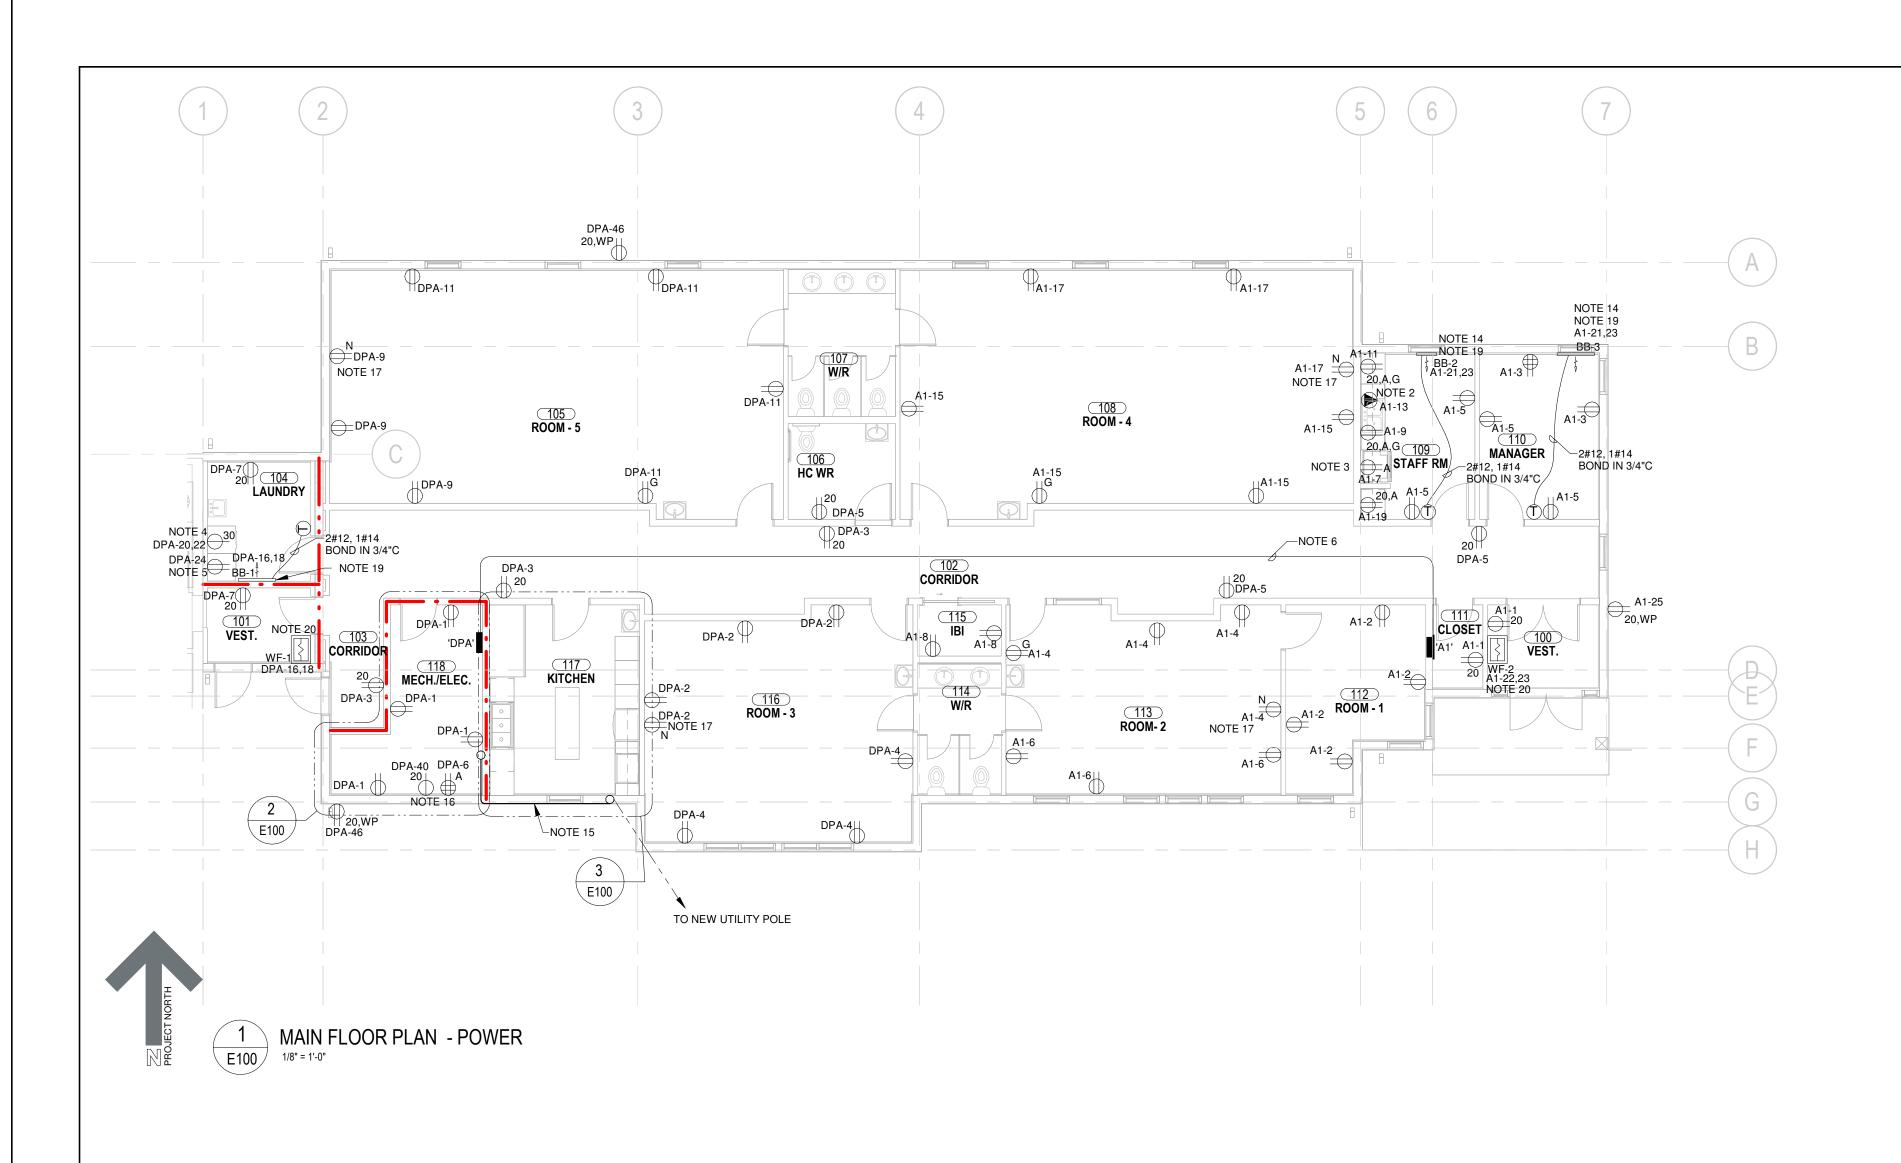

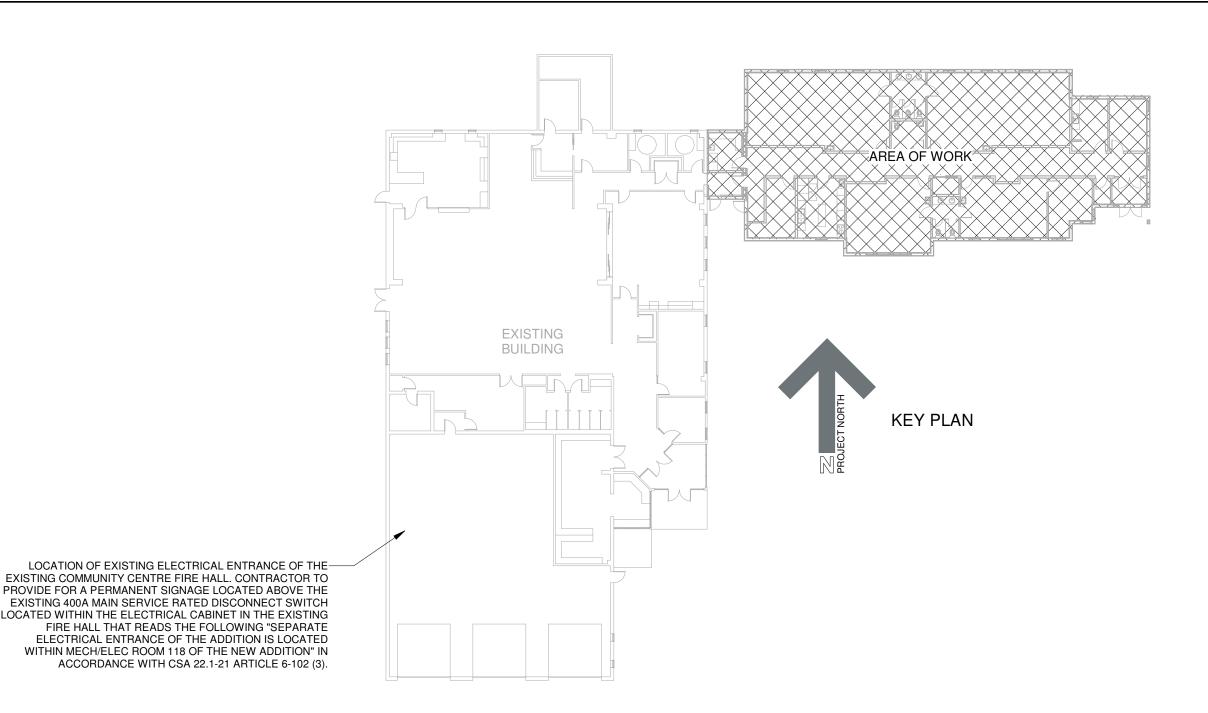


GENERAL NOTES


- 1. GAUGE OF BRANCH CIRCUIT WIRING TO BE SIZED FOR A MAXIMUM VOLTAGE DROP OF 3% IN ACCORDANCE WITH CSA 22.1-21 SECTION 8.
- 2. CONDUIT AND CABLING PENETRATIONS THROUGH FIRE RATED SEPARATIONS ARE TO BE FIRE AND SMOKE SEALED BY GENERAL CONTRACTOR SO THAT THE FIRE RATING OF THE SEPARATION IS MAINTAINED. ACCEPTABLE MANUFACTURER OR APPROVED EQUAL: 3M BRAND FIRE BARRIER. REFER TO ARCHITECTURAL DRAWINGS FOR FIRE RATED ASSEMBLY LOCATIONS.
- 3. EXPOSED ELECTRICAL CONDUIT BOXES AND SUPPORTS IN FINISHED AREAS ARE TO BE PAINTED THE COLOUR OF ADJACENT FINISHED SURFACE. COORDINATE EXACT COLOUR AND ASSOCIATED PAINTING WITH GENERAL CONTRACTOR ON SITE.
- 4. ALL CONTROL WIRING FOR HEATERS AND ASSOCIATED THERMOSTATS TO BE SUPPLIED AND COMPLETED BY OTHERS. ALL POWER WIRING TO BE SUPPLIED AND INSTALLED BY ELECTRICAL CONTRACTOR.
- 5. ALL CSA TYPE 5-15R AND 5-20R RECEPTACLES ARE TO BE TAMPER RESISTANT TYPE EXCEPT WHERE THEY ARE INACCESSIBLE OR MORE THAN 6'-0" AFF IN ACCORDANCE WITH CSA 22.1-21 ARTICLE 26-706.
- 6. REFER TO MECHANICAL AND ELECTRIC HEATING SCHEDULES ON DRAWING E300 FOR ADDITIONAL INFORMATION ON MECHANICAL AND ELECTRIC HEATING SYSTEMS.
- 7. ALL BRANCH CIRCUIT WIRING TO BE ROUTED FROM PANELBOARDS TO ASSOCIATED WIRING DEVICES AND ELECTRICAL EQUIPMENT THROUGH THE ATTIC SPACE AND THEN DOWNWARDS THROUGH INTERIOR OF GYPSUM WALL CAVITY. COORDINATE EXACT ROUTING WITH GENERAL CONTRACTOR ON SITE PRIOR TO ROUGH IN.


- 1. CONTRACTOR TO WIRE OWNER SUPPLIED WALL OVEN WITH 2c#8 AC90 CABLE ROUTED THROUGH THE CEILING SPACE OF KITCHEN 117 AND THEN DOWNWARDS THROUGH INTERIOR OF GYPSUM WALL CAVITY. CONFIRM EXACT POWER REQUIREMENTS AND EXACT LOCATION OF WALL OVEN WITH OWNER
- 2. WIRE OWNER SUPPLIED DISHWASHER WITH 2c#12 AC90 ROUTED THROUGH CEILING SPACE THEN DOWNWARDS THROUGH INTERIOR OF GYPSUM WALL. COORDINATE EXACT POWER REQUIREMENTS AND EXACT LOCATION OF DISHWASHER PRIOR TO ROUGH-IN.
- 3. DUPLEX RECEPTACLE DEDICATED FOR OWNER SUPPLIED REFRIGERATOR. COORDINATE EXACT LOCATION WITH OWNER ON SITE PRIOR TO ROUGH-IN. 4. CSA 14-30R RECEPTACLE DEDICATED FOR DRYER. COORDINATE EXACT LOCATION WITH GENERAL CONTRACTOR AND OWNER ON SITE PRIOR TO ROUGH-IN.
- 5. DUPLEX RECEPTACLE DEDICATED FOR WASHING MACHINE. COORDINATE EXACT LOCATION WITH GENERAL CONTRACTOR AND OWNER ON SITE PRIOR TO
- 6. WIRE PANELBOARD 'A1' LOCATED IN CLOSET 111 WITH 3#6, 1#10 BOND IN 1"C ROUTED THROUGH THE ACCESSIBLE CEILING SPACE OF CORRIDOR 102 TO A 60A/2P CIRCUIT BREAKER OF DISTRIBUTION PANELBOARD 'DPA' LOCATED IN MECH/ELEC 118. COORDINATE EXACT PANELBOARD 'A1' LOCATION AND ROUTING OF CONDUIT ON SITE PRIOR TO ROUGH-IN.
- 7. WIRE OWNER SUPPLIED DISHWASHER WITH 2c#10 AC90 ROUTED THROUGH THE CEILING SPACE AND THEN DOWNWARDS THROUGH INTERIOR OF GYPSUM WALL CAVITY. COORDINATE EXACT POWER REQUIREMENTS AND EXACT LOCATION OF DISHWASHER WITH MECHANICAL CONTRACTOR AND OWNER ON SITE
- 8. DUPLEX RECEPTACLE DEDICATED FOR OWNER SUPPLIED FREEZER/COOLER. COORDINATE EXACT POWER REQUIREMENTS AND EXACT LOCATION OF FREEZER/COOLER WITH OWNER ON SITE PRIOR TO ROUGH-IN.
- 9. DUPLEX RECEPTACLE DEDICATED FOR RANGE HOOD MOUNTED AT 5'-0" AFF. COORDINATE EXACT LOCATION AND MOUNTING HEIGHT OF DUPLEX RECEPTACLE WITH LOCATION OF ELECTRICAL BOX OF RANGE HOOD AND OWNER ON SITE PRIOR TO ROUGH-IN.
- 10. WIRE 20A RECEPTACLE RECESS MOUNTED IN KITCHEN ISLAND WITH 2#12, 1#14 BOND IN 1" PVC CONDUIT ROUTED 12" BELOW CONCRETE SLAB STUBBED WITHIN MILLWORK AND THEN TRANSITION TO 2c#12 AC90 CABLING. COORDINATE EXACT LOCATION AND INSTALLATION WITH GENERAL CONTRACTOR, CONCRETE SLAB INSTALLER AND MILLWORK INSTALLER ON SITE PRIOR TO ROUGH-IN.
- 11. 50A CSA 14-50R RECEPTACLE DEDICATED FOR OWNER SUPPLIED RANGE. COORDINATE EXACT POWER REQUIREMENTS AND LOCATION WITH GENERAL CONTRACTOR AND OWNER ON SITE PRIOR TO ROUGH-IN.
- 12. LOCATE CSA TYPE 3R RATED UNFUSED DISCONNECT SWITCH ADJACENT TO CONDENSING UNIT. ROUTE TECK CABLES TO CSA TYPE 3R UNFUSED DISCONNECT SWITCH AND ADJACENT TO MECHANICAL LINES. ALL CONTROL CABLING BETWEEN INDOOR AND OUTDOOR UNIT TO BE SUPPLIED AND INSTALLED BY DIV. 23. COORDINATE EXACT LOCATION OF CSA TYPE 3R UNFUSED DISCONNECT SWITCH, CONDENSING UNIT AND INTERIOR HEAT PUMP ON SITE PRIOR TO ROUGH-IN. SEAL EXTERIOR PENETRATIONS WITH LOW Voc MASTIC COMPOUND.
- 13. 1.5"EC C/W PULL CORD PENETRATING THROUGH THE EXTERIOR FAÇADE TO UTILITY METER. COORDINATE EXACT LOCATION OF UTILITY METER WITH MECL
- 14. WIRE ELECTRIC BASEBOARD HEATER WITH 2c#12 AC90 CABLING ROUTED HORIZONTALLY UNDERNEATH WINDOW AND THEN UPWARDS THROUGH INTERIOR OF GYPSUM WALL CAVITY. COORDINATE EXACT LOCATION AND CABLE ROUTING WITH MECHANICAL CONTRACTOR ON SITE PRIOR TO ROUGH-IN.
- 15. TWO (2) RUNS OF 3c#3/0 CU IN 4"C ROUTED DOWNWARDS FROM NEW POWER SERVICE MAST AND THEN RUNS HORIZONTALLY AT 9'-0" ABOVE MAIN FINISHED FLOOR LEVEL ON THE EXTERIOR FACADE OF THE BUILDING. CONDUIT IS THEN TO STUB THROUGH THE SIDE WALL INTO THE CEILING SPACE OF MECH/ELEC 118 THROUGH AN LB ELBOW TO WIRE 400A MAIN SERVICE RATED DISCONNECT SWITCH. COORDINATE EXACT CONDUIT ROUTING AND INSTALLATION ON SITE PRIOR TO ROUGH-IN. PROVIDE FOR PAINTING OF EXTERIOR CONDUIT ROUTED ALONG THE EXTERIOR FACADE TO MATCH THE COLOR OF THE
- 16. SUPPLY AND INSTALL 20A L5-20R RECEPTACLE RECESS MOUNTED IN GYPSUM WALL ADJACENT TO WALL MOUNTED DATA RACK. COORDINATE EXACT LOCATION OF RECEPTACLE WITH DATA RACK LAYOUT ON SITE PRIOR TO ROUGH-IN.
- 17. RECEPTACLE TO BE LOCATED IN A 3-GANG RECESS MOUNTED WALL BOX. WIRE RECEPTACLE WITH 2#12, 1#14 BOND IN 3/4"C ROUTED UP THROUGH INTERIOR OF GYPSUM WALL CAVITY INTO THE CEILING SPACE. COORDINATE EXACT LOCATION AND MOUNTING HEIGHT ON SITE PRIOR TO ROUGH-IN.
- 18. WIRE TRAP SEAL PRIMER WITH 2#12, 1#14 BOND IN ¾"C. COORDINATE EXACT LOCATION OF TRAP SEAL PRIMER WITH MECHANICAL CONTRACTOR ON SITE
- 19. WIRE ELECTRIC BASEBOARD HEATER THROUGH LINE VOLTAGE THERMOSTAT WITH 2#12, 1#14 BOND IN ¾"C. ELECTRIC BASEBOARD HEATER AND LINE VOLTAGE THERMOSTAT TO BE SUPPLIED AND INSTALLED BY DIV. 23 AND WIRED BY DIV. 26. COORDINATE EXACT LOCATION WITH MECHANICAL CONTRACTOR ON SITE PRIOR TO ROUGH IN.
- 20. WIRE WALL FAN HEATER WITH 2#12, 1#14 BOND IN 3/4"C ROUTED THROUGH THE ATTIC SPACE AND THEN DOWNWARDS THROUGH INTERIOR OF GYPSUM WALL. WALL FAN HEATER TO BE SUPPLIED AND INSTALLED BY DIV. 23 AND WIRED BY DIV. 26. ALL CONTROLS WIRING TO LOW VOLTAGE THERMOSTAT TO BE COMPLETED BY OTHERS. COORDINATE EXACT LOCATION AND MOUNTING HEIGHT WITH MECHANICAL CONTRACTOR ON SITE PRIOR TO ROUGH IN.


2023-09-21 Main Floor Plan & Enlargements - Power Rural Municipality of Kinkora Kinkora Community Hall Expansion Description 2023-09-21 Drn By: C.L.S., C.E.T. / E.A., E.I.T. Issued for Tender Chk By: E.S.C., P.ENG Suite 201, 85 Fitzroy Street Charlottetown, P.E.I., Canada, C1A 1R6 Project Number: Phone: (902) 368-2300 231053 www.colesassoicates.com

NOTE 9

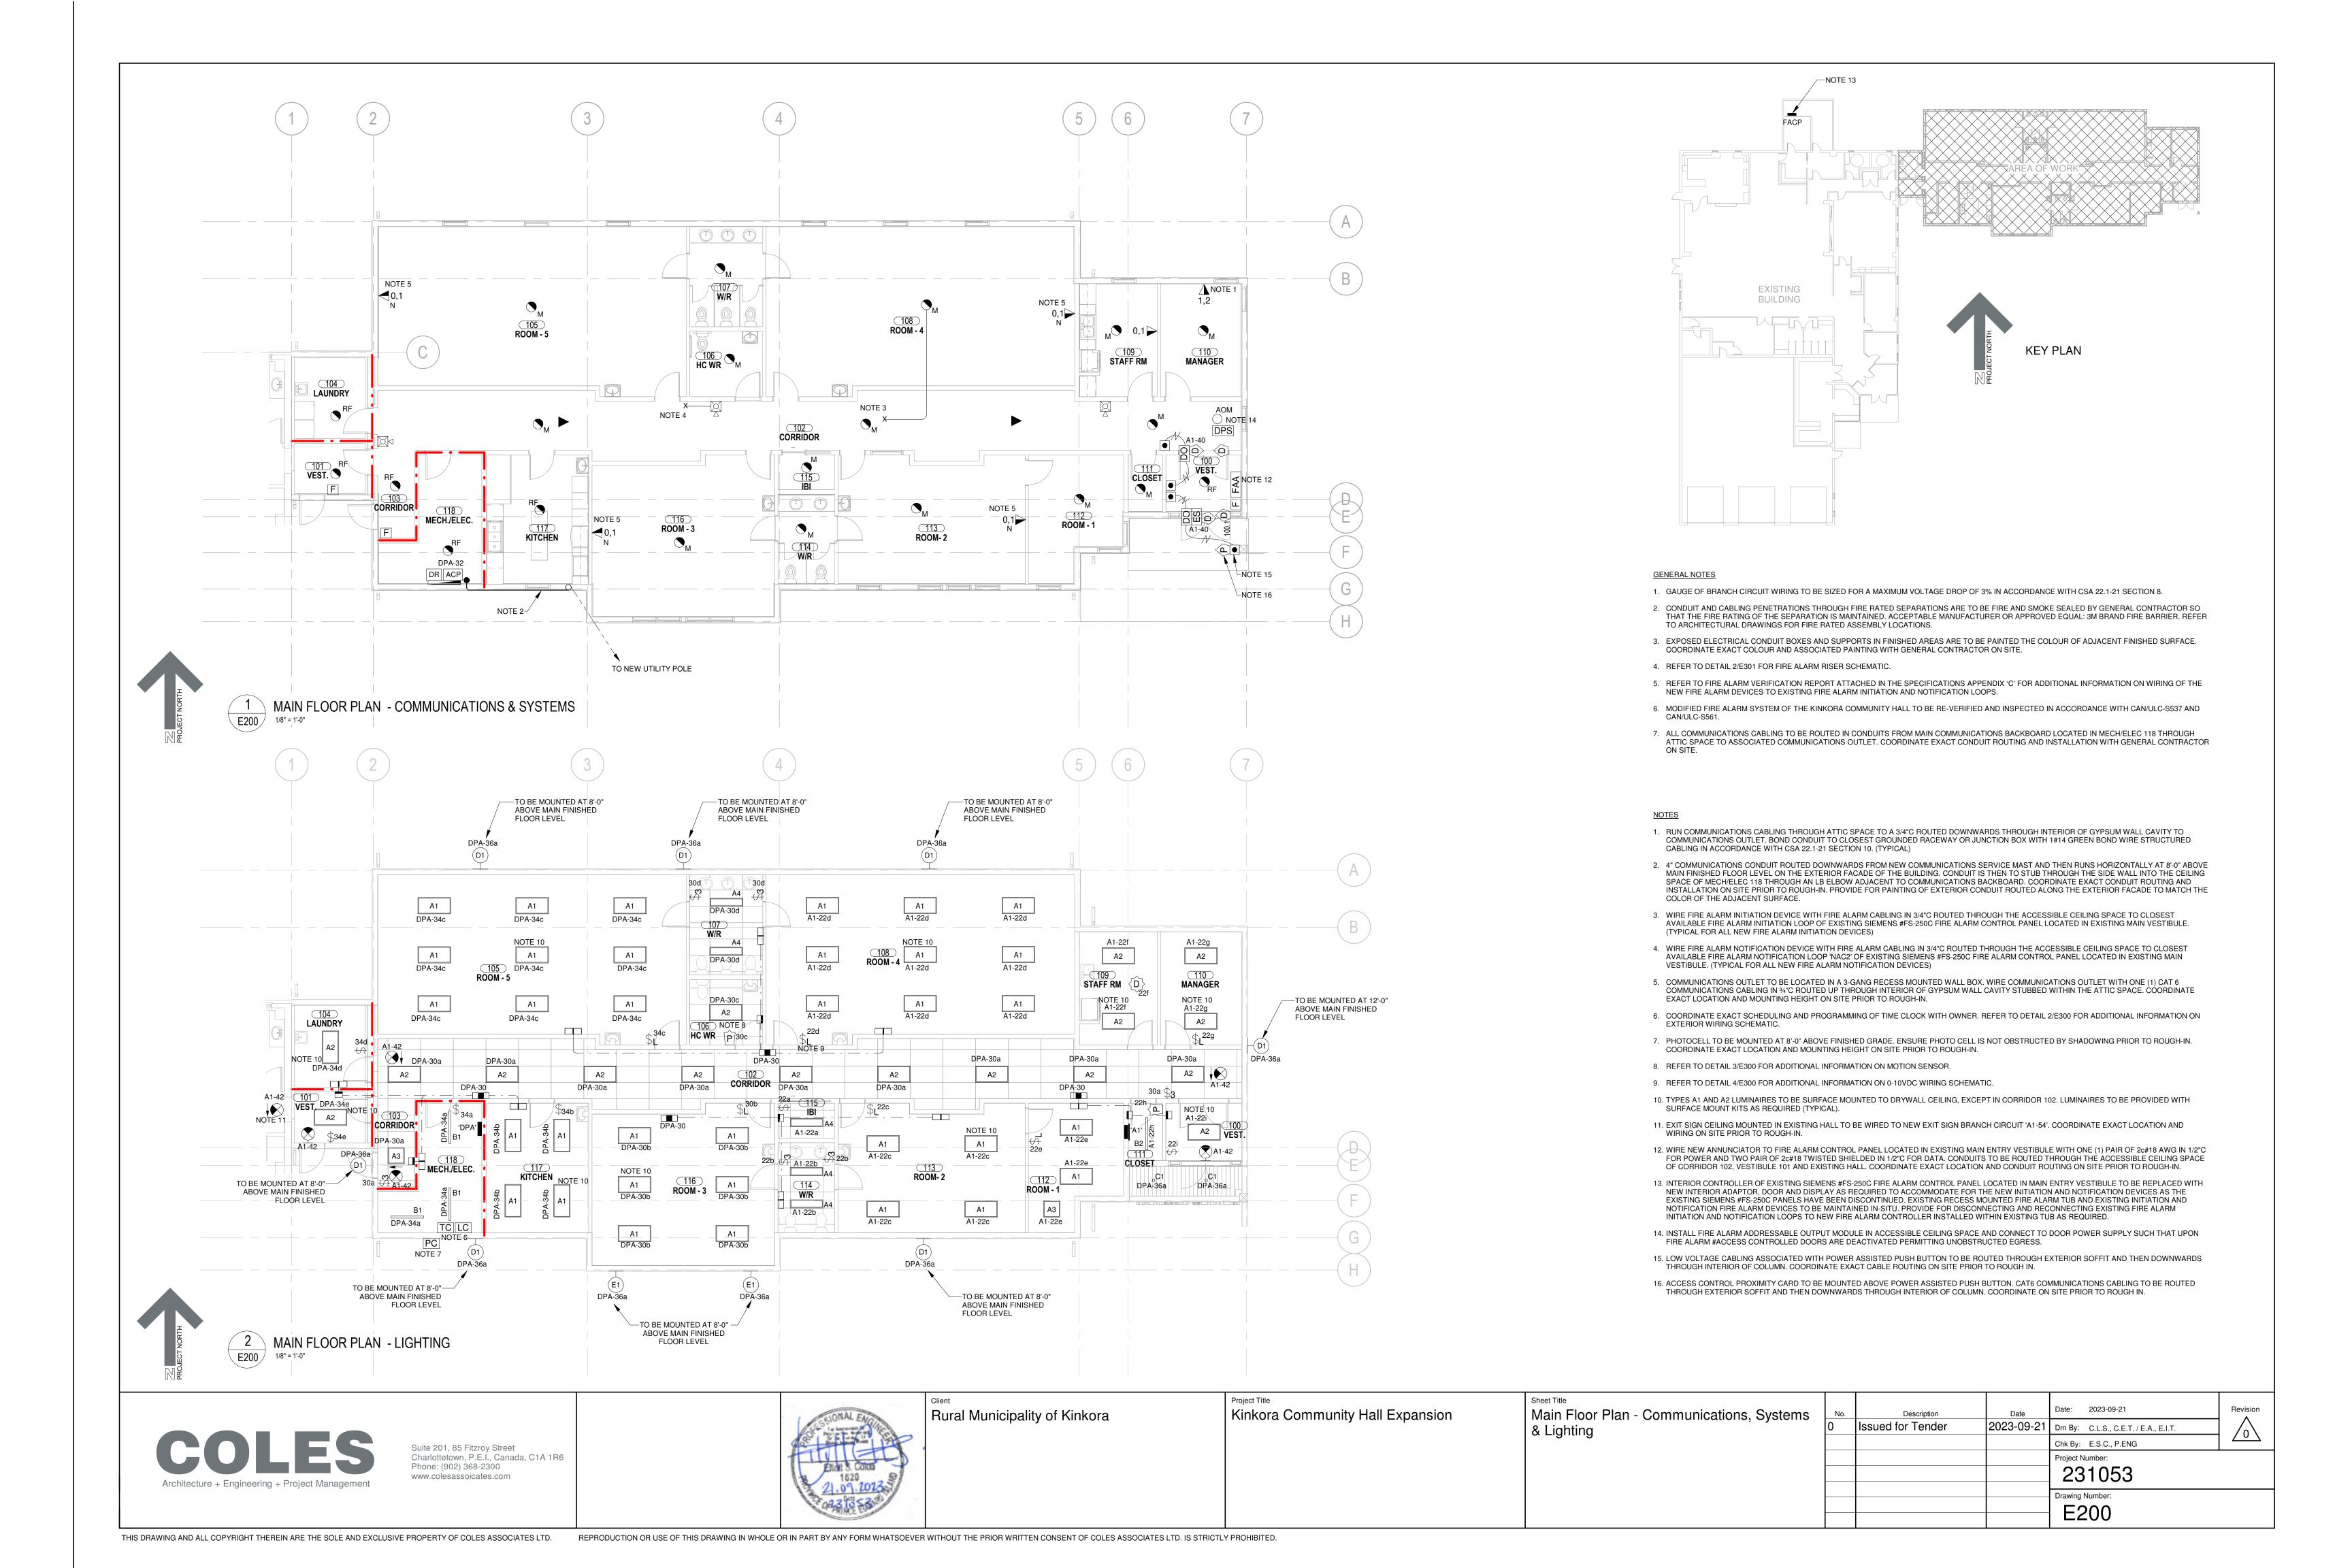


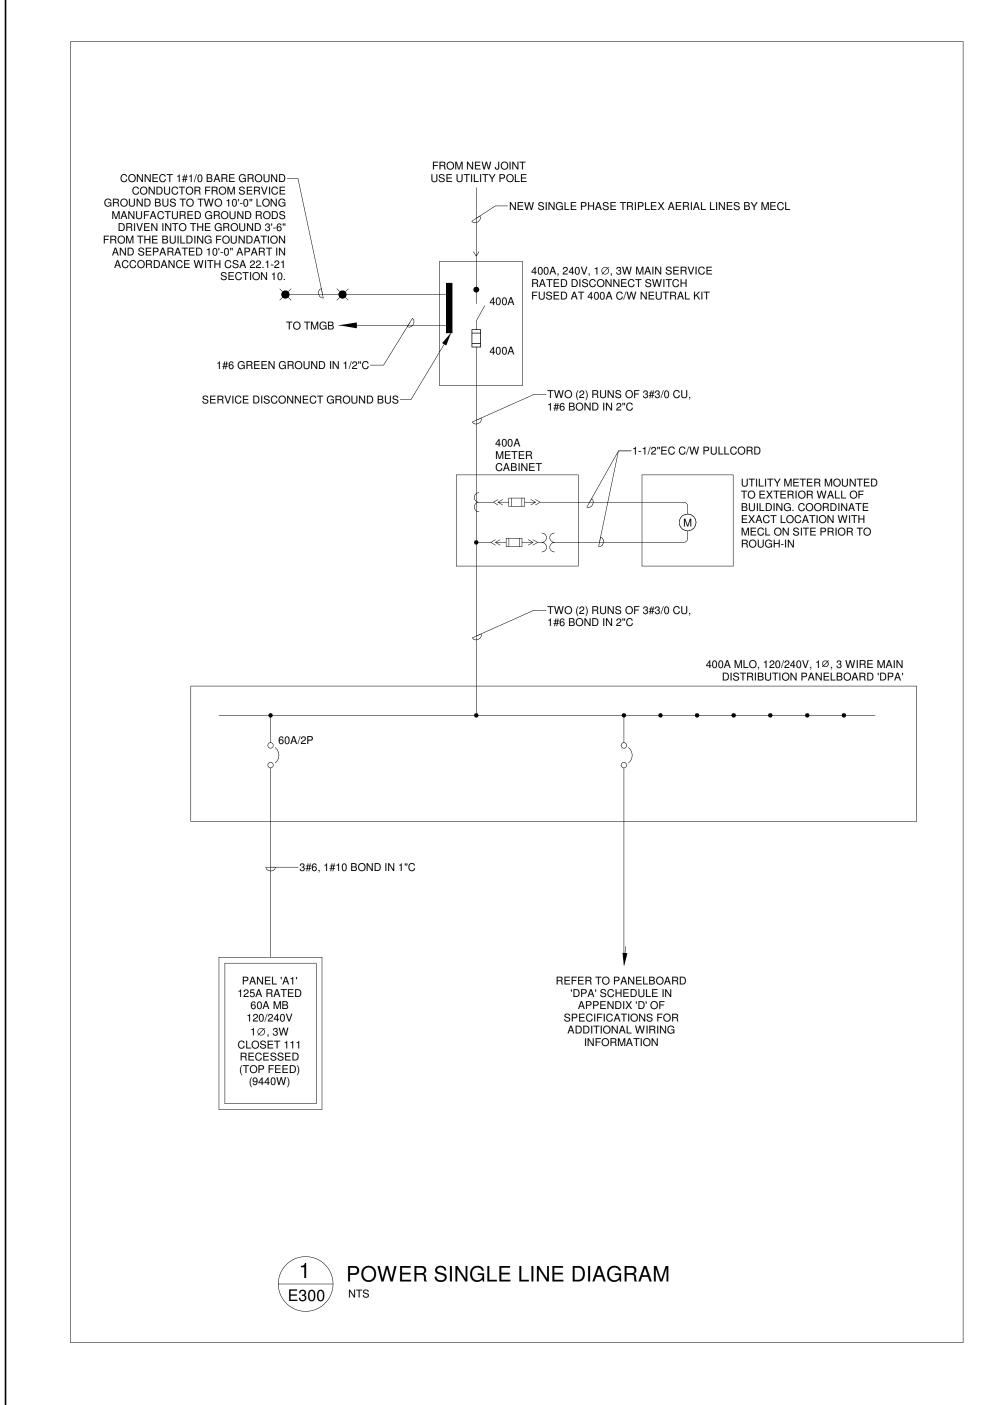

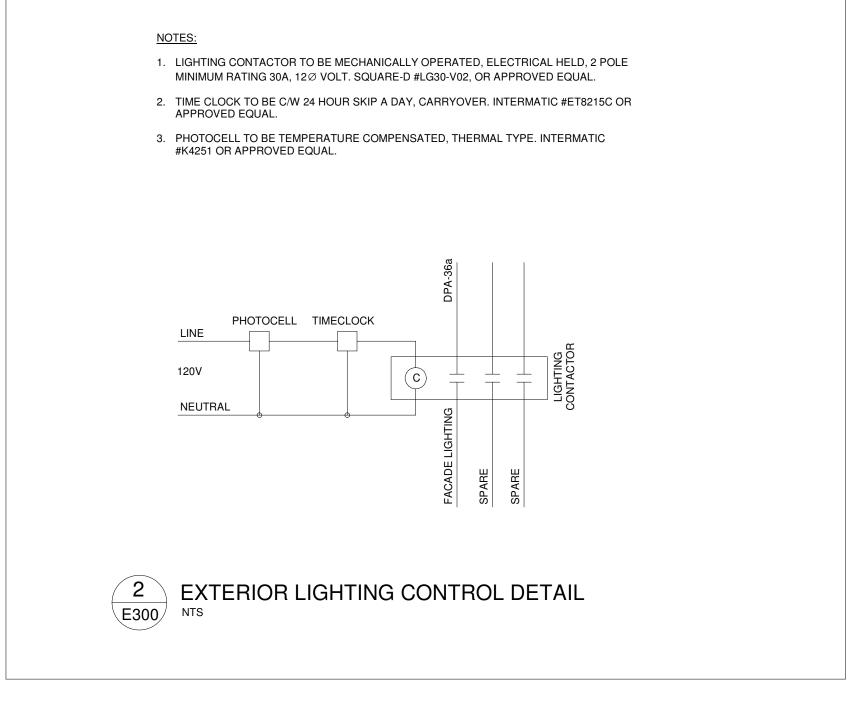

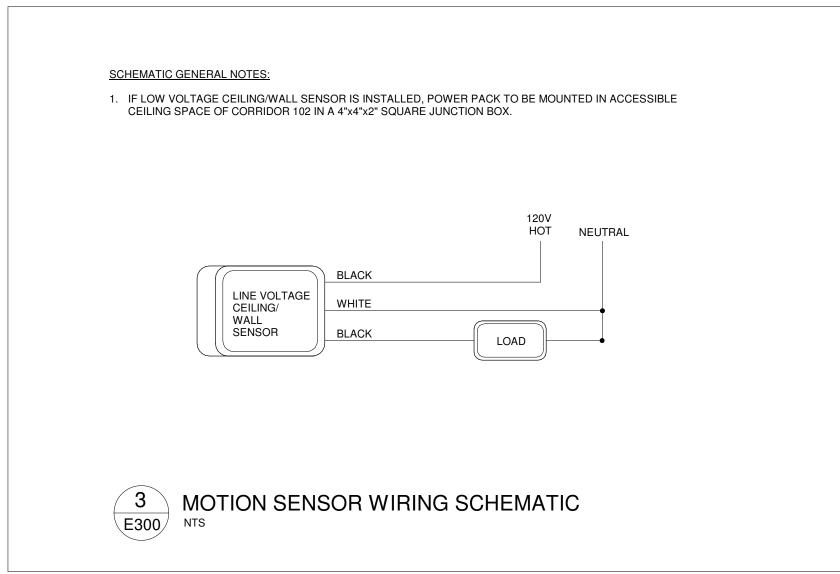

		DEMAND CALCULATION	1		
	BASIC LOAD CALCULA	TION - REFERENCING C	SA 22.1-21 AND	8-210 (a)	
		REFERENCING CSA 22	.1-21 TABLE 14		
DESIGNATION	AREA (m²)	TYPE OF OCCUPANCY	W/m²	DEMAND %	TOTAL DEMAND (W
MAIN FLOOR	437	OFFICE	50	90	19,665
SPECI	AL LOAD CALCULATION	N - REFERENCING CSA 2	2.1-18 8-210 (b)	, AND 62-118	3 (5)
DESIGN	TOTAL DEMAND (W				
MECHANICAL LO	ADS (HRV-1, P-1)	1,800		75	1,350
HEATING LOADS (BB'	S, HC'S, OU'S & IU'S)	59,170		75	44,378
KITCHEN E	QUIPMENT	14,000		50	7,000
	TOTAL DEMAND CALC	CULATION - REFERENCIN	IG CSA 22.1-21	8-210 (b)	
			TOTAL BASIC D	EMAND (W)	19,665
	52,728				
		ТОТ	AL ELECTRIC D	EMAND (W)	72,393
	MINIM	UM SERVICE ENTRANCE	E AT 240V, 1 PH	ASE (x 1.25)	377A
		TICLE 8-106(4) DEMAND		ARE BASED	ON WINTER TIME

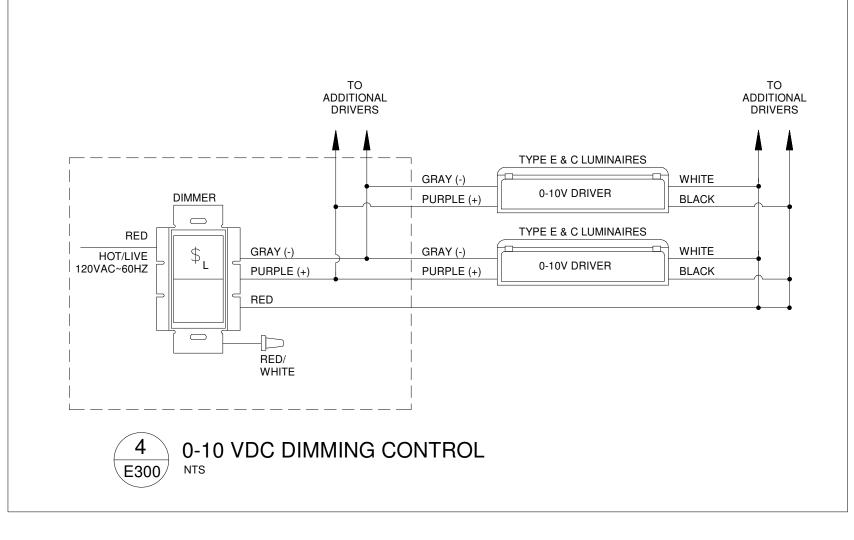

	MECHANICAL EQUIPMENT SCHEDULE SYSTEM											
TYPE LOCATION	DESCRIPTION	VOLTS	PHASE			AMPS	REMARKS					
					KW	HP						
HC-1	MECH/ELEC 118	HRV-1 SUPPLY DUCT	240	1	10.7	-	-	SUPPLY AND INSTALL LOCAL CSA TYPE 1 60A, 240V, SINGLE PHASE UNFUSED DISCONECT SWITCH AND WIRE TO 'HC-1' THROUGH ITS TERMINAL BLOCK WITH 2#6, 1#8 BOND IN 1"C. COORDINATE EXACT LOCATION WITH MECHANICAL CONTRACTOR ON SITE PRIOR TO ROUGH-IN.				
HC-2	MECH/ELEC 118	IU-1 SUPPLY DUCT	240	1	15	-	-	SUPPLY AND INSTALL LOCAL CSA TYPE 1 100A, 240V, SINGLE PHASE UNFUSED DISCONECT SWITCH AND WII 'HC-2'/'HC-3' THROUGH ITS TERMINAL BLOCK WITH 2#4, 1#8 BOND IN 1-1/4"C. COORDINATE EXACT LOCATION MECHANICAL CONTRACTOR ON SITE PRIOR TO ROUGH-IN.				
HC-3	MECH/ELEC 118	IU-2 SUPPLY DUCT	240	1	15	-	-					
HRV-1	MECH/ELEC 118	HEAT RECOVERY VENTILATOR	240	1	1.34	-	13.75 (MCA) 15 (MOCP)	SUPPLY AND INSTALL LOCAL CSA TYPE 1 15A, 240V, SINGLE PHASE UNFUSED DISCONECT SWITCH AND WIRE TO 'HRV-1' WITH 2#12, 1#14 BOND IN 3/4"C. COORDINATE EXACT LOCATION WITH MECHANICAL CONTRACTOR ON SITPRIOR TO ROUGH-IN.				
IU-1	MECH/ELEC 118	INDOOR UNIT	240	1	0.876	-	15 (MOCP)	INDOOR UNIT WITH 2#12, 1#14 BOND IN 3/4"C. ALL CONTROLS WIRING TO OUTDOOR CONDENSING UNIT TO COMPLETED BY OTHERS AND ALL POWER WIRING TO BE COMPLETED BY DIV.26. COORDINATE EXACT LOW				
IU-2	MECH/ELEC 118	INDOOR UNIT	240	1	0.876	-	15 (MOCP)					
OU-1A	OUTDOOR	OUTDOOR CONDENSING UNIT	240	1	-	-	28.1 (MCA) 35 (MOCP)	TECK CABLES TO CSA TYPE 3R UNFUSED DISCONNECT SWITCH ADJACENT TO MECHANICAL LINES. ALL C — CABLING BETWEEN INDOOR AND OUTDOOR UNIT TO BE SUPPLIED AND INSTALLED BY OTHERS AND ALL F WIRED TO BE COMPLETED BY DIV.26. COORDINATE EXACT LOCATION OF CSA TYPE 3R UNFUSED DISCON SWITCH OUTDOOR CONDENSING UNIT AND INTERIOR UNITS ON SITE PRIOR TO BOUGHJIN, SEAL EXTERIOR				
OU-1B	OUTDOOR	OUTDOOR CONDENSING UNIT	240	1	-	-	29.1 (MCA) 35 (MOCP)					
P-1	MECH/ELEC 118	RECIRC PUMP	120	1	0.1	-	-	SUPPLY AND INSTALL LOCAL MANUAL MOTOR SWITCH AND WIRE TO PUMP 'P-1' WITH 2#12, 1#14 BOND IN 3/4"C. COORDINATE EXACT LOCATION WITH MECHANICAL CONTRACTOR ON SITE PRIOR TO ROUGH-IN.				

	HEATER SCHEDULE									
TYPE	TYPE LOCATION	DESCRIPTION	VOLTE	PHASE -	RATED		REMARKS			
1175	LOCATION		VOLIS	FIIAGE	KW	HP				
BB-1	LAUNDRY ROOM 104	ELECTRIC BASEBOARD HEATER	240	1	0.75	-				
BB-2	STAFF ROOM 109	ELECTRIC BASEBOARD HEATER	240	1	0.5	-	ELECTRIC BASEBOARD HEATER TO BE WIRED THROUGH LINE VOLTAGE THERMOSTAT WITH 2#12, 1#14 BOND IN 3/4"C ROUTED THROUGH THE ATTIC SPACE AND THEN DOWNWARDS THROUGH THE INTERIOR OF GYPSUM WALL CAVITY. ELECTRIC BASEBOARD HEATER AND LINE VOLTAGE THERMOSTAT TO BE SUPPLIED AND INSTALLED BY DIV.23 AND WIRED BY DIV.26. COORDINATE EXACT LOCATION WITH MECHANICAL CONTRACTOR ON SITE PRIOR TO ROUGH-IN.			
BB-3	OFFICE 110	ELECTRIC BASEBOARD HEATER	240	1	0.5	-				
WF-1	VESTIBULE 101	WALL FAN HEATER	240	1	0.5	-	WALL FAN HEATER TO BE RECESS MOUNTED AND WIRED WITH 2#12, 1#14 BOND IN 3/4"C ROUTED THROUGH THE ATTIC SPACE AND THEN DOWNWARDS THROUGH INTERIOR OF GYPSUM WALL CAVITY. ALL CONTROLS WIRING TO BE COMPLETED			
WF-2	VESTIBULE 100	WALL FAN HEATER	240	1	0.5	-	BY OTHER. WALL FAN HEATER TO BE SUPPLIED AND INSTALLED BY DIV.23, WIRED BY DIV.26. COORDINATE EXACT LOCATI AND MOUNTING HEIGHT WITH MECHANICAL CONTRACTOR ON HEIGHT PRIOR TO ROUGH-IN.			

Architecture + Engineering + Project Management

Suite 201, 85 Fitzroy Street Charlottetown, P.E.I., Canada, C1A 1R6 Phone: (902) 368-2300 www.colesassoicates.com



Rural Municipality of Kinkora

Kinkora Community Hall Expansion

Details & Schedules


 No.
 Description
 Date
 2023-09-21
 Revision


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 Drn By: C.L.S., C.E.T. / E.A., E.I.T.
 Chk By: E.S.C., P.ENG


 Project Number:

 231053

 Drawing Number:
 E300

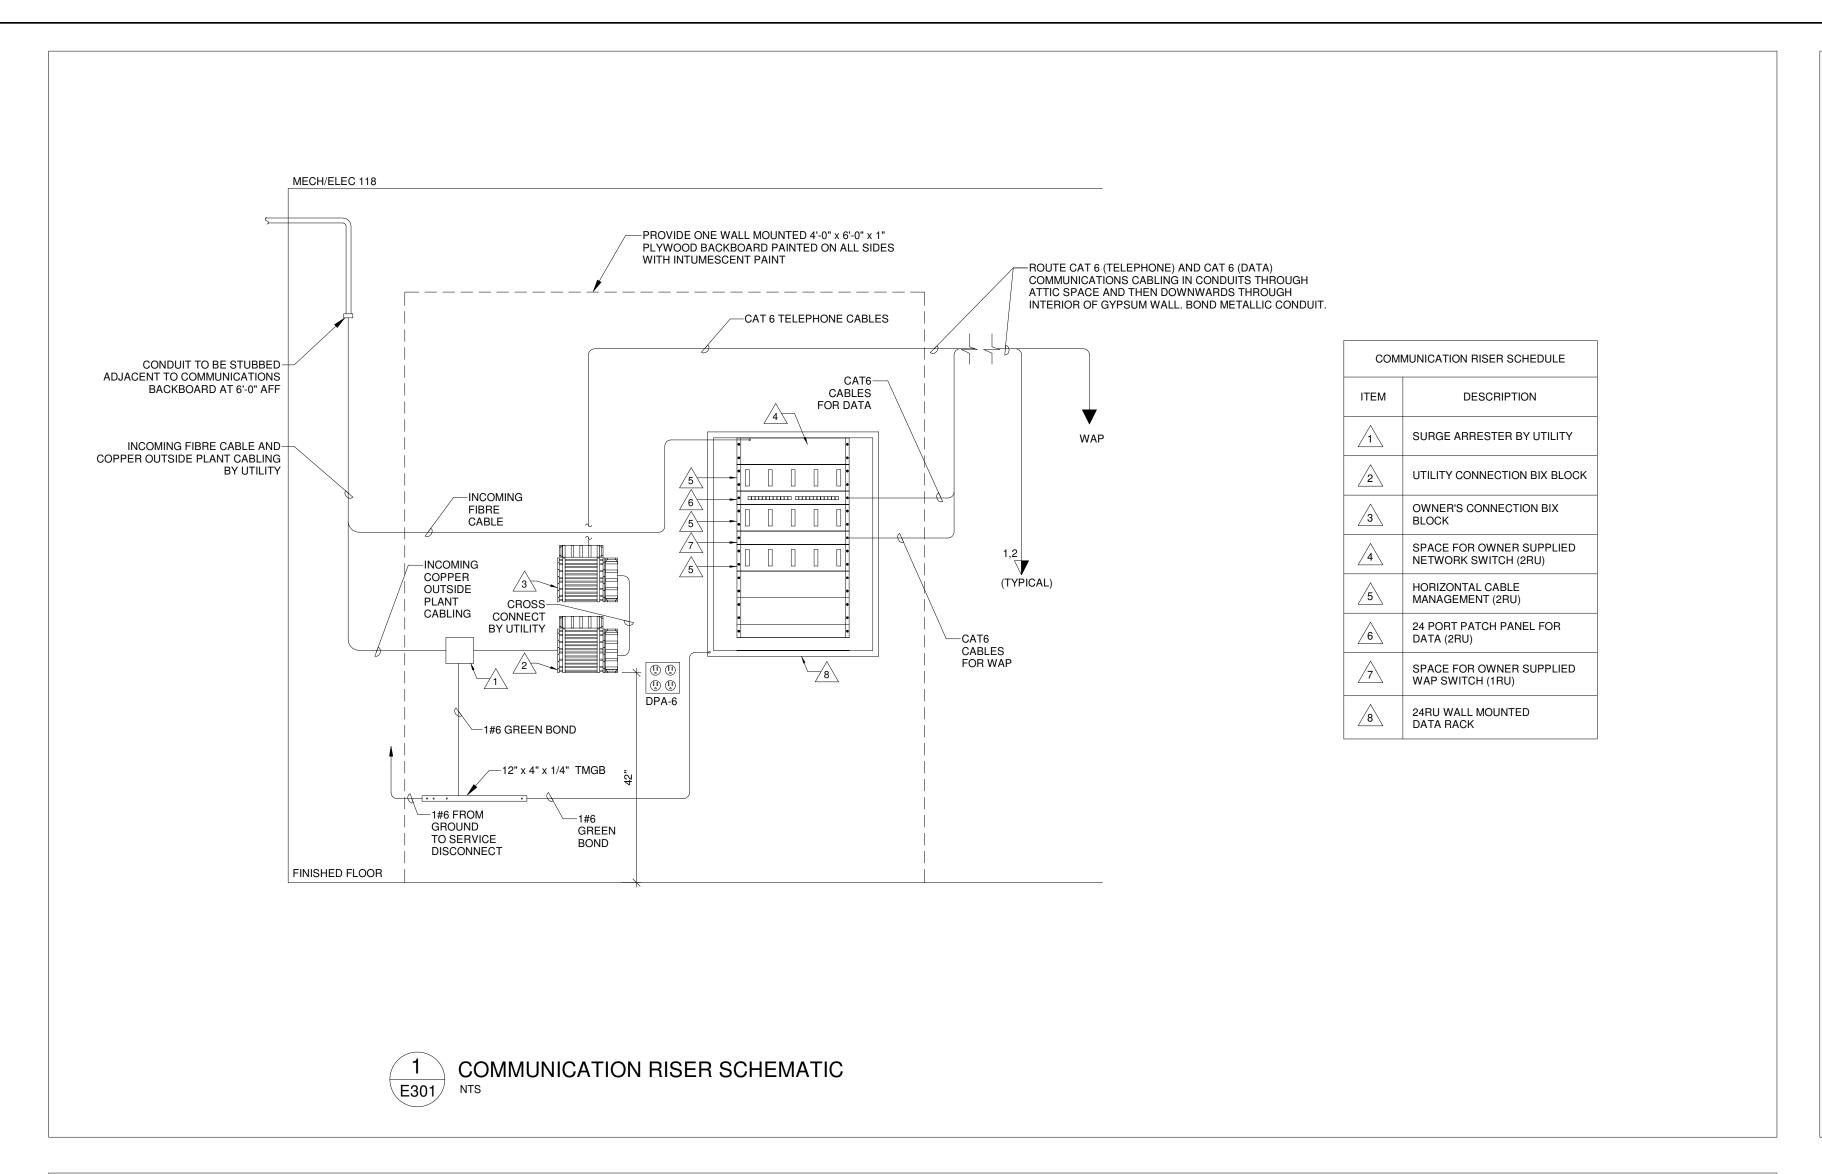

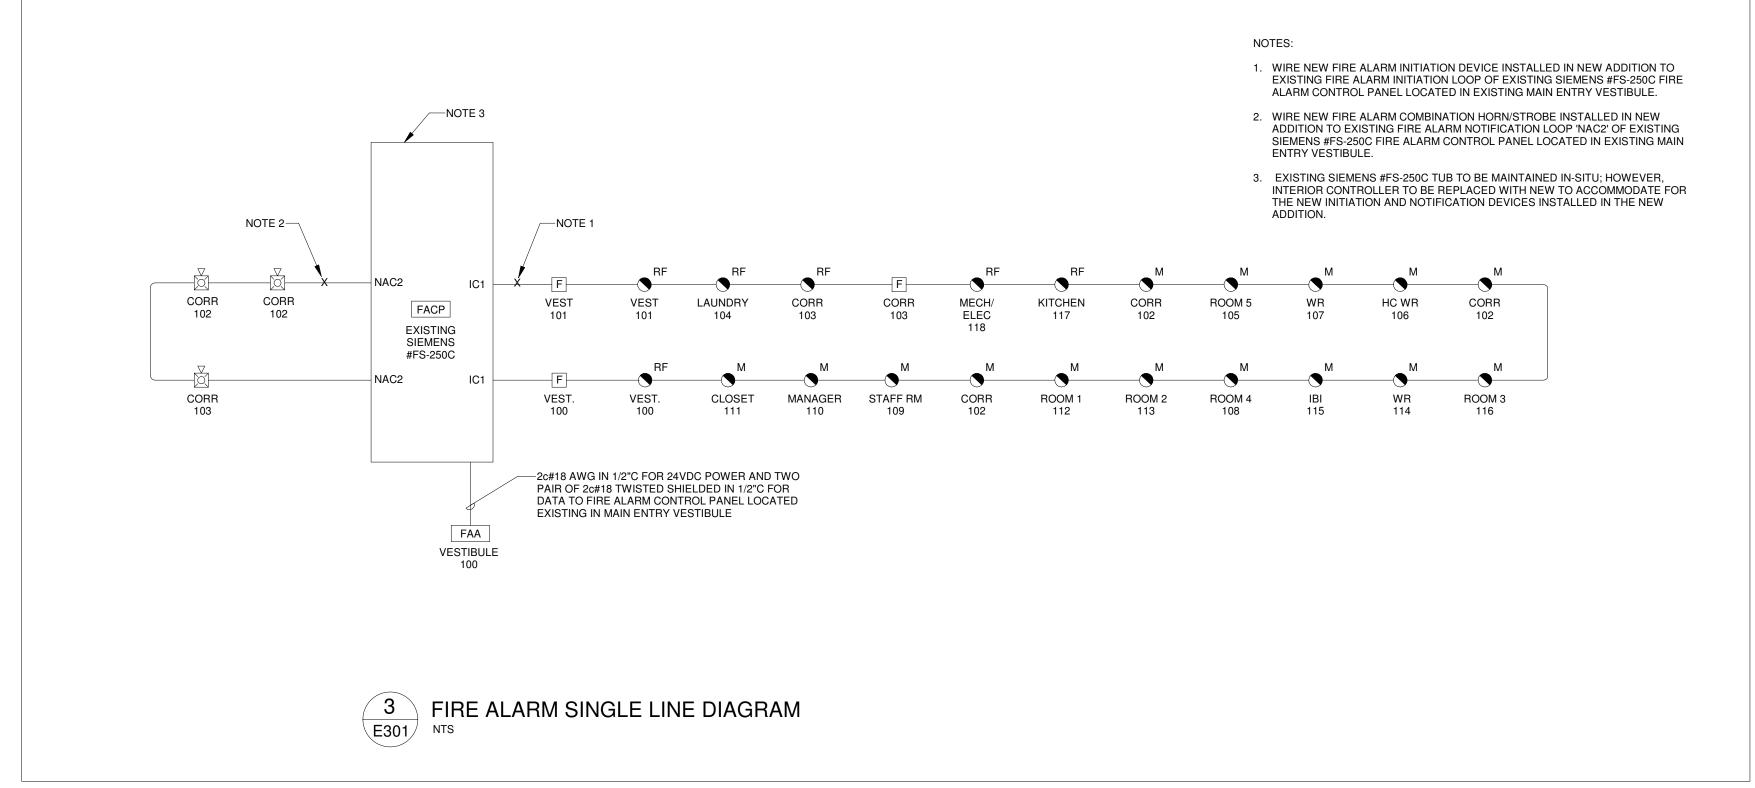

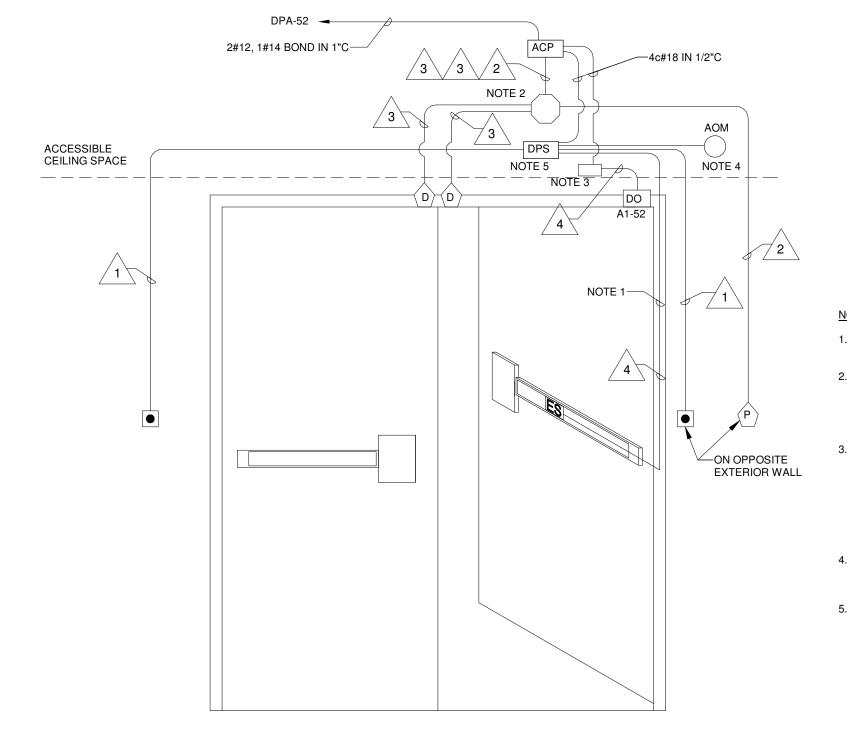


ACCESS CONTROL WIRING SCHEDULE												
ITEM	WIRE DESCRIPTION	SUPPLIED BY	PART#									
1	2c#18 AWG	DIV. 28	PROVO #9182 OR EQUAL									
2	6c#22 AWG SHIELDED	DIV. 28	PROVO #6706 OR EQUAL									
3	4c#22 AWG	DIV. 28	PROVO #Z222 OR EQUAL									
4	6c#18 AWG	DIV. 28	PROVO #9185 OR EQUAL									


NOTES:

- 1. CONCEAL ACCESS CONTROL WIRING IN DOOR FRAME. COORDINATE INSTALLATION WITH DIV. 8 ON SITE. (TYPICAL)
- 2. CABLES TO BE RUN CONTINUOUS WITHOUT SPLICE BETWEEN ACCESS CONTROL DOOR CONTROL PANEL. IF SPLICING IS REQUIRED IT IS TO BE COMPLETED ON NUMBERED TERMINAL STRIPS WITHIN AN ELECTRICAL JUNCTION BOX. SPLICING OF ACCESS CONTROL CABLING USING MARRETTES IS NOT PERMITTED. (TYPICAL).
- 3. WIRE POWER ASSISTED DOOR OPERATOR THROUGH FAIL SAFE DOOR CONTROLLER RELAY CAMDEN #CX-33 OR APPROVED EQUAL LOCATED IN A 100mm x 100mm JUNCTION BOX IN ACCESSIBLE CEILING SPACE AND PROGRAM DOOR CONTROLLER SUCH THAT PUSHBUTTONS ARE DISABLED WHEN DOOR IS LOCKED. WIRE DOOR CONTROLLER RELAY WITH 4c#18 TO ACCESS CONTROL PANEL. COORDINATE EXACT PROGRAMMING OF DOOR CONTROLLER RELAY WITH OWNER.
- 4. CONNECT FIRE ALARM ADDRESSABLE OUTPUT MODULE TO DOOR HARDWARE POWER SUPPLY AND PROGRAM TO UNLOCK ALL ACCESS CONTROLLED DOORS IN THE EVENT OF A FIRE ALARM.
- 5. WIRE POWER ASSISTED PUSH BUTTONS AND ELECTRIC STRIKE TO DOOR HARDWARE POWER SUPPLY SUPPLIED AND INSTALLED BY DIV. 08 AND WIRED BY DIV. 28. DOOR HARDWARE POWER SUPPLY TO BE LOCATED IN A 100mm x 100mm JUNCTION BOX IN ACCESSIBLE CEILING ABOVE EACH ACCESS CONTROLLED DOOR. WIRE EACH DOOR HARDWARE POWER SUPPLY WITH 4c#18 TO ACCESS CONTROL PANEL. COORDINATE EXACT LOCATION OF DOOR HARDWARE POWER SUPPLY ON SITE.

THEORY OF OPERATION:

DOOR TO NORMALLY REMAIN LOCKED RESTRICTING ENTRY WHILE STILL PERMITTING UNOBSTRUCTED EGRESS UNTIL A VALID PROXIMITY CARD IS PRESENTED TO THE READER MOMENTARILY RETRACTING THE ELECTRIC STRIKE PERMITTING UNOBSTRUCTED ENTRY. WHEN ELECTRIC STRIKE IS ENGAGED EXTERIOR BARRIER FREE PUSHBUTTON WILL NOT ACTIVATE MOTORIZED DOOR OPERATOR. INSTALL CAMDEN #CX-33 PROGRAMMABLE LOGIC RELAY AS REQUIRED TO PROVIDE SCHEDULING AND SHUNT OF DOOR OPERATOR. DOOR CONTACT TO MONITOR POSITION OF DOOR AND ALARM IF LEFT OPEN. OWNER TO IDENTIFY DURING THE PROGRAMMING AND COMMISSIONING OF THE ACCESS CONTROL SYSTEM, THE PROXIMITY CARDS THAT ARE REQUIRED TO BE PROGRAMMED TO BE ABLE TO UNLOCK DOOR 100.1 DURING A CERTAIN TIME FRAME OF THE DAY AND WEEK.

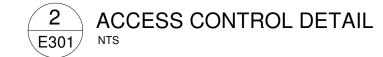

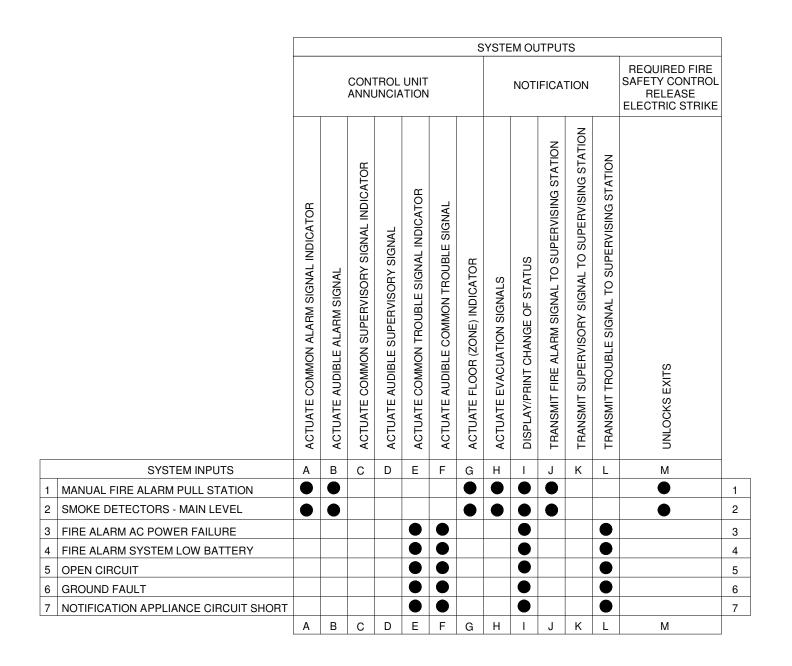

FIRE ALARM I/O MATRIX



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Rural Municipality of Kinkora

Kinkora Community Hall Expansion

Communications, Access Control & Fire Alarm Details

Date: 2023-09-21

Issued for Tender

Date: 2023-09-21

Drn By: C.L.S., C.E.T. / E.A., E.I.T.

Chk By: E.S.C., P.ENG

Project Number:

231053

Drawing Number:

E301